

DEPARTMENT OF PLANNING AND COMMUNITY DEVELOPMENT

ACTION DATE:

March 7, 2013

TO:

Planning Commission

APPLICANT:

SAC Wireless for Sprint Nextel Inc.

5865 Avenida Encinas Carlsbad, CA 92008

CASE NO .:

12-CUP-001

LOCATION:

28030 Dorothy Drive (A.P.N. 2061-013-037)

REQUEST:

Request for approval of a Conditional Use Permit to replace four (4) wall-mounted, wireless telecommunications facility panel antennas with three (3) new panel antennas and replace three (3) existing roof-mounted cabinets with three (3) new cabinets and new accessory equipment on an office building.

ENVIRONMENTAL

DETERMINATION:

Categorically Exempt under CEQA per Section 15303 and independently, exempt pursuant to the general rule in Section

15061(b)(3).

RECOMMENDATION:

Staff recommends the Planning Commission approve Wireless Telecommunications Facilities/Conditional Use Permit Case No. 12-CUP-001, subject to conditions, based on findings in the Draft Resolution.

ZONING DESIGNATION:

Business Park- Office/Retail- Freeway Corridor (BP-OR-FC)

GENERAL PLAN

DESIGNATION:

BP-OR Business Park - Office Retail

I. PROJECT BACKGROUND AND DESCRIPTION

SAC Wireless, an authorized representative for Sprint Nextel, Inc., has applied for a Wireless Telecommunications Facilities Permit/Conditional Use Permit to replace the antennas of a wireless telecommunications facility at an office building located at 28030 Dorothy Drive. The three-story office building is located east of Palo Comado Canyon Drive, amongst other office buildings. The site is zoned Business Park-Office/Retail, and is located about 350 feet from the

nearest residential use south of Agoura Road. Over the years, the City has approved three applications and modifications at this location and others in the vicinity. The cases approved for this building allowed roof-mounted and wall-mounted antennas, and equipment on top and inside of the building, as well as on the ground floor. The previous projects were submitted by LA Cellular under Case No. 95-CUP-005, Cox California PCS under Case No. 96-CUP-013, and Nextel under Case No. 00-CUP-013. Today, the providers are known as AT&T, T-Mobile and Sprint Nextel, respectively. More recently in 2012, AT&T received a Planning Commission approval (Case No. 12-CUP-001) to upgrade the technology of the facility for eight (8) antennas in the same location of the office building plus four (4) additional antennas as well as equipment upgrades.

The applicant, a Sprint representative, proposes to replace four (4) wall-mounted, panel antennas with three (3) new panel antennas and replace three (3) existing roof-mounted cabinets with three (3) new cabinets and new accessory equipment. The antennas will be installed similar to how they currently are, in two groupings although oriented into three sectors (separate locations on the building, each with a directional antenna situated toward a specific coverage area) of emission, one at the northeast and the other at the southwest corners of the building. In both installations, the antennas would be screened with a radio frequency (RF) emission-transparent material similar to the stuccoed wall the antennas would be attached to. The equipment is roof-mounted and the additional accessory equipment would be mounted on the interior side of the parapet wall.

II. STAFF ANALYSIS

The new Wireless Telecommunications Facilities (WTF) Ordinance, adopted in September 2011, establishes allowed zones for wireless telecommunications facilities, and establishes new processes and submittal requirements. In particular, the Ordinance provides standards for the appearance of the facilities and requires the facilities to be camouflaged. The review process consists of three tiers. Tier I can be approved by the Director of the Planning and Community Development Department, and consists of certain types of facilities in the Business Park-Manufacturing zone only. Tier II includes most other wireless facilities and locations, and requires a Conditional Use Permit or an Amendment to an existing Conditional Use Permit, and is subject to the Planning Commission's review and approval. Finally, Tier III requires Planning Commission approval, and includes the projects that require an Exception to the provisions of the Ordinance (e.g. dimensions, design characteristics).

Per the Ordinance, this application falls under the Tier II review process, which requires a new Conditional Use permit subject to the Planning Commission's approval.

The primary function of the existing three-story building is general office use. The applicant is proposing to attach wireless telecommunications facilities to the walls of the building in order to serve three sectors and place the ancillary equipment in proximity to the antennas and on the roof. One important requirement of the Ordinance that was considered when reviewing this application was the need to camouflage the antennas. The applicant worked with staff to adequately screen the antennas so they appear as part of the building's structure.

Currently, the facility consists of four (4) antennas attached to the exterior of the building on two sides, each antenna installed eight (8) and four (4) feet apart from each other. The antennas are

visible from the outside. Replacing them using the same installation methods would not comply with Section 9661.5.B. of the Ordinance (Design and Development Standards), as they would not be camouflaged. The applicant proposes to replace the four antennas with only three (3) new antennas 72 inches high. The existing antennas would be removed altogether. The antennas would be in the same general locations as currently existing. Sector B, at the northeast corner of the building, would be served by one antenna and Sectors A and C, at the southeast corner, would be served by one antenna each. In order to comply with Section 9661.5.B., an RF emission-transparent material is proposed as a camouflaging solution. The screening material would be textured and painted to match the existing finish. The screen would be seven and a half feet tall and would wrap around the southwest corner of the building to conceal the antenna on the corner.

Both locations also use a remote radio head unit to extend the coverage of the BTS cabinet which is connected via a fiber optic cable. These units are installed behind the parapet wall. The new equipment would be mounted on the roof in an area that is not accessible to the public or visible from the street.

The following paragraphs describe the project's consistency with the design and development standards of the Ordinance (Section 9661.5(B)).

The Ordinance requires screening and camouflaging techniques in the placement of wireless telecommunications facilities to ensure the facilities are as visually inconspicuous as possible. In screening, the design must match the color, texture, materials, quality and style of the existing building so as to conceal the facility from surrounding properties and achieve community compatibility. As described above, the facilities in each of the three sectors would be adequately screened by a box painted and textured to resemble the existing building façade. The equipment would be placed on top of the roof behind a parapet wall which is consistent with the Ordinance. The proposal meets the intent to eliminate the visual impact of the new antennas as shown in the photo-simulations submitted by the applicant (Exhibit C).

The Ordinance also requires that the existing vegetation and buildings provide the greatest amount of screening to minimize potential visual impacts. The existing vegetation is not sufficient to screen the proposed facilities, but the building screen box completely shields the facilities from view, and the materials and colors of the shielding blend well with the existing architectural theme of the building, or will be made integral to the structure of the building itself. While not necessary for screening purposes, the existing vegetation in the planters surrounding the building would be retained (see Exhibit D).

The applicant states that the new facility would not generate noise that could potentially impact the public outside and the work environment inside the building. No backup generator is proposed. The project is conditioned not to be audible at the property line of any residential property and also not to exceed an exterior noise level of fifty-five (55) dBA at the facility's property line. Based on the information provided, the project is consistent with Section 9661.5(B)(11) of the Ordinance.

Conditional Use Permit Findings:

In order for a Conditional Use Permit to be approved, the applicant must demonstrate compliance with all six of the Conditional Use Permit findings as well as all four wireless telecommunications facilities specific findings specified in the Zoning Ordinance in Section 9673.2.E and 9661.5 (12)(c).

- 1. The Planning Commission must find that the proposed use is consistent with the objectives of the Zoning Ordinance and the purposes of the district in which the use is located. Wireless telecommunications facilities are allowed in the Business Park-Office/Retail zone, subject to the issuance of a Conditional Use Permit. The wall-mounted antennas will be completely screened with a material stuccoed and painted to match the color of the building. The addition of the screen box to the façade will not create a visual distraction or block views along the freeway.
- 2. Another finding that the Planning Commission must make is that the proposed use is compatible with the surrounding properties. The Ordinance allows such facilities in the BP-OR zone. The proposed antennas would not impact the surrounding community in that they are camouflaged from view and the equipment is not visible from the outside. The antennas will not interfere with any of the existing businesses on or around the proposed site.
- 3. The Planning Commission must also find the proposed use and the conditions under which it would be operated or maintained will not be detrimental to the public health, safety or welfare. Wireless telecommunications facilities must be built in compliance with the City's Building Code, and are subject to inspection by the City's Building Department to ensure they are constructed in a safe manner. The Federal Communication Commission (FCC) regulates wireless telecommunications facilities, with regards to other related health and safety issues, particularly RF emissions, and establishes thresholds of RF emissions beyond which a facility cannot exceed. As part of the conditions of approval, and pursuant to the Ordinance, the applicant would be required to demonstrate continued compliance with the FCC emission standards.
- 4. Another finding is that the proposed use will comply with each of the applicable provisions of the Zoning Ordinance. Wireless telecommunications facilities are allowed in the BP-OR-FC zone, subject to the issuance of a Conditional Use Permit. The facilities are designed and located in compliance with the Zoning Ordinance, and with the conditions of approval imposed, will comply with the applicable provisions of the Ordinance.
- 5. A finding must also be made that the distance from other similar and like uses is sufficient to maintain the diversity within the community. The building hosts two other providers with wall-mounted antennas. One provider has received an approval to screen the antennas and is in the process of preparing construction plans. The third provider has not yet requested to upgrade the facility therefore the antennas are visible from the parking lot. The concentration of providers on Dorothy Drive is possibly a result of the previous zoning ordinance requirements, which prohibited facilities west of Palo Comado Canyon Drive in the BP-OR zone, and the only other permitted zone for wireless

facilities was BP-M. The interest from property owners may also have been a factor. The proximity of the buildings to the freeway and the elevation of the building pads, minimizing obstacles to wave transmission, provide a suitable environment for wireless telecommunications facilities. Over the years, other facilities have been approved on office buildings in the vicinity of the proposed location, but with the proposed design, the wireless telecommunications facilities would remain invisible to public view and would not contribute to visual over-concentration of similar uses.

- 6. Finally, a finding must be made that the proposed use is consistent with the goals and policies of the General Plan with respect to wireless telecommunication facilities. The applicable goals and policies of the General Plan are listed below:
 - Goal U-6: <u>Telecommunication System</u>. Quality communication systems that meet the demands of new and existing developments in the City.

The project will provide quality communications systems to meet the demands of new and existing developments in the City by upgrading the technology of the existing facility. The upgrade serves to bring contemporary services such as 4G and LTE (Long Term Evolution) to the community, while decreasing the overall number of Sprint antennas at this location.

Policy U-6.1: Access and Availability. Work with service providers to ensure access to and availability of a wide range of state-of-the-art telecommunications systems and services for households, businesses and institutions throughout the City.

The project will provide state-of-the art wireless telecommunication services. The project will provide Sprint 4G or LTE coverage to the community.

Policy U-6.2: <u>Design and Siting of Facilities</u>. Require that the installation of telecommunications infrastructure, such as cellular sites and towers, be designed in a manner to minimize visual impacts on the surrounding environment and neighborhood, and to be as unobtrusive as possible.

The proposed individual panel antennas will be completely camouflaged. Moreover, the accessory equipment will be on top of the roof behind a parapet wall.

Wireless Telecommunication Facilities Findings:

In addition to the Conditional Use Permit findings, the Planning Commission must make the following wireless telecommunications facilities findings per Section 9661.7 of the Ordinance:

1. The proposed facility has been designed and located in compliance with all applicable provisions of the Ordinance. The wireless use remains secondary to the main office use on this parcel and is permitted in this zone with a conditional use permit. It has been designed to effectively screen and camouflage the antennas. The associated equipment will be installed on the roof of the building and out of public view. Further, the applicant

has completed the supplemental application to the satisfaction of the Director of Planning and Community Development, which serves, in part, as compliance verification.

- 2. The proposed facility has been designed and located to achieve compatibility with the community. Wireless telecommunications facilities are being incorporated into an existing building, and adequately screened from the surrounding area.
- 3. The applicant has submitted a statement of its willingness to allow other carriers to collocate on the proposed wireless telecommunications facility wherever technically and economically feasible and where collocation would not harm community compatibility. The applicant shares the use of the building site with other providers. The project does not change this arrangement.
- 4. Noise generated by equipment will not be excessive, annoying, nor be detrimental to the public health, safety, and welfare, and will not exceed the standards set forth in the Ordinance. The project does not increase the overall number of antennas or equipment cabinets, and the applicant has certified that the project will not result in an increase of noise over current conditions. Further, the conditions of approval regulate permissible noise and provide a procedure for addressing potential noise effects.

Conditions of Approval specific to wireless telecommunications facilities, as outlined in the Ordinance, are included in the Draft Resolution and Conditions of Approval, and are attached to this report.

III. ENVIRONMENTAL REVIEW

The project is exempt under Section 15303 (Class 3) of the California Environment Quality Act. This class consists of the construction and location of limited numbers of new, small facilities or structures, or installation of small equipment into a structure. Additionally and independently, the Project is covered by the general rule that CEQA applies only to projects which have the potential for causing a significant effect on the environment. It can be seen with certainty that there is no possible significant effect directly related to the Project, therefore no further action is required under CEQA pursuant to Section 15061(b)(3) of the State CEQA Guidelines (14 CCR § 15061(b)(3)).

IV. RECOMMENDATION

Based on the above analysis, staff recommends approval of Conditional Use Permit Case No. 12-CUP-001, subject to the conditions of approval included in the attached Draft Resolution.

V. ATTACHMENTS

- Draft Resolution of Approval and Conditions of Approval
- Exhibit A: Vicinity/Zoning Map
- Exhibit B: Copy of Reduced Plans and Photo-simulations of the Proposed Facility
- Exhibit C: Photos of the Building, and Project Site

Case Planner: Valerie Darbouze, Associate Planner

DRAFT RESOLUTION NO.

A RESOLUTION OF THE PLANNING COMMISSION OF THE CITY OF AGOURA HILLS CONDITIONALLY APPROVING WIRELESS TELECOMMUNICATIONS FACILITIES CONDITIONAL USE PERMIT CASE NO. 12-CUP-001

THE PLANNING COMMISSION OF THE CITY OF AGOURA HILLS HEREBY FINDS, RESOLVES AND ORDERS AS FOLLOWS:

- Section 1. An application was duly filed by SAC Wireless for Sprint Nextel, Inc. with respect to the real property located 28030 Dorothy Drive (A.P.N. 2061-013-037) for a Wireless Telecommunications Facilities/Conditional Use Permit Permit to replace four (4) wall-mounted, wireless telecommunications facility panel antennas with three (3) new panel antennas and replace three (3) existing roof-mounted cabinets with three (3) new cabinets and new accessory equipment on an office building.
- Section 2. The Planning Commission of the City of Agoura Hills considered the application at a public hearing held on March 7, 2013, at 6:30 p.m. in the Council Chambers, City Hall at 30001 Ladyface Court, Agoura Hills, California. Notice of the time, date and place and purpose of the aforesaid was duly given.
- <u>Section 3.</u> Evidence, both written and oral, including the staff report and supporting documentation, was presented to and considered by the Planning Commission at the aforesaid public hearing.
- <u>Section 4.</u> Pursuant to Section 9673.2.E. of the Agoura Hills Zoning Ordinance, and based upon the evidence presented at the hearing, including the staff report and oral and written testimony, the Planning Commission finds, that:
 - 1. The proposed use, as conditioned, is consistent with the objectives of the Zoning Ordinance and the purposes of the district in which the use is located. Wireless telecommunications facilities are allowed in the Business Park-Office/Retail zone, subject to the issuance of a Conditional Use Permit. The wall-mounted antennas will be completely screened with a material stuccoed and painted to match the color of the building. The addition of the screen box to the façade will not create a visual distraction or block views along the freeway.
 - 2. The proposed use is compatible with the surrounding properties. The Ordinance allows such facilities in the BP-OR zone. The proposed antennas would not impact the surrounding community in that they are camouflaged from view and the equipment is not visible from the outside. The antennas will not interfere with any of the existing businesses on or around the proposed site.
 - 3. The proposed use and the conditions under which it would be operated or maintained will not be detrimental to the public health, safety or welfare. Wireless telecommunications facilities must be built in compliance with the City's Building Code, and are subject to inspection by the City's Building Department to ensure

they are constructed in a safe manner. The Federal Communication Commission (FCC) regulates wireless telecommunications facilities, with regards to other related health and safety issues, particularly RF emissions, and establishes thresholds of RF emissions beyond which a facility cannot exceed. As part of the conditions of approval, and pursuant to the Ordinance, the applicant would be required to demonstrate continued compliance with the FCC emission standards.

- 4. The proposed use will comply with each of the applicable provisions of the Zoning Ordinance. Wireless telecommunications facilities are allowed in the BP-OR-FC zone, subject to the issuance of a Conditional Use Permit. The facilities are designed and located in compliance with the Zoning Ordinance, and with the conditions of approval imposed, will comply with the applicable provisions of the Ordinance.
- 5. The distance from other similar and like uses is sufficient to maintain the diversity within the community. The building hosts two other providers with wall-mounted antennas. One provider has received an approval to screen the antennas and is in the process of preparing construction plans. The third provider has not yet requested to upgrade the facility therefore the antennas are visible from the parking lot. The concentration of providers on Dorothy Drive is possibly a result of the previous zoning ordinance requirements, which prohibited facilities west of Palo Comado Canyon Drive in the BP-OR zone, and the only other permitted zone for wireless facilities was BP-M. The interest from property owners may also have been a factor. The proximity of the buildings to the freeway and the elevation of the building pads, minimizing obstacles to wave transmission, provide a suitable environment for wireless telecommunications facilities. Over the years, other facilities have been approved on office buildings in the vicinity of the proposed location, but with the proposed design, the wireless telecommunications facilities would remain invisible to public view and would not contribute to visual overconcentration of similar uses.
- 6. The proposed use is consistent with the goals and policies of the General Plan with respect to wireless telecommunications facilities, particularly with Goal U-6 and Policies U-6.1 and U-6.2. The General Plan seeks quality communication systems that meet the demands of new and existing developments in the City, which this proposed use does by providing improved wireless telecommunication services and implementation of state-of-the-art telecommunications services. The General Plan requires that the installation of telecommunication infrastructure, such as cellular sites, be designed in a manner as to minimize visual impacts on the surrounding environment and neighborhood, and to be as unobtrusive as possible, which this project accomplishes by screening the antennas behind a solid stuccoed screen and placing the equipment on the roof of the building behind a parapet wall.

<u>Section 5.</u> Pursuant to Section 9661.7.A of the Agoura Hills Zoning Ordinance, and based upon the evidence presented at the hearing, including the staff report and oral and written testimony, the Planning Commission finds that:

- 1. The proposed facilities have been designed and located in compliance with all applicable provisions of Division 11 of Part 2, Chapter 6 of Title IX Zoning. The proposed facilities remain secondary to the main office use on this parcel and are permitted in this zone with a conditional use permit. The facilities have been designed to effectively screen and camouflage the antennas. The associated equipment will be installed on the roof of the building and out of public view. Further, the applicant has completed the supplemental application to the satisfaction of the Director of Planning and Community Development, which serves as compliance verification.
- 2. The proposed facility has been designed and located to achieve compatibility with the community. Wireless telecommunications facilities are being incorporated into an existing building, and adequately screened from the surrounding area.
- 3. The applicant has submitted a statement of its willingness to allow other carriers to collocate on the proposed wireless telecommunications facilities wherever technically and economically feasible and where collocation would not harm community compatibility. The applicant shares the use of the building walls and the building site with other providers. The project does not change this arrangement.
- 4. Noise generated by equipment will not be excessive, annoying, nor be detrimental to the public health, safety, and welfare, and will not exceed the standards set forth in Division 11 of Part 2, Chapter 6 of Title IX Zoning. The project does not increase the overall number of antennas or equipment cabinets, and the applicant has certified that the project will not result in an increase of noise over current conditions. Further, the conditions of approval regulate permissible noise and provide a procedure for addressing potential noise effects.

Section 6. CEQA Findings.

- A. The Planning Commission hereby finds that the approval of the project is categorically exempt from the California Environmental Quality Act (Public Resources Code Section 2100 et seq., "CEQA"), pursuant to Section 15303 (Class 3), because the project involves the construction and location of limited numbers of new, small facilities or installation of small equipment into a structure, and does not have any potential for causing a significant effect on the environment. Additionally and independently, the Planning Commission finds that the Project is covered by the general rule that CEQA applies only to projects which have the potential for causing a significant effect on the environment. It can be seen with certainty that there is no possible significant effect directly related to the project, therefore no further action is required under CEQA pursuant to Section 15061(b)(3) of the State CEQA Guidelines (14 CCR § 15061(b)(3)).
- B. The custodian of records for all materials that constitute the record of proceeding upon which this decision is based is the City Clerk, and those documents are

Draft Resoluti Page 4 of 4	ion No
	evailable for public review in the City Clerk's office located at 30001 Ladyface Court, Agoura Hills, California 91301.
	<u>n 7.</u> Based on the aforementioned findings, the Planning Commission hereby reless Telecommunications Facilities/Conditional Use Permit No. 12-CUP-001, attached Conditions of Approval, with respect to the property described in Section
	n 8. The Secretary of the Planning Commission shall certify to the passage, adoption of this resolution, and shall cause this resolution and this certification to the Book of Resolutions of the Planning Commission of the City.
PASSED, AP	PROVED and ADOPTED this 7 th day of March, 2013, by the following vote to
AYES:	(0)
NOES:	(0)
ABSTAIN:	(0)
ABSENT:	(0)
	Michael Justice, Chairperson
ATTEST:	
1011111	
Michael Kami	no, Secretary

Conditions of Approval (Case No. 12-CUP-001)

STANDARD CONDITIONS

- 1. This decision, or any aspect of this decision, can be appealed to the City Council within fifteen (15) days from the date of Planning Commission action, subject to filing the appropriate forms and related fees.
- 2. This action shall not be effective for any purpose until the applicant has agreed in writing that the applicant is aware of, and accepts all Conditions of this Permit with the Department of Planning and Community Development.
- 3. Except as modified herein, the approval of this action is limited to and requires complete conformation to the approved labeled exhibits: Site Plan; Elevation Plan; and Details Plan.
- 4. All exterior materials used in this project shall be in conformance with the materials samples submitted as a part of this application.
- 5. It is hereby declared to be the intent that if any provision of this Permit is held or declared to be invalid, the Permit shall be void and the privileges granted hereunder shall lapse.
- 6. It is further declared and made a Condition of this action that if any Condition herein is violated, the Permit shall be suspended and the privileges granted hereunder shall lapse; provided that the applicant has been given written notice to cease such violation and has failed to do so for a period of thirty (30) days.
- 7. All requirements of the Zoning Ordinance and of the specific zoning designation of the subject property must be complied with unless set forth in the Conditional Use Permit.
- 8. Unless this permit is used within two (2) years from the date of City approval, Case No. 12-CUP-001 will expire. A written request for a one (1) year extension may be considered prior to the expiration date.
- 9. Operation of the use shall not be granted until all Conditions of Approval have been complied with as determined by the Director of Planning and Community Development.
- 10. Prior to the issuance of building permits, all requirements of the Los Angeles County Fire Department shall be satisfied.
- 11. The facility will require the approval of the Building and Safety Department prior to installation and operation.
- 12. The term "facility" shall mean the wireless telecommunications facility described in the application and set forth in Section 1 of the Resolution approving these conditions of approval.

WIRELESS TELECOMMUNICATIONS FACILITIES STANDARD CONDITIONS

- 1. The permittee shall submit an as built drawing within ninety (90) days after installation of the facility.
- 2. The permittee shall submit and maintain current at all times basic contact and site information on a form to be supplied by the City. The permittee shall notify the City of any changes to the information submitted within seven (7) days of any change, including change of the name or legal status of the owner or operator. This information shall include, but is not limited to, the following:
 - a. Identity, including the name, address and 24-hour local or toll free contact phone number of the permittee, the owner, the operator, and the agent or person responsible for the maintenance of the facility.
 - b. The legal status of the owner of the wireless telecommunications facility, including official identification numbers and Federal Communications Commission certification.
 - c. Name, address and telephone number of the property owner if different than the permittee.
- 3. Upon any transfer or assignment of the permit, the Director may require submission of any supporting materials or documentation necessary to determine that the proposed use is in compliance with the existing permit and all of its conditions of approval including, but not limited to, statements, photographs, plans, drawings, models, and analysis by a qualified radio frequency engineer demonstrating compliance with all applicable regulations and standards of the Federal Communications Commission and the California Public Utilities Commission. If the Director determines that the proposed operation is not consistent with the existing permit, the Director shall notify the permittee who shall either revise the application or apply for modification of the permit pursuant to the requirements of the Agoura Hills Municipal Code.
- 4. The permittee shall not place any facilities that will deny access to, or otherwise interfere with, any public utility, easement, or right-of-way located on the site. The permittee shall allow the City reasonable access to, and maintenance of, all utilities and existing public improvements within or adjacent to the site, including, but not limited to, pavement, trees, public utilities, lighting and public signage.
- 5. At all times, all required notices and signs shall be posted on the site as required by the Federal Communications Commission and California Public Utilities Commission, and as approved by the City. The location and dimensions of a sign bearing the emergency contact name and telephone number shall be posted pursuant to the approved plans.
- 6. At all times, the permittee shall ensure that the facility complies with the most current regulatory and operational standards including, but not limited to, radio frequency emissions standards adopted by the Federal Communications Commission and antenna

height standards adopted by the Federal Aviation Administration, and shall timely submit all monitoring reports required pursuant to section 9661.13 of the Agoura Hills Municipal Code.

- 7. If the Director determines there is good cause to believe that the facility may emit radio frequency emissions that are likely to exceed Federal Communications Commission standards, the Director may require post-installation testing, at permittee's expense, or the Director may require the permittee to submit a technically sufficient written report certified by a qualified radio frequency emissions engineer at other than the regularly required intervals specified in Section 9661.13 of the Agoura Hills Municipal Code, certifying that the facility is in compliance with such FCC standards.
- 8. Permittee shall pay for and provide a performance bond, which shall be in effect until the facility is fully and completely removed and the site reasonably returned to its original condition, to cover permittee's obligations under these conditions of approval and the Agoura Hills Municipal Code. The bond coverage shall include, but not be limited to, removal of the facility, maintenance obligations and landscaping obligations. Such performance bond shall be in a form satisfactory to the City Attorney and Risk Manager, naming the City as obligee, in an amount equal to \$25,000.
- 9. If a nearby property owner registers a noise complaint and such complaint is verified as valid by the City, the City may hire a consultant to study, examine and evaluate the noise complaint and the permittee shall pay the fee for the consultant. The matter shall be reviewed by the Director. If the Director determines sound proofing or other sound attenuation measures should be required to bring the project into compliance with the Agoura Hills Municipal Code, the Director may impose that condition on the project after notice and a public hearing.
- 10. Permittee shall defend, indemnify, protect and hold harmless City, its elected and appointed Council Members, boards, commissions, officers, officials, agents, consultants, employees, and volunteers from and against any and all claims, actions, or proceeding against the City, and its elected and appointed Council Members, boards, commissions, officers, officials, agents, consultants, employees, and volunteers to attack, set aside, void or annul, an approval of the City, Planning Commission or City Council concerning this permit and the project. Such indemnification shall include damages, judgments, settlements, penalties, fines, defensive costs or expenses, including, but not limited to, interest, attorneys' fees and expert witness fees, or liability of any kind related to or arising from such claim, action, or proceeding. The City shall promptly notify the permittee of any claim, action, or proceeding. Nothing contained herein shall prohibit City from participating in a defense of any claim, action or proceeding. The City shall have the option of coordinating the defense, including, but not limited to, choosing counsel for the defense at permittee's expense.
- 11. "Permittee" shall include the applicant and all successors in interest to this permit.
- 12. The facility shall bear no signs or advertising devices other than certification, warning or other signage required by law or permitted by the City.

- 13. The facility shall not be illuminated unless specifically required by the Federal Aviation Administration or other government agency. Lightning arresters and beacon lights are not permitted unless required by the Federal Aviation Administration or other government agency. Any required lighting shall be shielded to eliminated, to the maximum extent possible, impacts on the surrounding neighborhoods, and a lighting study shall be prepared by a qualified lighting professional to evaluate potential impacts to adjacent properties, which must be reviewed and approved by the City prior to the installation of any lighting.
- 14. The permittee shall submit to the City within ninety (90) days of beginning operations under this permit, and every two years from the date the facility begins operations, a technically sufficient report ("monitoring report") that demonstrates the following:
 - a. The facility is in compliance with applicable federal regulations, including Federal Communications Commission RF emissions standards, as certified by a qualified radio frequency emissions engineer;
 - b. The facility is in compliance with all provisions of this section and its conditions of approval.
 - c. The bandwidth of the facility has not been changed since the original application or last report, as applicable, and if it has, a full written description of that change.

15. Noise.

- a. The facility shall be operated and maintained in such a manner so as to minimize any possible disruption caused by noise.
- b. The facility is not approved for a backup generator. In the event of an emergency that results in a loss of power to the facility, a temporary emergency backup generator may be employed and shall only be operated during periods of power outages, and shall not be tested on weekends or holidays, or between the hours of 7:00 PM and 7:00 AM. The temporary emergency backup generator shall be promptly removed from the premises once the emergency is terminated.
- c. At no time shall equipment noise from the facility exceed an exterior noise level of fifty-five (55) dBA at the facility's property line and such equipment noise shall at no time be audible at the property line of any property zoned residential or improved with a residential use that is located within five hundred (500) feet of the facility.
- d. All air conditioning units and any other equipment that may emit noise that would be audible from beyond the facility's property line shall be enclosed or equipped with noise attenuation devices to the extent necessary to ensure compliance with applicable noise limitations under the City of Agoura Hills Municipal Code.

- e. Except for emergency repairs, any testing and maintenance activities that will be audible beyond the property line shall only occur between the hours of 7:00 a.m. and 7:00 p.m. on Monday through Friday, excluding holidays, unless alternative hours are approved by the Director.
- 16. Features designed to make the facility resistant to, and minimize opportunities for, unauthorized access, climbing, vandalism, graffiti and other conditions that would result in hazardous situations, visual blight or attractive nuisances shall not be removed by permittee and shall be maintained in good condition.
- 17. The facility, including, but not limited to, antennas, accessory equipment, walls, shields, cabinets, camouflage, and the facility site, shall be maintained in good condition, including ensuring the facility is reasonably free of:
 - a. General dirt and grease;
 - b. Chipped, faded, peeling, and cracked paint;
 - c. Rust and corrosion;
 - d. Cracks, dents, and discoloration;
 - e. Missing, discolored or damaged screening or other camouflage;
 - f. Graffiti, bills, stickers, advertisements, litter and debris;
 - g. Broken and misshapen structural parts; and
 - h. Any damage from any cause.

The permittee shall replace its facility, or part thereof, after obtaining all required permits, if maintenance or repair is not sufficient to return the facility to the condition it was in at the time of installation. The permittee shall routinely inspect the facility and site to ensure compliance with the standards set forth in the Agoura Hills Municipal Code and these conditions of approval.

- 18. Graffiti shall be removed from a facility as soon as practicable, and in no instance more than twenty-four (24) hours from the time of notification by the City, unless a provision of the Agoura Hills Municipal Code provides a shorter time period for removal.
- 19. In the event the permittee desires to modify the facility, the permittee shall apply for and obtain all permits or permit amendments required by the Agoura Hills Municipal Code prior to making any modification to the facility. At a minimum, any application for modification to the facility shall use the screening and camouflage designs approved by this permit unless a more effective screen, concealment or camouflage design is proposed by the permittee or required by the Agoura Hills Municipal Code, or the building is remodeled such that it necessitates a new screen concealment or camouflage design that is consistent with the building façade. Additionally, to the extent feasible, existing

equipment shall be replaced with equipment that reduces visual, noise and other impacts, including, but not limited to, replacing larger, more visually intrusive facilities with smaller, less visually intrusive facilities. "Modification means a change to an existing wireless telecommunications facility that involves any of the following: collocation, expansion, alteration, enlargement, intensification, reduction, or augmentation, including, but not limited to, changes in size, shape, color, visual design, or exterior material. "Modification does not include repair, replacement or maintenance if those actions do not involve a change to the existing facility involving any of the following: collocation, expansion, alteration, enlargement, intensification, reduction, or augmentation.

- 20. This permit shall be valid for a period of ten (10) years from the date of Planning Commission approval, which is the date of issuance, unless pursuant to another provision of the Agoura Hills Municipal Code it lapses sooner or is revoked. At the end of ten (10) years from the date of issuance, this permit shall expire.
- 21. In the event the facility ceases to provide wireless telecommunications services for ninety (90) or more consecutive days, the facility shall be considered abandoned and shall be promptly removed as provided in these conditions of approval and the Agoura Hills Municipal Code. If there are two (2) or more users of a single facility, then this provision shall not become effective until all users cease using the facility.
- 22. The permittee shall notify the City in writing of its intent to abandon or cease use of the facility within ten (10) days of ceasing or abandoning use. Additionally, the permittee shall provide written notice to the Director of any discontinuation of operations of thirty (30) days or more.
- 23. Failure to inform the Director of cessation or discontinuation of operations of the facility as required by these conditions of approval shall constitute a violation of the conditions of approval and be grounds for:
 - a. Prosecution;
 - b. Revocation or modification of the permit;
 - c. Calling of any bond or other assurance required by the Agoura Hills Municipal Code or conditions of approval of the permit;
 - d. Removal of the facility by the City in accordance with the procedures established under the Agoura Hills Municipal Code for abatement of a public nuisance at the permittee's expense; and/or
 - e. Any other remedies permitted under the Agoura Hills Municipal Code.
- 24. Upon the expiration date of the permit, including any extensions, earlier termination or revocation of the permit or abandonment of the facility, the permittee, the property owner, or both shall remove the facility and restore the site to its natural condition except for retaining the landscaping improvements and any other improvements at the discretion

- of the City. Removal shall be in accordance with proper health and safety requirements and all ordinances, rules, and regulations of the City. The facility shall be removed from the property, at no cost or expense to the City. The private property owner shall be independently responsible for the expense of timely removal and restoration.
- 25. Failure of the permittee, property owner, or both to promptly remove the facility and restore the property within thirty (30) days after expiration of this permit, earlier termination or revocation of this permit, or abandonment of the facility, shall be a violation of the Agoura Hills Municipal Code, and shall be grounds for:
 - a. Prosecution;
 - b. Calling of any bond or other assurance required by the Agoura Hills Municipal Code or conditions of approval of permit;
 - c. Removal of the facility by the City in accordance with the procedures established under the Agoura Hills Municipal Code for abatement of a public nuisance at the permittee and/or property owner's expense; and/or
 - d. Any other remedies permitted under the Agoura Hills Municipal Code.
- 26. The facility shall comply at all times with any and all applicable local, state, and federal laws, regulations and guidelines. Any violation of these conditions of approval or the Agoura Hills Municipal Code may be subject to the citations, penalties and fines as set forth in the Agoura Hills Municipal Code, other available remedies and/or revocation or modification of this permit at the discretion of the City Attorney and City Prosecutor.

END

City of Agoura Hills

CONDITIONAL USE PERMIT - CASE NO. 12-CUP-001





Sprint

NETWORK VISION MMBTS LAUNCH AGOURA HILLS LA03XC200

ROOFTOP 28030 DOROTHY DR. AGOURA HILLS, CA 91301 CITY OF AGOURA HILLS

LATITUDE: 34° 8' 30.011" N 34.141670

LONGITUDE: 118° 44' 12.012" W -118.736670

LOS ANGELES MARKET

SHEET DESCRIPTION TITLE SHEET CENERAL NOTES & SYMBOLS SIGNAGE, NOTES & ZOMING DOCUMENTS OVERALL SITE PLAY ENLARGED ANTENNA & EQUIPMENT PLANS (F) (E) & (N) SOUTH ELEVATIONS (E) & (N) NORTH ELEVATION (E) & (N) EAST ELEVATIONS A-10 CONSTRUCTION DETAILS A-11 (N) COLOR CODING SCHEMATIC GROUNDING PLANS GROUNDING DETAILS

SHEET INDEX


ALL WORK AND MATERIALS SHALL BE PERFORMED AND INSTALLED IN ACCORDANCE WITH THE CURRENT EDITIONS OF THE FOLLOWING CODES AS ADOPTED BY THE LOCAL COVERNING AUTHORITIES.

- CAUTORINA ADMINISTRATIVE CODE (INC. TITLE 24 & 29)
 2010 CLUFORINA ENERGINA CODE
 2010 CLUFORINA GEREI BILLIDING STANDARDS CODE
 2010 CLUFORINA FELDERING CODE
 2010 CLUFORINA ELECTRICAL CODE
 2010 CLUFORINA ELECTRICAL CODE
 2010 CLUFORINA FREE CODE
 2011 CLUFORINA FREE CODE
 2011 CLUFORINA FREE CODE
 2011 CLUFORINA FREE CODE
 2011 CLUFORINA DEVENT CODE
 2011 CLUFORINA DEVENT CODE
 2011 CLUFORINA CODE
 2011 CLUFORINA

ACCESSIBILITY REQUIREMENTS:

CODE BLOCK

FACILITY IS UNMANNED AND NOT FOR HUMAN HABITATION. HANDICAPPED ACCESS REQUIREMENTS ARE NOT REQUIRED IN ACCORDANCE WITH THE 2010 CALIFORNIA BUILDING CODE.

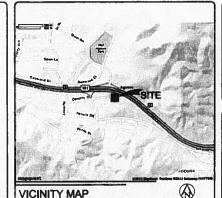

APPROVAL	SIGNATURE	DATE	REMOVE ALL (E) REMOVE ALL (E) REMOVE (1) (E)	PANEL ANTENNAS PANEL ANTENNAS ANTEINA COAX HYBRIFLEX CABLES MODCELL 4.0 CARN MODCELL 4.0 CARN
PROJECT MANAGER			REMOVE (1) (E)	BATTERY BACK UP I POWER CABINET (OC BATTERY BACK UP
ONSTRUCTION MANAGER	THOMAS TRAPANI	02/25/12	RNSTALL (8) (N)	MICH UNITS JUNCTION BOX
F ENGINEER				(E) APPROMAL
			# OF ANTENNAS	8
ACQUISITION	T. ANDREDE/SACW	02/28/12	SIZE OF ANTERNAS	4'-0"
			EQUIPMENT	×
PLANNING				

SIGNATURE BLOCK PROJECT DESCRIPTION

SPRINT PROPOSES TO MODIFY AN (E) UNMANNED TELECOMMUNICATIONS FACILITY

	(E) APPROVAL	(E) ON SITE	(PROPOSED) MOD
F OF ANTENNAS	8	4	3
SIZE OF ANTENNAS	4'-0"	4'-0"	6'-0"
EOUIPMENT	X	4	4

	(E) APPROVAL	(E) ON SITE	(PROPOSED) MOD
# OF ANTENNAS		4	3
SIZE OF ANTERNAS	4'-0"	4'-0"	6'-0"
EQUIPMENT	×	4	4

- ETAIN OUT ORDER METRICAST ON COMMENCE TOWARD EL CAMINO REAL.
 THAN LEST ONTO EL CAMINO REAL.
 THAN LEST ONTO EL CAMINO REAL.
 THAN LEST ONTO EL CAMINO REAL
 THAN LEST ONTO MARGINE RO.
 METRIC RENT DE UN TOWARD LOS AMORLES/CWC CIDITER.
 THAN LEST ONTO REAL CONTON RO. METRICASTOR ON TOWARD LEST CONTO BROWN THE R.
 THAN LEST ONTO BROWN THE R.
 THAN LEST ONTO BROWN THE R.

DRIVING DIRECTIONS

APPLICANT:

SPRINT 310 COMMERCE IRVINE, CALIFORNIA 92602 CONTACT: TSD

PROPERTY INFORMATION:

PROPERTY OWNER:

JACK DANIELS & SHELLE HARRIS-DANIELS CAL WEST EMPERPRISES, INC. 28030 DORTHY DRIVE, SUITE 205 AGOURA HILLS, CA 91301

JACK DANIELS (818) 706-7383

BUILDING CODE: ZONING CLASSIFICATION: OCCUPANCY / USE: PROPOSED PROJECT USE:

TYPE OF CONSTRUCTION: ±21,072 SQ.FT. ±14,476 SQ.FT. 2 FLOORS + GROUND LEVEL/±43'-6"

OF STORIES / HEIGHT: PARCEL NUMBER(S);

DESCRIPTION WAS OBTAINED ON 11-29-2011 WA FORTING PLANSTITLE REPORT 1: IN BLOCK 13 OF TRACT NO. 8451, IN THE CITY OF ACQUIRA HILLS, IN THE OF US ANGELES, STATE OF CAUFORNIA, AS POR MAP RECOGNED IN BOOK 79 THROUGH 90 INCLUSING OF MAPS, IN THE OFFICE OF THE COUNTY RECO

PAGES TO THROUGH BO SELEGISTIC OF MAPS, AN THE OFFICE OF THE COURTY RECORDER COCCUTT PRESERVED MAY REPORTED STAND LAND, OCCURED AS FOLLOWS EXCEMBED AT THE MOST MORTHAGHN COMMENT OF MAD LATT 34: THRICK SOUTH 54: 55: 50 of MOST, 34: THRICK SOUTH 54: 55: 50 of MOST, 35: TREET FROM THE MORTHAGETTERY EXCEMBED WHICH EACHS MOST OF MOST DESTRUCTION OF SOUTH OF MOST DESTRUCTION OF MOST DEST

PROJECT SUMMARY

ARCHITECT:

NESTOR POPOWYCH, AM SAC WIRELESS, LLC. 5855 AMPRILESS, LLC. 5855 AMPRILE ELC. 5855 A

STRUCTURAL:

SAC WIRELESS, LLC. 5865 AVENDA ENCINAS, SUITE 142-8 CARLSBAD, CA 92008

SITE ACQ PROJECT MANAGER: ALCATEL-LUCENT CONTACT: RICHARD COONS PH: (925) 787-7286

CONSTRUCTION MANAGER: ALCATEL-LUCENT CONTACT: KEITH BARNHART PH: (415) 404-1225

PLANNING CONSULTANT; SAC WRELESS CONTACT: JENNIFER CHESNEY PH: (949) 235-8282

ELECTRICAL ENGINEER CONTACT: ROBBIE JOHNSON PH: 616-678-4433

POWER COMPANY:

CONTACT: TRACY BASS PH: 949-697-1424

TELCO COMPANY:

PROJECT TEAM









NETWORK VISION MIMBTS LAUNCH

AGOURA HILLS

LA03XC200 28030 DOROTHY DR

AGOURA HILLS, CA 91301 AGOURA HILLS

02/24/2012

ISSUED FOR:

		100%CD's	
		REVISIONS	=
WV.	DATE	DESCRIPTION	petu
A	02/24/12	ISSUED FOR 90% CD REVIEW	D
B	03/13/12	ISSUED FOR 90% CD REVIEW	AN
c	03/28/12	100%CD's	Б
		CITY COMMENTS	0
Δ	10/18/12	CITY COMMENTS	ю
	1		1

NOT FOR CONSTRUCTION UNLESS LABELED AS CONSTRUCTION SET

63

SHEET YITLE:

TITLE SHEET

SHEET NUMBER:

1-1



REVISION

THE INFORMATION COMPANIED IN THIS SET OF CONSTRUCTION DOCUMENTS IS PROPRIETMENT BY MATURE. ANY USE OR DISCLOSURE OTHER THAN THAT WHICH RELATES TO CAMBRIE SERVICES IS STRUTLY PROPRIETMENT.

GENERAL NOTES:

- THE CONTRACTOR SHALL NOTIFY CARRIER OF ANY ERRORS, DAISSIONS, OR NOOMSTONACES AS THEY MAY BE COSCIUNCTED IN PLANS, DOCUMENTS, NOTICE. OR NOCINCESTRICAGES AS THEY MAY BE COSCIUNCTED ANY PLANS, DOCUMENTS, NOTICE. OR SECURITORISE OF THE CONTRACTOR O
- PRIOR TO THE SUBMISSION OF BBS, CONTINUENDS ANOLYDD SHALL VISIT THE JOB STE TO FAMILIAREZ THEMSELVES WITH ALL COMMITTIONS AFFECTION THE (M) PROJECT, PRICE TO THE COMMISSIONITY OF CONSTRUCTION, THE CONTINUENCY MAYNES BEEN AMANDED. THE CONTINUENCY THE CONTINUENCY MAY BE AND CONTINUENCY THE BEEN AMANDED THE CONTINUENCY THE DEDICTION OF THE CONTINUENCY MAY BEEN AMANDED COMMISSION SHOWN, PRICE OF THE CONTINUENCY MAY BEEN AMANDED COMMISSION SHOWN, PRICE OF PROCEEDING WITH CONSTRUCTION, ANY ERRORS, OMESSIONS, OR DESCRIPTANCIES SHALL BE BROUGHT TO THE ATTENTION OF THE ARCHITECT VERSIONLY AND IN WINDOWS.
- FOR COLLOCATION SITES: CONTACT BUILDING PROPERTY OWNER'S REPRESENTATIVE FOR PARTICIPATION IN BID WALK.
- THE ARCHITECT HAS MADE EVERY EFFORT TO SET FORTH IN THE CONSTRUCTION AND CONTINUED GOLDMANTS THE COMPILETE SCOPE OF WORK, CONTINUEDUS BIDDING THE JOB ARE INCREPTILLESS CULTURED THAT MADE OMESSIONS OR FERRORS HE TO DISCUSS MO OF SPECEPICATIONS SHALL NOT DESIGN SHOULD CHARMATON FROM THE SET COLUMBATES. THE SHOOTE SHALL BEAR THE RESPONSIBILITY OF ONTOTYING OF WIRTHING THE ARCHITECT/PLICIAGET OF ANY COMPILETS, ERRORS, OR GIASSIONS PROPARED TO SUBMISSION OF CONTINUED FROM SPECIAL BEAR THE LEVEL OF LOCKEPAMICES THE CONTINUED OF SHALL PRICE THE MORE COSTLY OR ENTRISAME WORK, UNLESS DIRECTED OTHERWISE.
- OWNER, CONTRACTOR, AND CARRIER CONSTRUCTION PROJECT MANAGER SHALL MEET JOINTLY TO YERRY ALL DRAWINGS AND SPECIFICATIONS PRIOR TO THE START OF
- THE GENERAL CONTRACTOR SHALL RECENE WRITTEN AUTHORIZATION TO PROCEED WITH CONSTRUCTION PRIOR TO STARTING WORK ON ANY ITEM NOT CLEARLY DEFINED BY THE CONSTRUCTION DRAWNINGS/CONTRACT DOCUMENTS.
- THE CONTRACTOR SHALL PERFORM WORK DURING OWNER'S PREFERRED HOURS TO AVOID DISTURBING MORNAL BUSINESS.
- THE CONTRACTOR SHALL PROVIDE CARRIER PROPER INSURANCE DENTIFICATES HAMING CARRIER AS ADDITIONAL INSURED, AND CARRIER PROOF OF LICENSE(S) AND PE & POINSURANCE.
- THE CONTRACTOR SHALL INSTALL ALL EQUIPMENT AND MATERIALS ACCORDING TO MANUFACTURER'S / VENDOR'S SPECIFICATIONS UNLESS NOTED OTHERWISE OR WHERE LOCAL CODES OR ORDINANCES TAKE PRECEDENCE.
- ALL WORK PERFORMED ON THE PROJECT AND MATERIALS RETALLED SHALL BE IN STREET ACCORDANCE WITH ALL APPLICABLE CODES, REGULATIONS, AND ORDINANCES, REGULATIONS, AND ADMINISTRATION AND AUTHOR ORDINS OF ANY PRESE AUTHORITY, MARCHAL AND UTILITY COMPANY SPEEDFACTIONS, AND LOCAL AND STATE JURISDICTIONAL CODES BEARDOON THE PERFORMANCE OF THE WORK.
- THE CONTRACTOR SHALL STUDY THE STRUCTURAL, ELECTRICAL, AND MECHANICAL PLANS AND GROSS CHECK THEIR DETAILS, NOTES, DIMENSIONS, AND ALL REQUIREMENTS PRIOR TO THE STATE OF ANY WORK.
- THE REFERENCES ON THE DRAWINGS ARE FOR CONVENENCE ONLY AND SHALL NOT LIMIT THE APPLICATION OF ANY DRAWING OR DETAIL.
- ALL (E) CONSTRUCTION, EQUIPMENT, AND FINESHES MOTED TO BE REMOVED SHALL BECOME THE PROPERTY OF THE CONTRACTOR AND WALL BE REMOVED FROM THE SITE WITH THE FOLLOWING EXCEPTIONS IS BE REFURNED TO THE OWNER.

 A. PROPERTY NOTED IN WITHOUT DIS BE REFURNED TO THE OWNER.

 B. PROPERTY NOTED IN WITHOUT DIS BE REMOVED BY THE OWNER.
- PRIOR TO THE POURING OF ANY NEW SLAB OVER AM (E) SLAB THE CONTRACTOR SHALL VERSY LOCATIONS OF ALL OPENINGS, CHASES, AND EDURABENT WHICH ARE TO BE MOCROPORATE OFFO THE NEW WORK. ALL TIESD ESSEMINED TO BE AMADIONED SHALL BE WRITTED AND DESCUSSED WITH THE OWNER, AND CARRIER CONSTRUCTION MANAGER AS PART OF THE AS-BILLY TOWNING PROMOSE.
- SEAL ALL PENETRATIONS THROUGH FIRE—RATED AREAS WITH U.L. LISTED OR FIRE MARSHALL APPROVED MATERIALS IF APPLICABLE TO THIS PROJECT SITE.

- ALL RF TRANSPARENT CLASS AND CLAZING IS TO COMPLY WITH CHAPTER 54 OF THE U.S. CONSINCER SAFETY COMMISSION SAFETY STANDARDS FOR ARCHITECTURAL CLAZING MATERIALS (42 FR 1428, CFR PART 1201) AND LOCAL SECURITY RECORDEROTIS.
- 19. CONTRACTOR SHALL MAKE NECESSARY PROVISIONS TO PROTECT (E) SITE IMPROVEMENTS, HARDSCAPING, EASEMENTS, PAINING, CURBING, CTC, DURING CONSTRUCTION, UPON COMPLETION OF WORK, CONTRACTOR SHALL REPAIR ANY DAMAGE THAT MAY HAVE OCCURRED DUE TO CONSTRUCTION ON OR ABOUT THE PROPERTY.
- CONTINUCTOR SHALL KEEP GENERAL WORK AREA CLEAN AND HAZARD FREE DURING CONSTRUCTION. CONTRACTOR SHALL RELIGIES COMPRIENT NOT SPECIFIED AS RELIAMING ON THE PROPERTY OF PRECISES. STILL SHALL BE LETT IN CLEAR CONDITION AND FREE FROM PANT SPOTS, DUST. OR SAUDIESS OF ANY HATURE.
- THE CONTRACTOR IS TO PROVIDE PROTECTION FOR ADJOINING PROPERTIES FROM PHYSICAL HARM, NOISE, DUST, DIRT, FIRE, AND FALLING OBJECTS AS REQUIRED BY THE COVERBING AGENCIES.
- THE CONTRACTOR IS RESPONSIBLE FOR THE STORAGE OF ALL BUILDING MATERIALS AND SHALL NOT DO SO ON PUBLIC PROPERTY WITHOUT A PERMIT FROM THE GOVERNING ACENCIES.
- 23. GENERAL NOTES AND STANDARD DETAILS ARE THE MINIMUM REQUIREMENTS TO BE USED IN CONDITIONS WHICH ARE NOT SPECIFICALLY SHOWN OTHERWISE.
- 24. TRADES INVOLVED IN THE PROJECT SHALL BE RESPONSIBLE FOR THEIR OWN CUTTING, FITTING, PATCHING, FTC., SO AS TO BE COOMDINATED TO THE WORK OF OTHER TRADES
- 25. CARRER DOES NOT GUAMANTIE ANY PRODUCTS, FIXTURES, AND/OR ANY EXUPMENT MANDED BY A TRADE OR BAMBEACHURER, QUAMANTIES OR WARRANTY THAT MAY BE N EFFECT IS DONE 50 THROUGH THE COMPANY OR MANAFACTURES PRODUCT, RICHARD, AND/OR COMPANY TO MAY, UMIZES SPECIFIC RESPONSIBILITY S ALSO PROMOBED BY THE COMMISSION ONLY, UMIZES SPECIFIC RESPONSIBILITY S

- 28. WHEN APPLICABLE, CONTRACTOR IS RESPONSIBLE TO CALL, COORDONATE AND/OR MAKE
 ARRANGEMENTS FOR ROHT-OF-MAY AMO/OR PRIVATE PROPERTY ACCESS BASED ON SPECIFIC
 STITE REQUIREMENTS.
 STITE REQUIREMENTS.
 STILE PROPERTY ACCESS BASED ON SPECIFIC
 STITE REQUIREMENTS.
 STILE PROPERTY AND ARRANGEMENTS.
 STILE PROPERTY ACCESS BASED ON SPECIFIC
 STILE PROPERTY AND ARRANGEMENTS.
 STILL PROPERTY AND ARRANGEMENTS.
- 27. CONTRACTORS TO DOCUMENT ALL WORK PERFORMED WITH PHOTOGRAPHS AND SUBMIT TO CARRIER ALONG WITH REDLINED CONSTRUCTION SET.
- 28. CONTRACTOR SHALL DOCUMENT ALL CHANGES MADE IN THE FIELD BY MARKING UP (REDUNNA) THE APPROVED CONSTRUCTION SET AND SUBMITTING THE REDUNNED ALONG WITH PHOTOGRAPHS PER CAMPRE RECOMMENDATIS.
- GENERAL CONTRACTOR IS TO COORDINATE ALL POWER INSTALLATION WITH POWER COMPANY REQUIRED. CONTRACTOR TO REPORT POWER INSTALLATION COORDINATION SOLUTION(3) TO NETWORK CHARGE REPORTESEMENTING. PROJECT CONSTRUCTION MANAGER AND ARCHITECT.
- 30. ANY SUBSTRUCTIONS OF MATERIALS AND/OR EQUIPMENT, MUST BE APPROVED BY CARRIED CONSTRUCTION MANAGER.
- 31. THE CORRENA DEPOSITION OF THE PROJECT, UNLESS ONE-TWENTER WITTEN OF THE CONTRACT SHALL PLANTY, INSTRUCT, MANYON PARKET WATER AND COOKS, AND/OR FALLY WITERANS WATER AND COOKS, AND/OR FALLY WITERANS WATER AND COOKS OF THE CONTRACT REVENUE THE OWNER OF THE CONTRACT REVENUE THE OWNER AND THE CONTRACTOR, COCCUPING THE OWNER AND THE CONTRACTOR SHALL FURNISH A MAINTENANCE ARRESTMENT OF THE ESSENIE CONTRACTOR, TO MAINTENANCE ARRESTMENT OF THE ESSENIE CONTRACTOR, TO MAINTENANCE ARRESTMENT OF THE ESSENIE CONTRACTOR, TO MAINTENANCE ARRESTMENT OF THE PROJECT, UNLESS OTHERWISE WRITTEN IN THE CONTRACT SETTING THE OWNER AND THE CONTRACTOR.
- THE CONTRACTOR SHALL PROMDE ADEQUATE PROTECTION FOR THE SAFETY OF THE OWNER'S EMPLOYEES AT ALL TIMES DURING THE CONSTRUCTION OF THE PROJECT.
- 33. CARRIER WILL REVIEW AND APPROVE SHOP DRAWINGS AND SAMPLES FOR CONFORMANCE WITH DESIGN CONCEPT, CARRIER PROJECT APPROVAL OF A SEPARATE ITEM SHALL NOT INCLUDE APPROVAL OF AN ASSEMBLY IN WINCH THE ITEM FUNCTIONS.
- 34. ALL ANTENNAS MOUNTED ON ROOF SUPPORT FRAMES TO BE PROVIDED BY CARRIER COMMUNICATIONS.
- 35. CONTRACTOR TO REPAIR ALL GROUND SURFACES WITHIN THE CONSTRUCTION AREA AS NECESSARY TO PROVIDE A LIMIFORM SURFACE AND MAINTAIN (E) SURFACE DRAMAGE SLOPES.
- 38. CONTRACTOR TO REPLACE LANDSCAPE VEGETATION THAT WAS DAMAGED DUE TO CONSTRUCTION, AND TO MODIFY REMARKING ISRIGATION LINES TO OPERATING COMOITION PROVIDEN FULL COVERAGE TO MEMORITED AREAS.
- 37. IN THE CASE OF ROOFTOP SOLUTIONS FOR EDUPMENT AND/OR ANTENNA FRAMES WHERE PENETRATION OF (E) ROOFING MATERIALS OCCUR, THE GENERAL CONTRACTOR SHALL COORDINATE WITH SALEDING OWNER AND BALLDRIS ROOFING CONTRACTOR OF RECORD FOR RESTALLATION, PATCH, REPARK OR ANY AUGILEPTATION OF THE ROOF, AND HAVE THE WOOK GUARANTEED UNDER THE ROOFING CONTRACTOR'S WARRANTY FOR MOISTURE PENETRATION OR AND OTHER FUTURE BREACH OF ROOFING INTEGRITY.
- 38. IN THE CASE OF BOOTTOP SOLUTIONS WITH THE INSTALLATION OF ANTENMAS WITHIN CONCALLED RY TIMMSPARCHT SCREDIES, MOUNTED ON SUPPORT TRAMES OR TRIPPOS, THE CONCALLED RY TIMMSPARCHT SCREDIES, MOUNTED ON SUPPORT TRAMES OR TRIPPOS, THE CONCALL COMMINATOR WITH THE FIRE DESCRIPPORT OF THE DESCRIPPORT OF THE PROPERTY OF THE CONFINCTION SHALL DESIRE THAT THAN CONSTRUCTION REPRESENTE SHALL BE PROVIDED TO THE CHARGE OF THE PROPERTY OF OF THE PRO
- 39. NOT USED
- THIS FACILITY IS AN UNMANNED CELLILAR TELEPHONE EQUIPMENT FACILITY. THE OCCUPANCY CLASSIFICATION IS B (2007 CBC, TITLE 24, PART 2, VOLUME 1, SECTION 311.3, AND SECTION 307.1 EXCEPTION § [1-1].
- 41. THIS FACILITY IS EXEMPT FROM DISABLED ACCESSIBILITY REQUIREMENTS PER 2007 CBC SECTION 11098.3.4 EXCEPTION \$1 THIS FACILITY IS NON-OCCUPABLE SPACE AND ENTERED ONLY BY SERVICE PROSONNEL. THIS SPACE IS NOT FOR HUMAN OCCUPANCY.
- 42, THE CONTRACTOR SHALL VERBY ALL (E) CONDITIONS AND DIMENSIONS PRIOR TO SUBMITTEN THEIR BID, ANY DISCREPANCES, CONFLICTS OR CASSIONS SHALL BE REPORTED TO THE ARCHITECT PRIOR TO SUBMITTING BIDS. AND PROCEEDING WITH ANY WORK.
- 43. THE CONTRACTOR SHALL MOTEY ARCHITECT OF ANY ERRORS, CHISSIONS, OR DECREPANCES AS THEY MAY BE DISCOVERED AN THE PANKS, SPECHFOLYDONS, & NOTES PROOF TO STARTING CONSTRUCTION, MICLIANDE BY MOY LIMITOR BY DISCOLUTION, THE CONTRACTION SHALL BE ASSOCIATED ASSOCIATION OF THE SHAT OF CONSTRUCTION SHALL BICK ANY EXPOSES TO RECEIVE THE SHATMON. THE MICHIGAN CONTRACTOR SHALL BICK ANY EXPOSES TO RECEIVE THE STRATION. THE METHOD OF COMPRETION SHALL BE APPROVED BY THE MICHIGAN THE DISCOVERY.
- 44. PROR TO STAFTING CONSTRUCTION, THE CONTRACTOR HAS THE RESPONSIBILITY TO LOCATE ALL (E) UTILITIES, WRITTED OR NOT SHORM ON THE PLANS, AND TO PROTECT THEN FROM DAMAGE, THE CONTRACTION OR SUBCONTRACTOR SHALL BEAR THE DEPOSES OF REPARMS OR REPLACING ANY DAMAGE TO THE UTILITIES CAUSED DURING THE EXECUTION OF THE WORK. COMMET USE DIG ALERT © 400-227-2800
- 45. PRIOR TO STARTING CONSTRUCTION, THE CONTRACTOR SHALL PROTECT ALL AREAS FROM FROM ID SIMPLEM CHARLENG, INC. CONTINUED IN SMALL PROJECT ALL APERS FROM BAMAGE WHICH MAY OCCUR DURING CONSTRUCTION, ANY COMMACE TO NEW OR (E) SURFACES, STRUCTURES OR COMPARENT SMALL BE BANCEMENTLY REPAIRED OR REPLACED TO THE STRUCTURE OF THE PROPERTY ORBIGI. THE CONTRACTOR SHALL BEAR THE EXPENSE OF REPLACED OR REPLACED ANY DIMAGED MESS.
- 48. A COPY OF THE AMPROVED PLANS SHALL BE REPT IN A PLACE SPECIFED BY THE COMENNION ACQUEST, AND BY LIKE BHALL BE AMAZINE, FOR HOMERCHON AT ALL TRACE. IT IS THE MEAN ACQUEST, AND BY LIKE BHALL BY ALL THE CHARLEST BHALL AS AN ARREST BHALL BHALL BHALL BHALL CHARLES, REVISIONS, ADDITION, BY CHARLES REPORTED PLANS AT THE SITE FOR THE PLANSESSE OF DICKARDATION SHALL AS ALL CHARLES, REVISIONS, ADDITION, BY CHARLES BHALL CHARLES, REVISIONS, ADDITION, BY CHARLES BHALL CHARLES, REVISIONS, DICKARDAM ONE THE PROJECT AT THE CHARLEST BHALL FORWARD THE ASSEMBLY SHALL BHALL B
- 47. THE CONTRACTOR SHALL BE RESPONSIBLE FOR THE COMPLETE SECURITY OF THE SITE WHILE THE WORK IS IN PROGRESS UNTIL THE JOB IS COMPLETE.
- 48. THE CONTRACTOR IS RESPONSIBLE TO PROVIDE TEMPORARY POWER, WATER, AND TOILET FACILITIES AS REQUIRED BY THE PROPERTY OWNER OR GOVERNING AGENCY.

- 49. ALL CONSTRUCTION THROUGH THE PROJECT SHALL CONFORM TO THE LATEST C.B.C. AND ALL OTHER GOVERNING CODES, INCLUDING THE CALIFORNIA ADMINISTRATIVE CODES TITLE 8, 19, AND 24. THE MOST RESTRICTIVE CODE SHALL GOVERN.
- 51. WHEN REQUIRED STORAGE OF MATERIALS OCCURS, THEY SHALL BE EVENLY DISTRIBUTED OVER THE FLOOR OR BOOF SO AS NOT TO EXCEED THE DESIGNED LIVE LOADS FOR THE STRUCTURE T-EMPERATY SHORMS OR REACHO SHALL BE PROVIDED WHERE THE STRUCTURE HAS NOT ATRAIGED THE DEDICAL STREAMTH FOR THE CONDITIONS PRESENT.
- 52. THE COMMINITION SHALL SUPERMISE AND COORDINATE ALL WORK, USING HIS PROFESSIONAL INJURIEDCE, AND SIGLIS, HE IS SOLELY RESPONSIBLE FOR ALL CONSTRUCTION MEMOR, METHODES, TECHNOLISE, PROCEDURES AND SCHUENCING AND COORDINATING ALL PORTIONS OF THE WORK UNIQUE THE PROMICE.
- THE CONTINUETOR SHALL BE RESPONSIBLE TO OBTAIN AND PAY FOR ALL PERMITS, FEES AND RESPECTIONS WITH RESPECT TO THE WORN'T COMPRIETE THE PROJECT, MUST PROVIDE CHILD AND THE CONFIDENCE SHALLOWS FERRIL APPLICATIONS BE FILED BY THE OWNER OR AUTHORIZED ACENT. CONTINUETOR SHALL OBTAIN THE AND MALE THAN ANY EARLY OR ADD OCUMENT.
- 54. ALL DIMENSIONS TAKE PRECEDENCE OVER SCALE, DRAWINGS ARE NOT TO BE SCALED UNDER ANY CIRCUMSTANCES.
- 55. THE CONTRACTOR SHALL PROVIDE ALL NECESSARY BLOCKING, BACKING, FRANING, HANGERS OR SUPPORTS FOR INSTALLATION OF ITEMS INDICATED ON THE DRAWINGS.
- THE CONTRACTOR SHALL PROVIDE THE FIRE MARSHALL OR U.L APPROVED MATERIALS TO FILL/SEAL PENETRATIONS THROUGH FIRE RATED ASSEMBLIES.
- NEW CONSTRUCTION ADDED TO (E) CONSTRUCTION SHALL BE MATCHED IN FORM, TEXTURE, MATERIAL AND PAINT COLOR EXCEPT AS NOTED IN THE PLANS.
- THE CONTRACTOR IS TO PROVIDE PORTABLE FIRE EXTINGUISHERS HAVING A MINIMUM 2A-10-BC RATING WITHIN 75F. OF TRAVEL TO ALL PORTRIONS OF THE CONSTRUCTION AREA. [2007 CFC SECTION 906-1-1 & 7 AND SECTION 906-3(1)]
- 59. MATERIALS TESTING SHALL BE TO THE LATEST STANDARDS AVAILABLE AS REQUIRED BY THE LOCAL GOVERNING AGENCY RESPONSIBLE FOR APPRIORING THE RESULTS.
- ALL GENERAL NOTES AND STANDARD DETAILS ARE THE MINIMUM REQUIREMENTS TO BE USED IN CONDITIONS WHICH ARE NOT SPECIFICALLY SHOWN OTHERWISE.
- ALL DEBRIS AND REFUSE IS TO BE REMOVED FROM THE PROJECT CONTINUOUSLY AND PREMISES SHALL BE LEFT IN A CLEAN BROOM FINISHED CONDITION AT ALL TIMES.
- 62. BUILDING INSPECTORS AND/OR OTHER BUILDING OFFICIALS ARE TO BE NOTIFIED PRIOR TO ANY CRADING AND CONSTRUCTION AS MANDATED BY THE COVERNING AGENCY.
- 83. ALL SYMBOLS AND ABBREVIATIONS ARE CONSIDERED CONSTRUCTION INDUSTRY STANDARDS. IF CONTRACTOR HAS A QUESTION REGARDING THEIR EVACT MEANING THE ARCHITECT RESPONSIBLE FOR THE PROJECT SHALL BE MOTIFIED FOR CLARIFICATIONS.
- 64. IT IS THE INTENTION OF THESE DRAWINGS TO SHOW THE COMPLETED INSTALLATION. THE CONTINUETOR SHALL BE RESPONSIBLE FOR ALL TEMPORARY BRACKH, SHORKE, 115, FORM WORK, ETC. IN ADCORDANCE WITH ALL INTONAL STATE AND LOCK ORDINANCES TO SAFELY EXECUTE ALL WORK AND SHALL BE RESPONSIBLE FOR SAME, ALL WORK SHALL BE IN ACCORDANCE WITH LOCAL CORP.
- THE CONTRACTOR SHALL USE ABBULATE MANBER OF SKILLED WORKMEN WHO ARE THORRUBALY TRAINED AND EXPOSEDED IN THE NECESSARY CRAFTS AND WHO ARE COMPLETELY FAMILIAR WITH THE SPECIFIED REQUIREMENTS AND METHODS MEEDED FOR PROPER PERFORMANCE OF THE WORK.
- 68. CONSTRUCTION CONTRACTOR AGREES THAT IN ACCORDANCE WITH EDISPULLY ACCEPTED CONSTRUCTION PRACTICES CONSTRUCTION CONTRACTOR WILL BE REQUIRED TO ASSUME SOLE CONSTRUCTION OF THE PRACTICE AND ASSUME SOLE CONSTRUCTION OF THE PRACTICE AND ASSUME SOLE CONSTRUCTION OF THE PRACTICE AND ASSUME ASSUMED THAT ARE ASSUMED THAT ASSUMED ASSUMED THAT ARE ASSUMED THAT ASSUMED ASS
- GROUNDING SHALL COMPLY WITH SPRINT/NEXTEL GROUNDING STANDARDS, LATEST EDITION AND COMPLY WITH SPRINT/MEXTEL GROUNDING CHECKLIST, LATEST VIDISION, WHEN NATIONAL AND LOCAL GROUNDING CREDES ARE MORE STRINGENT, THEY SHALL GOVERN.
- ALL WORK SHALL COMPLY WITH OSHA AND STATE SAFETY REQUIREMENTS. PROCEDURES FOR THE PROTECTION OF EXCANTIONS, DUSTING CONSTRUCTION AND UTILITIES SHALL BE ESTABLISHED PRIOR TO FOUNDATION INSTALLATION. F TEMPORARY LIGHTNING AND MARKING ARE ESTIMATION BY THE FEDERAL AMATION ADMINISTRATION (FAM.), IT IS THE CONTRACTOR'S RESPONSIBILITY TO MANTAN THE NECESSARY LIGHTS AND NOTIFY THE PROPER AUTHORITIES IN THE EVENT OF A PROPER IN
- ALL WORK SHALL BE ACCOMPLISHED IN ACCORDANCE WITH ALL LOCAL, STATE AND FEDERAL CODES OR ORBINANCES. THE MOST STRINGEN CODE WILL APPLY IN THE CASE OF DISCREPANCIES OR DIFFERENCES IN THE CODE REQUIREMENTS.
- ANY DAMAGE TO ADJACENT PROPERTIES WILL BE CORRECTED AT THE CONTRACTOR'S EXPENSE
- THE CONTINUETOR IS RESPONSIBLE FOR PROVIDING AUPLE NOTICE TO THE BULLDING INSPECTION DEPARTMENT TO SCHEDULE THE REQUIRED INSPECTIONS. A MINIMAM OF 24 MOURS OF NOTICE SHOULD BE ORDER INSPECTION DEPARTMENTS HAVE REQUIRED THAT GROUPS OF TWO OR THREE SITES BE SCHEDULED AT ONE TIME IF POSSIBLE.
- THE COMPLETE BID PACKAGE WICLIDES THESE CONSTRUCTION DRAWINGS ALONG WITH THE SPECIFICATIONS AND TOWER ORNINOCA/ANALYSIS. CONTRACTOR IS RESPONSIBLE FOR REVIEW OF THE TOTAL BID PACKAGE PRIOR TO BID SUBMITHER.
- THE CONTRACTOR SHALL VERIFY LOCATIONS OF ALL EXISTING UTILITIES WITHIN THE CONSTRUCTION LIMITS PRIOR TO CONSTRUCTION,
- CLEARING OF TREES AND VEGETATION ON THE STIE SHOULD BE KEPT TO A IMMANIA ONLY THE TREES MEDISSANY FOR CONSTRUCTION OF THE FACULTIES SHALL BE REDUCED, ANY DAMAGE TO TREES AND VEGETATION OUTSIDE THE LEASED PROPERTY SHALL BE REPARRED BY THE CONTINUES.
- RECORD DRAWINGS: MAINTAIN A RECORD OF ALL CHANGES, SUBSTITUTIONS, ETC., BETWEEN THE WORK AS SPECIFIED AND INSTALLED, RECORD CHANGES ON A CLEAN SET OF CONTRACT DRAWINGS WHICH SHALL BE TURBLE OWER TO THE CONSTRUCTION MANAGER UPON COMPLETION OF THE PROJECT.
- THE CONSTRUCTION SHALL NOT RESTRICT A PRICHOST CLURA AND IMMOSSTRUCTED ACCESS TO MAY MUSTED ON PUREN DISTRIBUTION PACILITIES (POWER POLICE, PALL BOOKE, COLLIDORE), CONTROL OF THE MODIFICATION OF THE MODIFIC
- 77. F APPLICABLE AN APPROVED RESENCE OAS SHUT OFF VALVE OR DICESS FLOW SHUT OFF VALVE WILL BE WALLED ON THE FIRST LOSS LIKE ON THE DOWN STREAM SEE OF THE VALVE WILL BE VALVE OF THE DUTTIENT AND BE RESENT CONNECTED TO THE DUTTIEND OF THE SEADON OF THE DUTTIEND OF THE SEADON OF TH
- 78. PROVIDE DESIGN BY A LICENSED ENGINEER OR ARCHITECT FOR THE (VERTICAL) (SEISMIC/WIND LATERAL) FORCE RESISTING SYSTEM PER (LABC 2306, & 2307, R301.1.0).

SYMBOLS:

× GRID REFERENCE



DETAIL REFERENCE



ELEVATION DEFENDANCE



- - CENTERINE - PROPERTY/LEASE LINE



- GROUND CONDUCTOR

- CONTON CARLE

OVERHEAD SERVICE

(E) MASONET

CONCRETE PARTH EARTH

GRAVEL PARTIES PLYWOOD

SAND WOOD CONTINUOUS

WOOD BLOCKING WARRANCE STEEL

(E) (E) 9 NEW ANTENNA

42 (E) ANTENNA

0 CROUND ROD

TTT GROUND BUS BAI MECHANICAL GRIND, CONN.

፟

E

1 TELEPHONE BOX

從 LIGHT POLF

O FND. MONUMENT SPOT ELEVATION

Δ







NETWORK VISION MIMBTS LAUNCH

AGOURA HILLS LA03XC200

28030 DOROTHY DR AGOURA HILLS, CA 91301 AGOURA HILLS

ISSUE DATE:

02/24/2012

ISSUED FOR:

100%CD's

02/24/12 ISSUED FOR 90% CD REVIEW DAR B D3/13/12 ISSUED FOR 90% CD REVIEW AMF C 03/28/12 100%CD's A 10/8/12 CITY COMMENTS OY A 10/16/12 CITY COMMENTS KW NOT FOR CONSTRUCTION UNLESS LABELED AS CONSTRUCTION SET

LICENSURE:



SHEET TITLE:

GENERAL NOTES & SYMBOLS

BHEET NUMBER:

T-2

REVISION:

 Λ

TABLE OF CONTENTS GENERAL REQUIREMENTS 1.0 PURPOSE AND INTENT 1.1 CONFLICTS CLEANING 1.3 1.4 CODES 1.5 LICENSING 1.6 OSHA 1.7 PHOTOS 1,8 BUILDING PERMITS ZONING REGULATIONS & CONDITIONAL USE PERMITS FAA PERMIT AND TOWER LIGHTING 1,10 TOWER SECURITY 1.11 1.12 SITE CONTROL 2.0 SITE PREPARATION SCOPE OF WORK 2.1 PRODUCT AND MATERIALS 2.2 3.0 COMPACTION 4.0 CHAIN LINK FENCES AND GATES 4.1 GENERAL PRODUCTS AND MATERIALS 4.2 LANDSCAPING 5.0 6.0 CONCRETE FORMWORK 7.0 CONCRETE REINFORCEMENT CAST-IN PLACE CONCRETE 8.0 0.0 STRUCTURAL STEEL

GROUNDING

COMPLY WITH THESE STANDARDS UNLESS OTHERWISE REQUIRED BY APPLICABLE CODES

*GENERAL CONTRACTOR SHALL COMPLY WITH OSHA AND SPRINT STANDARD SAFETY AND CONSTRUCTION PROCEDURES.

1.0 CONSTRUCTION TO CONFORM TO SPRINT NEIGHL INTEGRATED CONSTRUCTION STANDARDS

1.1 PURPOSE AND INTENT A. THE DRAWINGS A PROSE AND INTENT
THE CHARMINGS AND SPECIFICATIONS ARE INTIDIDED TO BE FILLY DIPLAMITORY AND SUPPLICIPATION, HOWEVER, SHOULDE
ANTITIONE BE SOMER, HOUSELD ON SPECIFIED ON ONE AND NOT THE GROUP, IT SHALL BE DONE THE SAME AS YOUNG.
MINISTRUCTURE OF BETTI SHOULD THERE BE AND EDICHEMPACES SERVICENT ROUTENESTED SHOWN IN BOTH, THE
THE HISTORY ON THE DOCUMENTS IS TO INCLUDE ALL LABOR AND MATERIALS RESPONSELY RECESSARY FOR THE PROPER
THE HISTORY ON THE DOCUMENTS IS TO MINISTRUCTURE BY THE CONTINUES EXCENSIVE YEAR FOR THE PROPER
THE HISTORY OF THE SHOWN WELLESS CONSTRUCTION SPECIFICATION OF THE MINISTRUCTURE BY THE CONTINUES RECORDED TO COMPLETE THE

MINISTRUCTURE SHOWN WELLESS CONSTRUCTION SPECIFICATIONS OF TO MINISTRUCTURE SECURIOR TO COMPLETE THE

1.2 COMPLETS
AL MEASUREMENTS AT THE SITE BEFORE ORDERING MATERIAL OR DOING MAY WORK. NO DOTAL CHARGE OR
A COMPOSENCY WILL BE ALLORED DUE TO DEPTUDENCES SETTED ACTIVAL ORDERINGS OR ORDERIORS SHOWN ON PLANS.
SUBJECT MOTICE OF ANY DESCRIPANCY IN DEPOSIONS OR OTHERWISE. TO STRIPM WELLESS FOR RESOLUTION SETTING
PRODUCES WITH THE WORK.

IN THE PRODUCE OF THE PRODUCE MATERIAL DUE OF DEPTUDATES OF CONTINUES THAT MAY BE INCOMMENTED.

IN THE PRODUCE OF THE PRODUCE MATERIAL DUE OF THE BOOK WAS AN EXCUSE FOR ANY
FALURE OR OMISSION ON THE PART OF THE CONTINUE OF THE BOOK MAY
CONSTRUCTION DOCUMENTS CONTENIOR THE WORK.

1.3 CLEARNO MEEP THE STE FREE FROM ACCUMULATION OF WASTE AND RUBBISH CAUSED BY EMPLOYEES AT THE COMPLETION OF THE WORK, REMOVE ALL WASTE AND NON-CONSTRUCTION MATERIAL BIOLIDING ALL CONTRACTOR TOOLS, SOUTFOLDING AND SURPLUS MATERIAL AND LEAVE SITE CLEAN AND READY FOR USE.

1.4 CODES ES
CONTRACTOR SHALL BE RESPONSIBLE FOR FOLLOWING ALL LAWS, REGULATIONS AND RULES PROMULGATED BY FEDERAL
STATE AND LOCAL AUTHORITIES WITH JURISDICTION OVER THE SITE. THIS RESPONSIBILITY IS IN EFFECT REGARDLESS OF
WANTHER THE LAW. ORDINANCE. REGULATION OR RULE IS INSTITUTED IN THESE SPECTATIONS.

1.5 LICENSING
HAVE AND MARTAN A VALID CONTRACTORS LICENSE FOR THE LOCATION IN WHICH THE WORK IS TO BE PERFORMED. FOR
THAT LECENSE MONOBAL TRACES, THE TRUCESSAM OR SUBGONITACTORS FERTOMENO TROCE TRACES SHALL BE LECENSED.
THE LICENSE OCCUPY THIS LECENSED LICENSE PAY LECENS FEEL, AND SELECT AND PROPER SHAPPING CONTRACTORS RECOVERED.

A DELLOW ALL APPLICABLE RULES AND REGULATIONS OF THE OCCUPATIONAL SAFETY AND HEALTH ADMINISTRATIONS, AND STATE LAWS BASED IN THE FEDERAL OCCUPATIONAL SAFETY AND HEALTH ACT, THESE REGULATIONS INCLIDE BUT ARE NOT HEALTH ACT, THESE REGULATIONS FOR AND WORK IN CONTRIBUTION AND SAFETY, DECIVATIONS FOR MOVE RECOVERY, DECIVATION SAFETY, DECIVATIONS AND REPLOYER, AND WORK IN CONTRIBUTION. AND WORK IN CONTRIBUTION.

1.7 PHOTOS
PROVOE PHOTOGRAPHIC EVIDENCE OF ALL FOUNDATION INSTALLATION, GROUNDING AND TRENCHING AFTER PLACEMENT OF UTLITIES PRIOR TO BACKFALL.

1.5 BULDING PERMITS WILL SUBMIT CONSTRUCTION DOCUMENTS TO THE AURISMICTIONAL AUTHORITY FOR PLAY CHECK AND SPRINT WEELESS WILL SUBMIT LCCISION AND DREAMING COMPRISATION REFORMATION TO THE AURISMICTION AS REVERS. CONTRACTOR WILL SUBMIT LCCISIONATE AURICACIONAL AND OPERATE RECORDED RESPECTIONS AND PORT REQUIRED PERMITS AT THE JOB STEE COMPAY WITH SPECIAL PROJECT—RELATED REQUIRED HAMBORITY AND SHOPE AND STORM TO ANY SHOPE ANY SHOPE WITH A SHOPE OF THE CONTRACTOR OF PROVINCE AND PROPRIES CONSTRUCTION DOCUMENTS. SPRINT WRELESS WILL REMBURSE THE CONTRACTOR FOR FESS FOR PLAY REVERS, BUILDING FORM, CONSTRUCTION AND SHOPE PROVINCES.

1.9 ZOMING REQUIATIONS AND CONDITIONAL USE PERMITS SPIRIT WIRESS MILL SUBRIT FOR AND OUTAIN ALL ZOMING AND CONDITIONAL USE PERMITS, SOME USE PERMITS MAY HAVE SPECIAL RECOVERABLES RELATED THE CONSTRUCTION SUCH AS NOCK REQUIATIONS, HOURS OF WORK, ACCESS LAMIATIONS, ETC. THE CONSTRUCTION MANAGEM WILL IMPORT THE CONTINUETOR OF THESE REQUIREMENTS AT THE PRE-BID METTING OR AS SHOWN IN CONSTRUCTION OUTCOMED.

1.10 FAA PERMIT AND TOWER LIGHTING
REFER TO CONSTRUCTION DOCUMENTS AND CONSTRUCTION MANAGER FOR FAA AND STATE LIGHTING REQUIREMENTS
CONTRACTOR SHALL PROVIDE TEMPORARY FAA APPROVED LIGHTING UNITE PERMANENT LIGHTING IS OPERATIONAL.

1.11 TOWER SCURRIY
THOSE MAST BE FENCED, TEMPORARELY OR PERMANENTLY WITHIN 24 HOURS OF ERECTION, DO NOT ALLOW THE GATE ACCESSING THE TOWER AREA TO BEAUM OPEN OR UNATTENDED AT ANY TIME FOR ANY REASON, MEEP THE GATE CLOSED AND LOCKED WHEN NOT IN USE.

1.12 SITE CONTROL

A THE CONTRACTOR IS COMPLETELY RESPONSIBLE FOR CONTAINABLET OF
SCHOOL AND CONTROL OF DROSSON AT THE SITE, ANY DAMAGE TO ADMICENT OR DOWNSTREAM PROPERTIES WILL BE
CORRECTED BY THE CONTRACTOR AT NO EMPONE

B. THE CONTRICTOR IS TO MARTIAN ADDIGITE FOOD PROMINED AT MAI, THESE, DO NOT ALLOW MUTER TO STAND OR PODI ON MAY PORTION OF THE FOOD, AND PROMICE TO STRUCTURES OR WORK OF THE STEE CLUSED BY WINDEGUALT MARTIDANCE OF NOOF PRIMAMEE PROVIDENCE MELL BY THE RESPONSIBILITY OF THE CONTRICTOR AND ANY COST ASSOCIATIO WINT REPAIRS FOR SUCH CHAMGE MELL BET THE CONTRICTION'S EXPENSE.

C. ALL WASTE MATERIAL SHALL BE PROPERLY DISPOSED OF OFF-SITE OR AS DIRECTED BY THE CONSTRUCTION MANAGER AND IN ACCORDANCE WITH JURISDICTIONAL AUTHORITIES.

2.0 SITE PREPARATION

2.1 SCOPE OF WORK INCLUDES.
APPORTECTION OF DISTING TREES, VEGETATION AND LANDSCAPING MATCHALS WHICH MICH IS DAMAGED BY DOMESTRUCTION ACTIVITIES.
TOBARBAC OF EXISTING TREES AND VEGETATION AS REQUIRED FOR PROTECTION LURINO CONSTITUCTION ACTIVITIES.
C. TOPPORT, STEPPARIC AND STOCKPLAND, GESTATION, GESTIGATION, DESCRIPTION TREES, AND STE IMPROVINCIANTS.
C. TUPPORT, STEPPARIC AND STOCKPLAND CONTROL AND DUST CONTROL CONORMAND TO LOCAL REQUIREMENTS AS

E. TEMPORANT ENGOIN CONTROL SELECTION CONTROL AND DEST CONTROL CONTROL TO COMMISSION IN COUNTROL RECOMMENDERS AS A PROJECT PROJECT OF REPORTY. STRUCTURES BEIGNARIOS AND MOMENTES.

F. PROTECTION AND TEMPORATY RELOCATION, STRUCKE AND RE-HISTALLATION OF DUSTING FEMORS AND OTHER SITE MEROPACHAGINTS SCHOOLING FOR RELIES.

REMOVEM, AND LEEPA DEFENSAL OF CLEARED MATERIALS.

REMOVEM, AND LEEPA DEFENSAL OF CLEARED MATERIALS.

A MATERIALS USED FOR TREE PROTECTION, ENGINEE CONTROL, SELECTION, SALECTION CONTROL AND DUST CONTROL AS SUTRILE FOR SPECIFIC STEE CONTROL AS SUTRILE FOR SPECIFIC STEE CONTROL.

3.0 COMPACTION

A COMPACT BACKFIL TO A 95 PERCENT COMPACTION AT A MADDIM DAY DENSITY AS DETERMINED BY ASTM D-1557 OR BY MITCH PLUS OR MARK J. PERCENT OF OFFINDEM MICROSTRUCT CONTINUE. THE BACKFILL FROM THE TRENCH OR STRUCTURE, BY PROCESSING PROPERTY OF THE PROCESSING THE STRUCTURE CAN SUBSEQUENT STRUCTURE BACKFILL DURING MANIFORMET PERFOX SHALL BE CONDUCTED THE STRUCT OF MEMORPHY COMPACTION AND SHALL BE PROMETED CONTROLLED THE STRUCT OF MEMORPHY COMPACTION AND SHALL BE PROMETED CONTROLLED.

4.0 CHAIN LINK FENCES AND GATES

PROVIDE CHAIN LINK FENCES AND GATES AS COMPLETE UNITS BY A SINGLE SUPPLY SOURCE INCLIDING NECESSARY ERECTION ACCESSORIES, FITTINGS AND FASTENERS.

4.2 PRODUCTS AND MATERIALS (AS APPROVED BY CONSTRUCTION MANAGER OR AS WITHIN CONSTRUCTION DOCUMENTS)

COMPOUND FABRIC B4 INCHES HIGH AND OVER WITH Z-INCH MESH SHALL BE KNUCKLED AT ONE SELVAGE AND TWISTED AT THE OTHER.
STEEL FABRIC: SILEL VARIAGE.

SOMELY WITH CHAIN LINK FENCE MANUFACTURERS INSTITUTE (CLFM) PRODUCT MANUAL FURNISH ONE PIECE OF FABRIC WIDTHS. WIRE SIZE INCLUDES ZINC OR ALLMINUM COATING.

PALIMENTAL CONTROL.

SETT. 2—NOT MESH 9 GALICE (D.148—SICH DAMETER) WIRE.

GALVARETO STEEL PRISS ASTA A 392. CLASS 2. WITH A LINGUIM 2.0 OZ. ZINC PER SQ. FT. OF UNCOATED WIRE SURFACE.

MEMORIER AND ACCESSION OF THE PRISS ASTA A 392. CLASS 2. WITH A LINGUIM 2.0 OZ. ZINC PER SQ. FT. OF UNCOATED WIRE SURFACE.

C. FRANCHISCHE AND ACCESSIONES.

C. FRANCHISCHE AND ACCESSIONES.

1. CRISINA MARKACTURES SECURIS CONTROL TO THE CHAPLE OF THE CHAPLE OF THE STATE OF THE ST

G CATES:
COMPLY WITH ASTM F GOD, PROVIDE HARDWARE AND ACCESSORIES FOR EACH GATE, GALVANIZED PER ASTM A 153, AND IN ACCORDANCE WITH THE

HANCES: NON LETT- OFF TYPE, OFFSET TO PENAIT SO DEC, ONTE OPDISING.
LATION: MIS MAJT--LOCIONE DEWCE MT-CONTY ON APPROVED EQUAL.
LATION: MIS MAJT--LOCIONE DEWCE MT-CONTY ON APPROVED EQUAL.
KEEPER PROVIDE KEEPER FOR VEHICLE CATES, WHICH AUTOMATICALLY ENGAGES CATE LEAF AND HOLDS IT IN OPEN POSITION UNTIL MANUALLY
REGLESCO.

F. CONCRETE: CONSISTING OF PORTLAND CEMENT, ASTM C 150, AGGREGATES ASTMC 33, AND CLEAN WATER, MIX MATERIALS TO OBTAIN CONCRETE WITH A MYNDAM OF 28-DAY COMPRESSIVE STRENGTH OF 3000 PSI.

5.0 LANDSCAPING

A. FURNISH, INSTALL AND MAINTAIN LANDSCAPE WORK AS SHOWN AND OR REQUIRED WITHIN THE CONSTRUCTION DOCUMENTS OR AS SPECIFIED IN THE SPRINT WIRELESS CONSTRUCTION SPECIFICATIONS,

8.0 CONCRETE FORMWORK

FORMS: SMOOTH AND FREE OF SLRFACE RREGULARITIES. UTILIZE FORM RELEASE AGENTS.
CHAMPER: DOPOSED EDGES OF ALL TOWER FOUNDMINONS SHALL RECEIVE A 3/4" BY 3/4" 45 DEGREE CHAMPER. OTHER EXPOSED EDGES SHALL RECEIVE
A TOOLD ANGER FREIN.
UPON COMPLITION, RESIDON ALL FORMS, ANGLUONO THOSE CONCEALED OR BURRED.
RECEIR TO STRUCTURAL DIAMMENTS FOR ADMINISHAL RECOMPRISHMENT.

7.0 CONCRETE RENETINGEMENT.
REFER TO STRUCTURAL DRAWINGS FOR ALL REQUIREMENTS.

8.0 CAST IN PLACE CONCRETE

O CAST, IN PLACE CONCRETE (FOOTINGS, FOUNDMONDS, ETC.), REPER TO STRUCTURAL DAMPINGS FOR REQUIREMENTS, FOR MAY MEGCILLARICUS CONCRETE, FOR STRUCTURAL CONCRETE (FOOTINGS, FOUNDMOND AND ASSOCIATION MAYOR).

8. MARKAIN COMPRESSAYS STRUCTURAL (FV.) AT 28 DAYS 4000 PS FOR TOWER FOUNDMOND AND 3500 PS FOR ALL OTHER CONCRETE UNLESS SYNCHEMEN IN CONSTRUCTION OF THE CONCRETE UNLESS SYNCHEMEN IN CONSTRUCTION OF THE CONCRETE UNLESS SYNCHEMEN IN CONSTRUCTION OF THE CONSTRUCTION OF THE CONCRETE UNLESS SYNCHEMEN AND THE CONSTRUCTION OF THE CONCRETE UNLESS OTHERWISE WOTH DISTORMENT OF CONCRETE UNLESS OTHERWISE WOTH DISTORMENT FOR MAYOR AND AND ASSOCIATION OF THE CONSTRUCTION OF THE CONCRETE UNLESS OTHERWISE WOTH DISTORMENT FOR MAYOR AND AND ASSOCIATION OF THE CONCRETE UNLESS OTHERWISE WOTH DISTORMENT FOR MAYOR AND AND ASSOCIATION OF THE CONCRETE UNLESS OTHERWISE WOTH DISTORMENT OF THE PROPORTION OF CONCRETE UNLESS OTHERWISE WOTH DISTORMENT WOTH ON THE CONCRETE UNLESS OTHERWISE WOTH DISTORMENT WOTH ON THE PROPORTION OF AND ASSOCIATION OF A CONCRETE UNITED BY CONCRETE UNITED THE PROPORTION OF CONCRETE UNITED BY CONCRETE UNITED BY CONCRETE UNITED THE PROPORTION OF A CONCRETE WOTH ON THE PROPORTION OF A CONCR

ROCK POCKETS, HONEYCOUR, SAND STREAMS, DEBRIS AND VOIDS: CUT OUT AT LEAST 1 INCH DEEP WITH SIDES PERPENDICULAR TO SURFACE. FLUSH THOROUGHLY WITH CLEAN WATER, COURT SURFACE WITH WEAT CEMENT PASTE AND TAMP TO OVERPULL WITH DRYPACK IN AT LEAST TWO LAYERS. CURE FOR 10 DAYS AND HOME FLUSTED AND SMOOTH.

C. CONTRACTOR SHALL NERBY ALL SIZES AND LOCATIONS OF ALL ILLEGERICAL OFFININGS AND COMMENTAL FIRST AND SWITH THE ILLCETRICAL DEMANDES AND SHOP DEMANDES. IT SHALL BET REPERFORMENT OF THE CONTRACTOR TO PREMISE ALL OFFININGS AND SIZESES FOR PROSTRESSITION FOR ALL UTLITIES. CONTRIGUED SHALL REFER TO DEMANDES OF OTHER TRADES AND VERBOR DAWNINGS FOR EMBEDDED THIS AND RECESSES AND SHOWN ON STRUCTURAL DEMANDS AND STRUCTURAL OFFININGS.

9.0 STRUCTURAL STEEL

MEET OR ENDED MANUFACTURER'S RECOMMENDATIONS.

A. LIMILESS OTHERWISE NOTED, ALL DETAILING, FABRICATION AND PLACING OF REINFORCING STEEL SHALL CONFORM TO THE MANUAL OF STANDARD PRACTICE

A DIGES CHERRISS WITTO, ALL DELIGIARY, PARKETISM AND PLACENC OF HEAD OCCURS STREET, SHALL CURR UNION TO THE MANUAL OF STANDARD PROCESS.

TO RESIDENCE REPORTED CONCENTES STREETINGS (ACL 315), OR STANDARD STREET, SHALL EXPONENCE TO STANDARD STREETING TO STANDARD STREETING STREE

10.0 GROUNDING

MEET ALL APPLICABLE CODES, REQUIREMENTS OF THE CONSTRUCTION DOCUMENTS AND SPRINT WIRELESS CONSTRUCTION SPECIFICATIONS.



Alcatel-Lucent



PROJECT INFORMATION:

NETWORK VISION MARTS LAUNCH

AGOURA HILLS LA03XC200

28030 DOROTHY DR AGOURA HILLS, CA 91301 AGOURA HILLS

ISSUE DATE:

02/24/2012

ISSUED FOR:

100%CD's REVISIONS REV. DATE A 02/24/12 ISSUED FOR 90% CD REVIEW

DAR B 03/13/12 ISSUED FOR BOX CD REVIEW AMF C 03/28/12 100%CD's DY A 10/8/12 CITY COMMENTS DY A 10/18/12 CITY COMMENTS ICM

NOT FOR CONSTRUCTION UNLESS LABELED AS CONSTRUCTION SET

LICENSHIPE



SHEET TITLE:

GENERAL NOTES

SHEET NUMBER:

REVISION:

T-3



BATTERY INFORMATION /NOTES: MATTERY MEG.: EAST PEDIN MANUFACTURING 12AR-145L

2.17 GALLONS PLECTROLYTE CONTENT PER BATTERY: ELECTROLYTE HAZARD CLASSIFICATION PER "07 C.F.C. (8.7 % SULFURIC ACID):

Mo. OF BATTERES TO BE INSTALLED: THEM ELECTROLYTE CONTAINED

ON SITE (2.17 x 20 = 43.4): 43.4 CALLONS MAX. A CUMPITIES OF 500 CAL OR LESS ARE EXEMPT PER TABLE 3—E OF THE 1897 U.B.C.

8. SINGLE VESSEL CAPACITIES OF 20 GAL, OR LESS, AND ACCRECATE QUANTITIES NOT IN EXCESS OF 100 CAL, ARE EXEMPT PER ARTICLE 64 OF THE 2007 C.F.C.

QUANTITIES LESS THAN 50 GAL ARE EXEMPT FROM C.F.C. ARTICLE 80, MID SHALL NOT REQUIRE PERMIT.

MAY CHANGES OR ADDITIONS TO WITH 2007 C.F.C. MITCLE 64, AND SHALL NOT CONTAIN ELECTROLYTE QUANTITIES IN EXCESS OF 50 GENERATOR ACCESSORES
1. MAIN LINE CONCLUT BREAKER-100 AMPS,
INSTALLED ON GENERATOR
2. VOLTAGE REGULATOR ±2%
3. SAFEGUARD BREAKER

ENGINE FLECTRICAL ACCESSORIES

1. ELECTRONIC/SSICHRONICUS COVERNOR

2. BATTERY RACK, CABLES AND STATING
BATTERY STSTEM-LEAD ACID TYPE

3. BATTERY CHARGER-AUTOMATIC 8 AMP
DISTRIC

DEFENSION ABBREVIATION DEFENITION ABBREVIATION ANCHOR BOLT

ANTIONAL DELLE COMER ASSEMBLY
ANTIONAL DELLE COMER ASSEMBLY
ANTIONAL DELLE COMER ASSEMBLY
ANTIONAL DELLE
ANTIONAL DELLE
ANTIONAL DELLE
ANTIONAL
ANTIONAL NICHOR BOLT ABOOK FOR A MATERIAL AND A MATERIAL

FLOOR STATES OF CONCRETE FOUNDATION FACE OF SMSOMRY FACE OF STUD FACE OF STUD FACE OF SML FROM SMALL FROM SMALL FROM SMALL CIRCLING SMALL CIR IE (MEZE(O) HEIGHT ISOLATED COPPER GROUND BUS NOMES OF THE CONTROL OF T SOMETHING STATES OF THE STATES

ARBREVIATION DEFENTION POWER (CARPAT)
OANTITY
OANTITY Sprint*

Alcatel-Lucent



PROJECT INFORMATION:

NETWORK VISION MMBTS LAUNCH

AGOURA HILLS LA03XC200

28030 DOROTHY DR AGOURA HILLS, CA 91301 AGOURA HILLS

ISSUE DATE;

02/24/2012

ISSUED FOR:

5

3

100%CD's REVISIONS A 02/24/12 ISSUED FOR 90% CD REVIEW B 03/13/12 ISSUED FOR BOX CD REVIEW C 03/29/12 100%CD's DY A 10/8/12 CITY COMMENTS DY A 10/18/12 CITY COMMENTS ICM

NOT FOR CONSTRUCTION UNLESS LABELED AS CONSTRUCTION SET

LICENSURE:



SHEET TITLE:

SIGNAGE, NOTES, & ABBREVIATIONS

SHEET NUMBER:

|-4

⇭

REVISION:

FIRE DEPARTMENT NOTES:

A. FIRE DEPARTMENT FINAL INSPECTION REDURED. SCHEDULE INSPECTION 2 DAYS IN ADVANCE. B. A CFC PERMIT TO OPERATE BATTERY SYSTEMS WITH STATIONARY LEAD-ACID BATTERIES IS NOT REQUIRED FO THE QUANTITIES ON SITE.

C. A CFC PERMIT MAY BE REQUIRED FOR THE HAZARDOUS MATERIALS ON SITE.

D. A HAZARDOUS MATERIALS IDENTIFICATION SION IS REQUIRED FOR ALL ENTRANCES INTO BATTERY STORAGE AREAS. LETTERS MUST BE AT LEAST 1." IN HEIGHT AND IN A COLOR WINGCH CONTRASTS TO THE MACKINGHAID OF THE SION AND LIST THE FOLLOWING.

CLASS 1 WATER REACTIVE LIQUID
TOXIC LIQUID
CORROSIVE LIQUID
OTHER HEALTH HAZARD LIQUID

E. AN APPROVED METHOD TO NEUTRALIZE SPILLED ELECTROLYTE SHALL BE PROVIDED IN THE BATTERY ROOM.

F. BATTERIES SHALL BE PROVIDED WITH SAFETY VENTING CAPS.

I. EXIST DOORS SHALL BE ABLE TO OPEN FROM THE INSIDE WITHOUT THE USE OF KEY OR ANY SPECIAL KNOWLEDGE OR EFFORT. J. ADDRESS NUMBERS SHALL BE A MINIMUM B INCHES HIGH AND PLAINLY VISIBLE FROM ROADWAY BUILDING IS ADDRESSED ON.

K. REQUIRED SIGNAGE SHALL INCLUDE LETTERING HEIGHT OF AT LEAST ONE RICH, IN A COLOR THAT CONTRASTS TO THE SIGN BACKGROUND, AND SHALL BE PROMINENTLY DISPLAYED.

L. REQUIRED SIGNAGE SHALL INCLUDE, BUT MAY NOT BE LIMITED TO, APPLICABLE TYPES FROM EXAMPLES SHOWN MEREN (SEE SIGNAGE).

ABBREVIATIONS

WARNING

THIS FACILITY CONTAINS **CORROSIVE LIQUID** TOXIC HOUID **CLASS 1 WATER REACTIVE LIQUID**



HAZARDOUS MATERIAL SIGNAGE

BATTERY INFO & FIRE DEPT NOTES

IN CASE OF **EMERGENCY** - CALL -

1-866-400-6040

SITE NUMBER: LA03XC200 **AGOURA HILLS** SITE NAME:

EMERGENCY CONTACT SIGNAGE



Paredress land over



this point may exceed the FCC general public exposure limit. Obey all pected signs and site go for working in radio frequency

to a place our topog? and, or gray before



and this point: tadio frequency fields at this site acced the FCC rules for human

Pullars to obey all posted signs and site galdelines for working in radio frequency environments could result in sectors in


SITE IDENTIFICATION SIGNAGE


RF SIGNAGE


MAKITON CONTAINED IN THIS SET OF CONSTRUCTION DOCUMENTS IS PROPRIETARY BY NATURE. ANY USE OR DISCLOSURE OTHER THAN THAT WHICH RELATES TO CARRIER


2

4

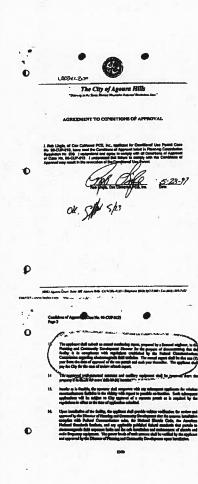

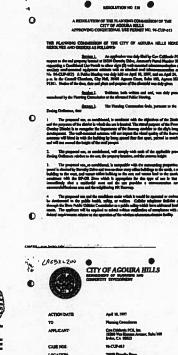

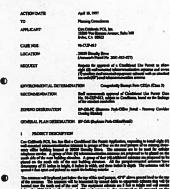

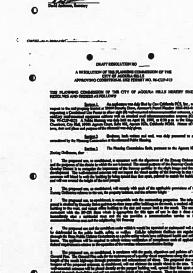



STANDARD CONDITIONS

This distillan, or any separate of this distillan, san be appended up the Chy Council white Blass (13) days from the date of this station, religion to Blag the appropriate forum and cultural flows.

Chapt or stackful banks, the appeared of this action in Statest on and response complemental states in the appeared the Plan, Start Plan, Chroster Plan, and Assessed Description Plan.

This estant skall was be effective the sale program small the applicate and proposity green has append in a filling that applicate and programs process as former of, and company at Canadalana Approved of this process with the Department of Floreing and Community Development.

 It is broke distinct in to do time the Funy problem of this point is held or declared brokel, the punit shall be well and depth these permit browneds shall be use.
 It is faither declared and mode a Combition of the patien that Funy Combine broke is whenty the punit shall be required and the publican permit between shall be provided the trappings the brokel place without allow it can make delation and the Made

 All reprises of do Sorbig Different and the spottle resing of the shifted property or for complete with retires say fired in the Condessed Marriage.

The applicant shall shade all simplest possible for the project them the Department of Buildings and Strings.
 Operation of the use shall use the greated until all Conditions of Approved have been complete.

 Union this possit is used width two (3) years flow the date of City approved, Conditional U. Formit No. 99-(CSF-013 shall explor.

SPECIAL CONDITIONS

 The animous shall be painted to match the spender building order as approved by the Dispute of Florida and Companies Development.

11 No winn or mikin shall be wishin you the quarter of the building. All when not orbite shall be because building the mikeling purepat.

The applicant shift hand a mail shifting before the real-mounted applicant solitons, or a mounter applicant of the Belleter of Fluidage and Contractly Directory, and the Department of Bullifory and Solito.

•

STANDARD CONDITIONS

This decision, or any aspects of this decision, can be appealed to the City Countly within falson (130 days from the store of this across, edgest to Elegy the appropriate forms and estimat

2 Every to continue havin, the approval of the order is fined to and experient complex final continues to the approval file Figs. Bool Figs. Executes Figs. and Assamin Description

3 This action that our for effective for any purpose real the applicat and pumping moure house specific in which the registrant and populary moure for an armount of an armount, all Constitutes of Appendix of this passes with the Department of Franching and Constrainty Development

4 Is a body declard to be the best due of any position of the proper is held or declared model, the proof which we detect the problems greated between the lates.

5. In a finishe declared and made a Confirm of the proper size of our Confirm have in

je do sa vlább štělý (Alj dapo 4. nář reprisemto of to žemeg Calaman mel de grafife melog af fin nájpez proposy mez to volejsky stáleniom ne také to do Canalama (Ali Pont).

to complete with unders are facilities the Confinence Disk France.

The applicant shell educate all required promote the deep reprise them the Department of Daviding.

Ophesian of the set whether he present sent of Combiness of Appendix has been excepted with an Assembled by the Displace of Paraday and Community Displaces.
 Union this presist is used within time (2) years from the date of Copy approved, Conditional Library.

Using this greats its used whiten time (2) years flow the date of Cap approval, Conditional Like Pennis No. 10-CAP-400 shall employ.

Pl The names shall be passed as suith the exterior habbag cafer as approved by the Discour of Plannag and Community Development

11 No were profess shall be readle on the access of the healing. All view and orders shall be interest factor the entiring proper.

2) The applicant daily leaded entitle before the newtonessed equipment whiteen, in a paper of the paper of

Sprint*

Alcatel-Lucent



CANCELLO DECIMA CANCELLO CA COM MINISTERIO THE JULY COM

PROJECT INFORMATION:

NETWORK VISION MIMBTS LAUNCH

AGOURA HILLS

28030 DOROTHY DR AGOURA HILLS, CA 91301 AGOURA HILLS

ISSUE DATE:

02/24/2012

ISSUED FOR:

		100%CD's	
		REVISIONS	
REV.	DATE	DESCRIPTION	34174
A	02/24/12	ISSUED FOR 90% CD REVIEW	DAF
В	03/13/12	ISSUED FOR 90% CD REVIEW	AM
c	03/28/12	100%CD's	DY
Δ	10/8/12	CITY COMMENTS	ים
A	10/16/12	CITA COMMENIZ	KW

NOT FOR CONSTRUCTION UNLESS LABELED AS CONSTRUCTION SET

LICENSURE:



SHEET TITLE:

ZONING DOCUMENTS

SHEET NUMBER:

REVISION:

T-5



ZONING DOCUMENTS

CONDITIONAL USE PERMIT - NUMBER OF PRODE

ACTION DATE: Yebrany 1,2001 APPLICANT:

CASE NO: 49-CUY-612

GENERAL PLAN DESIGNATION. Business Park-Office Result

DRAFT RESOLUTION NO. --

A RESOLUTION OF THE PLANNING COMMISSION OF THE CITY OF AGOURA HELLS APPROVING CONDITIONAL DES PERMIT NO. 89-CUP-013

THE PLANNING COMMISSION OF THE CITY OF ACCOURA HELLS MERCEY FINDS,

Pennand and they (1) measure-measure automate on un office beliefus. A Polyla high half on Polynny 1, 2001, it 6:20 par, in the Count Churches, City Half. Cour, Sain 162, Agence 1628, California 91 101. Hoster of the disc. the and above

Sprint*

Alcatel-Lucent



PROJECT INFORMATION:

NETWORK VISION MINBTS LAUNCH

AGOURA HILLS LA03XC200

28030 DOROTHY DR AGOURA HILLS, CA 91301 AGOURA HILLS

ISSUE DATE:

02/24/2012

ISSUED FOR:

100%CD's

	REVISIONS	-3-	
DATE	BESCRIPTION	NATINE S	
02/24/12	ISSUED FOR 90% CD REVIEW	DAR	
03/13/12	ISSUED FOR 90% CD REVIEW	AMF	
03/28/12	100%CD's	DY	
10/8/12	CITY COMMENTS	DY	
10/16/12	CITY COMMENTS	KW	
	322		
	02/24/12 03/13/12 03/28/12 10/8/12		

NOT FOR CONSTRUCTION UNLESS LABELED AS CONSTRUCTION SET

LICENSURE:



SHEET TITLE:

ZONING DOCUMENTS


SHEET NUMBER: REVISION





•


ZONING DOCUMENTS


ON CONTABLED IN THIS SET OF CONSTRUCTION DOCUMENTS IS PROPRIETARY BY NATURE. ANY USE OR DISCLOSURE OTHER THAN THAT WHICH RELATES TO CARRIER SERVICES IS STRUCTLY PROHIBITED.

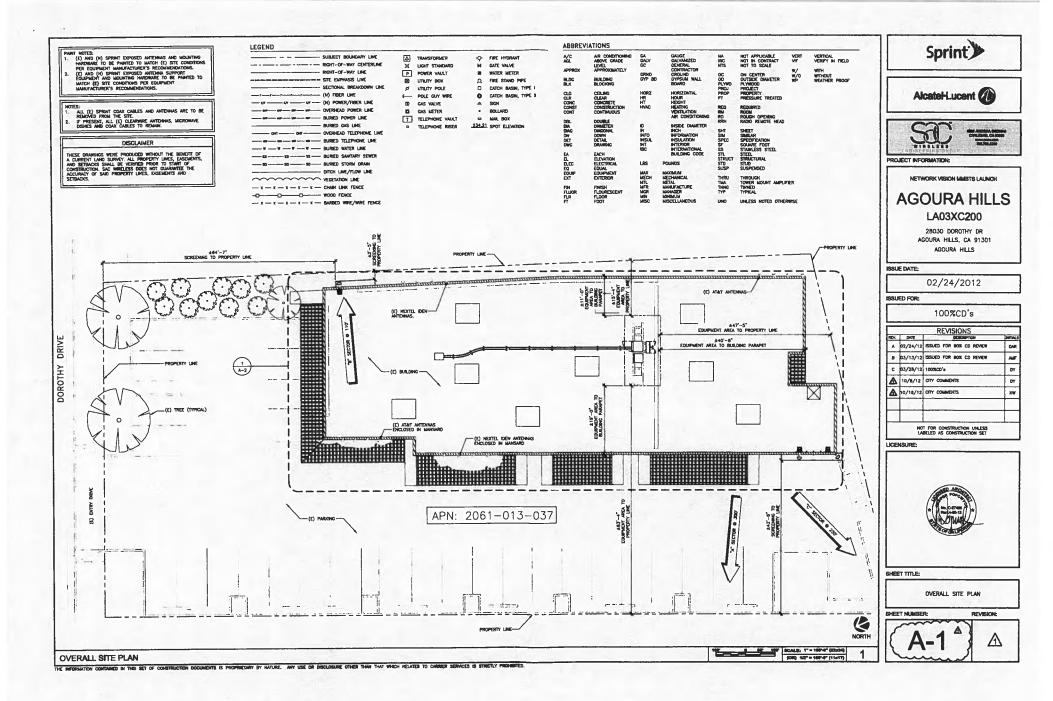


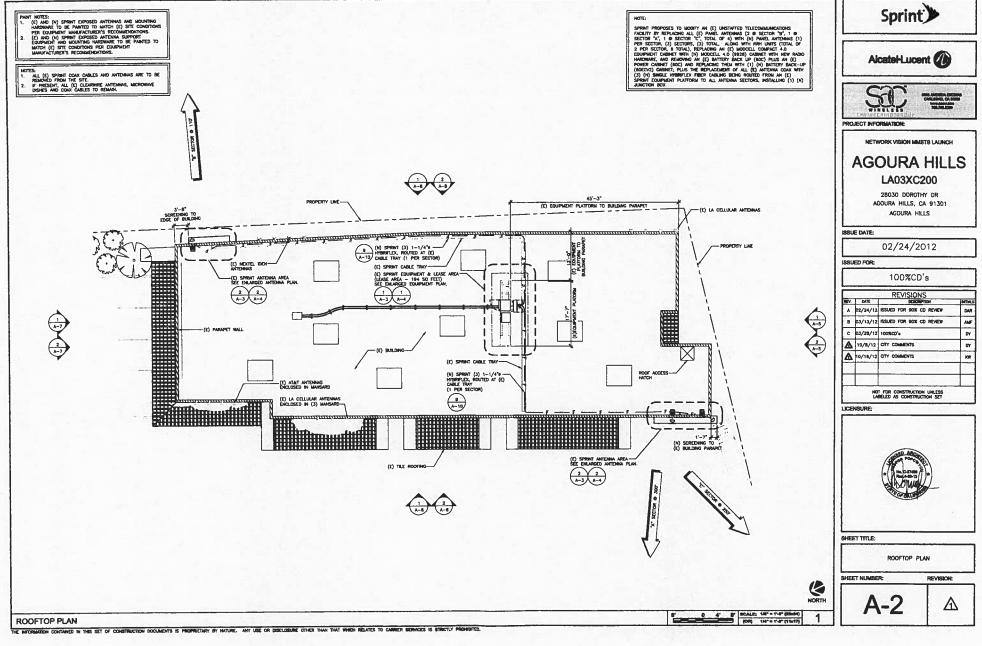


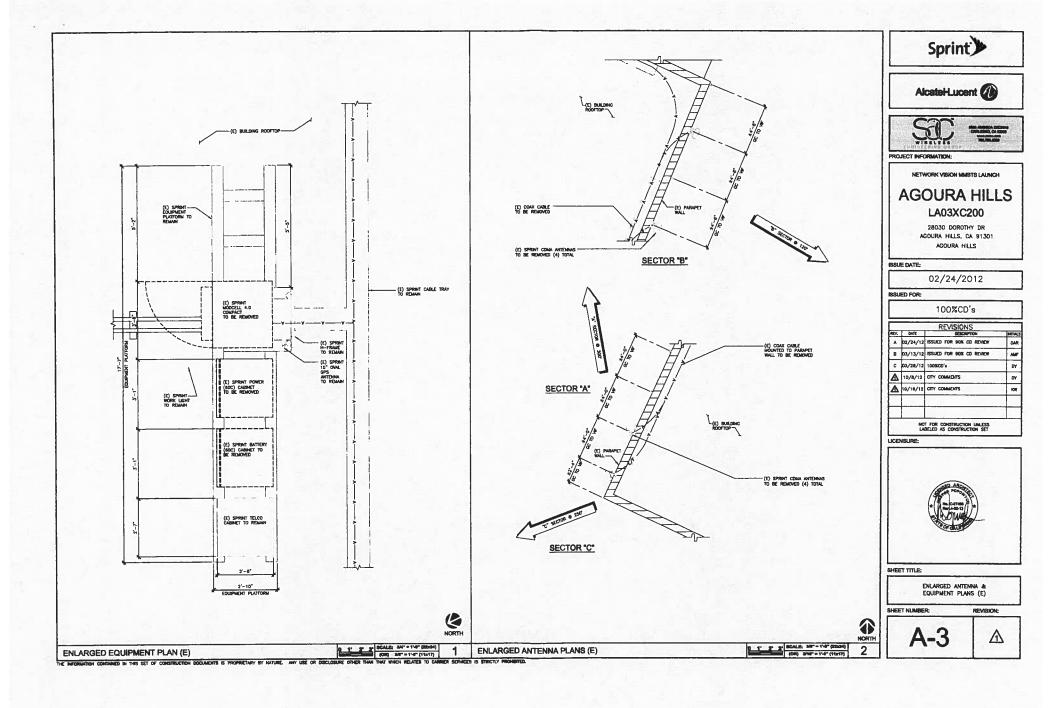


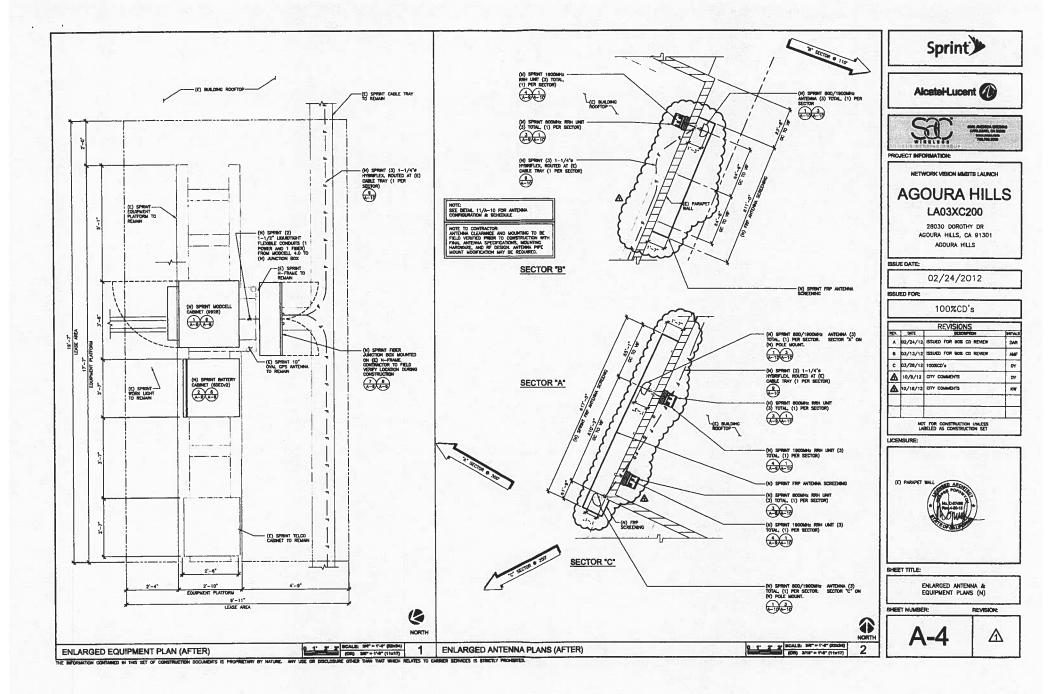


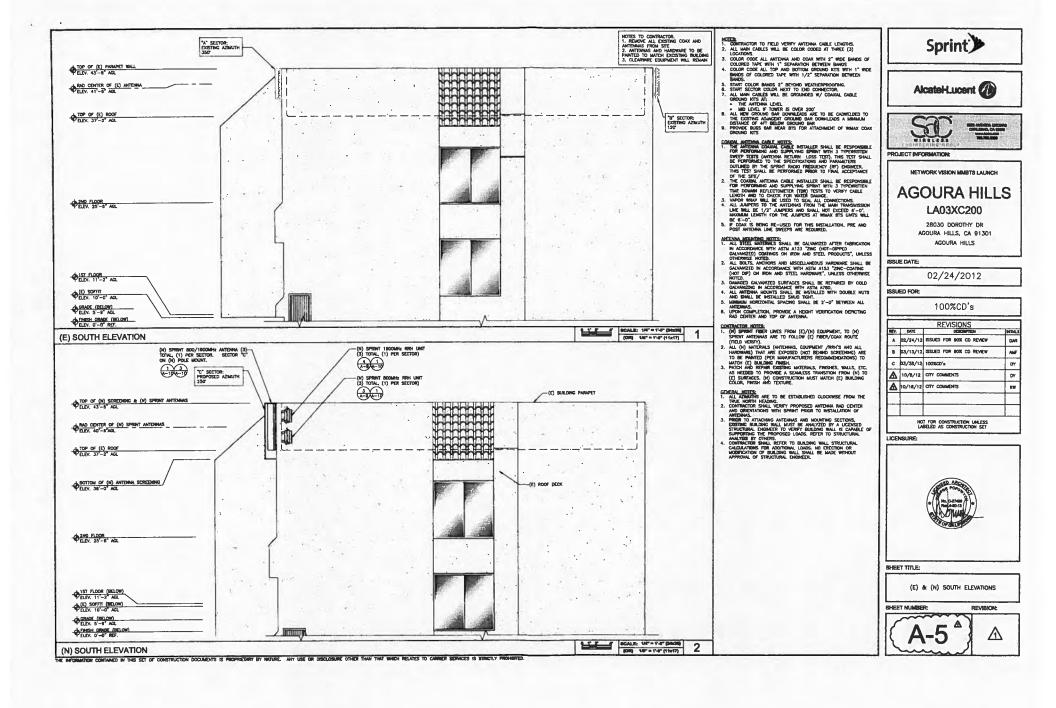


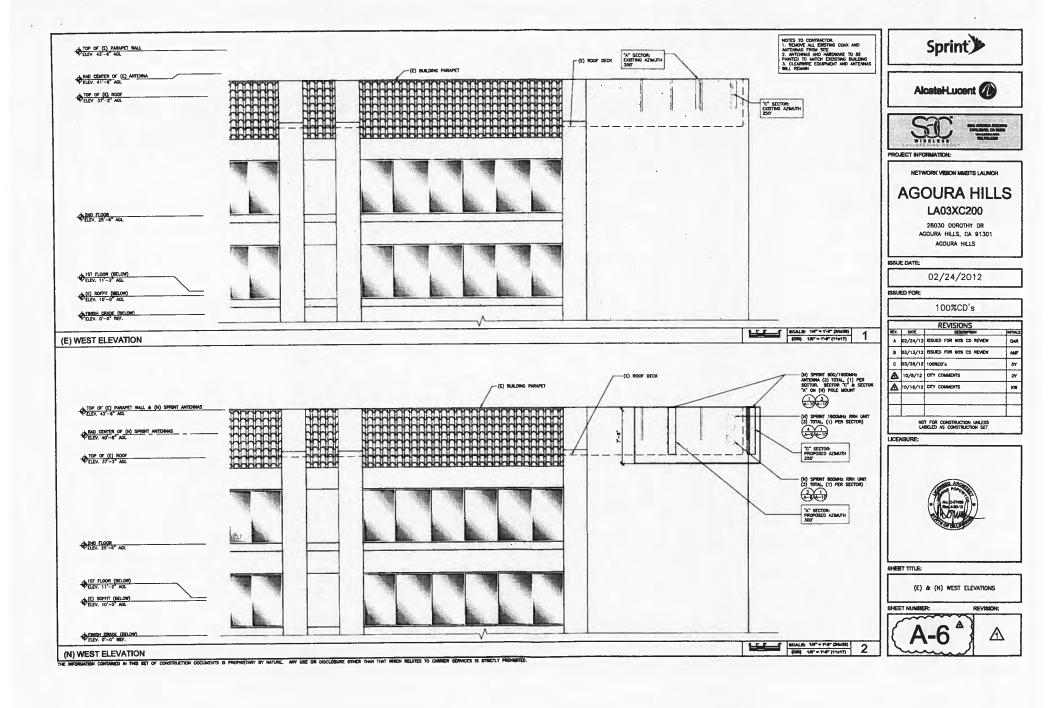

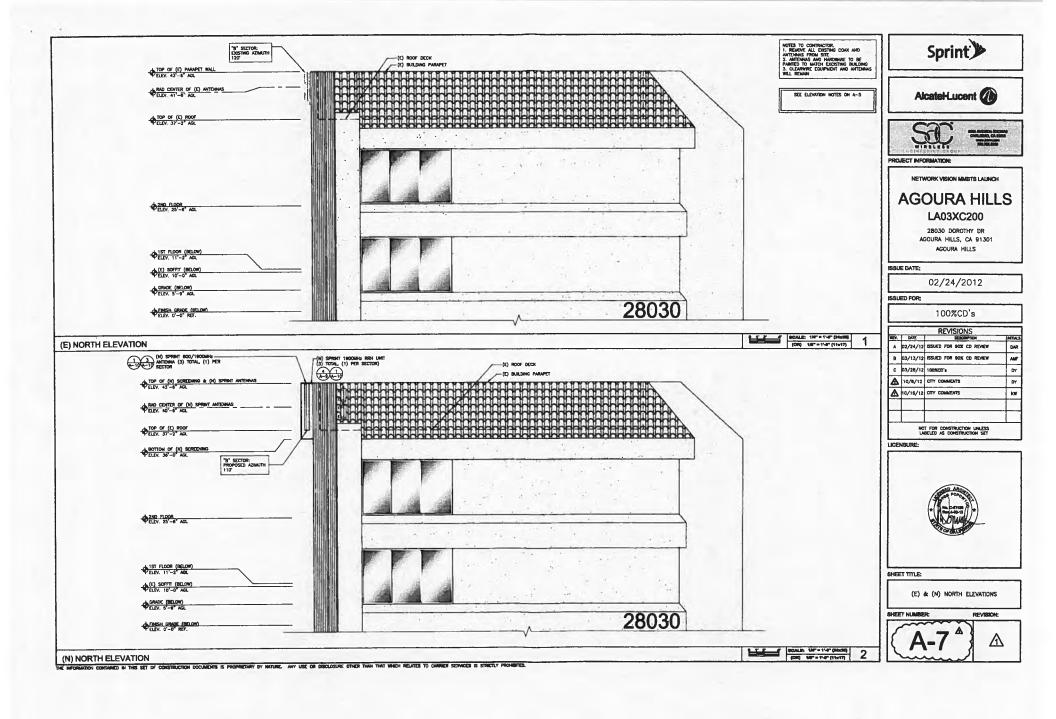


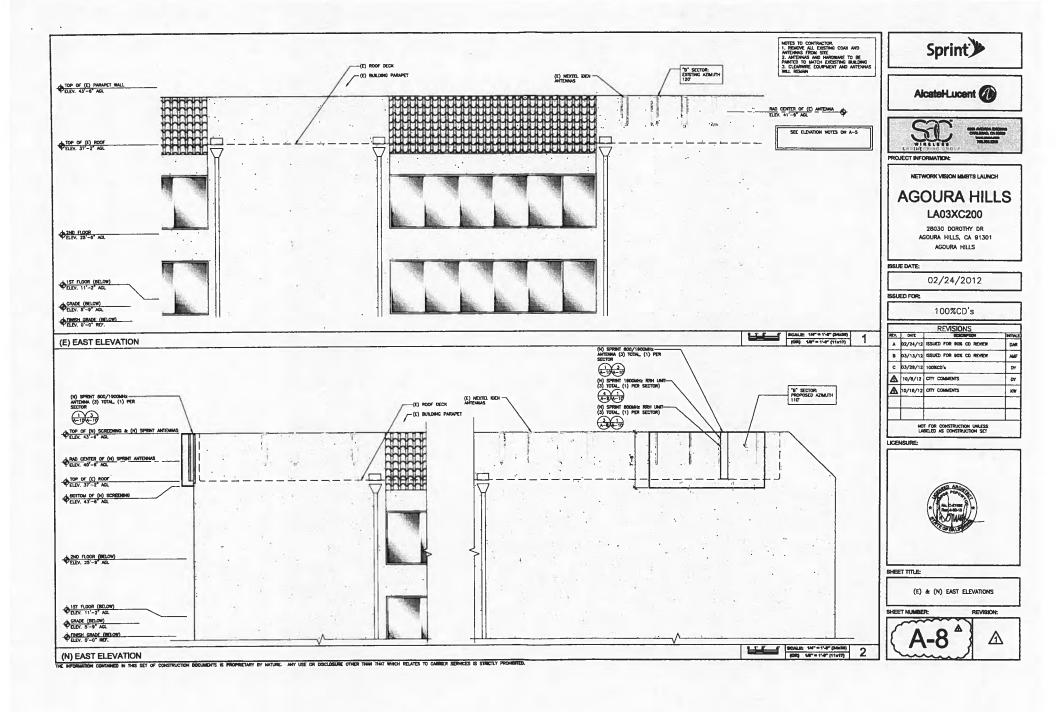

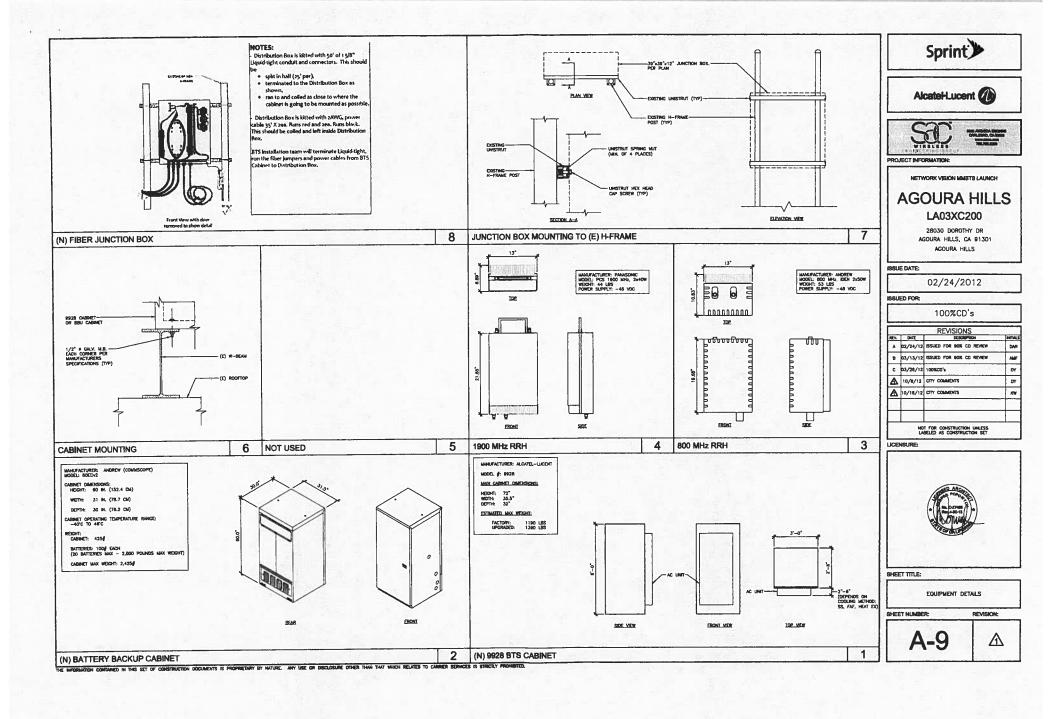

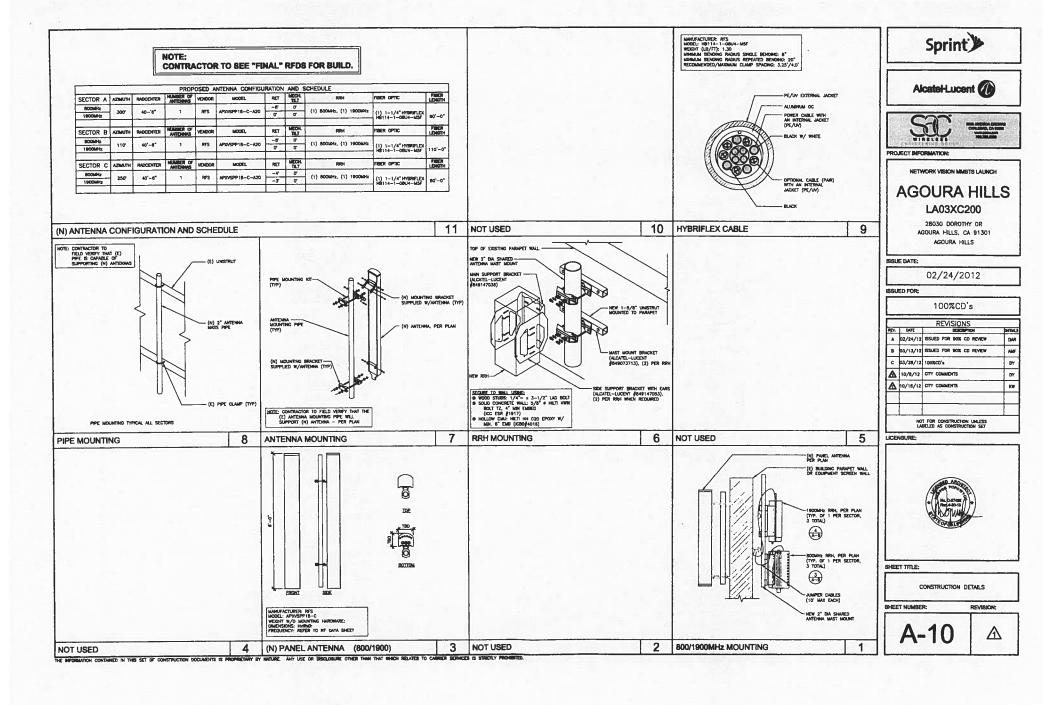



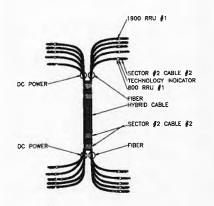

3 HYBRID CABLE COLOR CODE SCALE: N.T.S.

SECTOR	CABLE	FIRST RING	SECOND RING	THIRD RING
1 ALPHA	1	GREEN	NO TAPE	NO TAPE
1	2	SECULIA SE	NO TAPE	NO TAPE
1	3		NO TAPE	NO TAPE
1	4	WHITE	NO TAPE	NO TAPE
1	5	2.01.0	NO TAPE	NO TAPE
1	6	SLATE	NO TAPE	NO TAPE
1	7	PURPE	NO TAPE	NO TAPE
1	8	ORANGE	NO TAPE	NO TAPE
2 BETA	1	OREEN	GREEN	NO TAPE
2	2	PLUE	BALE 1	NO TAPE
2	3	(\$ROWH	(IROW)	NO TAPE
2	4	WHITE	WHITE	NO TAPE
2	5	E ALD	7 线1	NO TAPE
2	6	SLATE	SLARE "	NO TAPE
2	7	PINE	PURPLE	NO: TAPE
2	8	- SPEANSE	DOLLAR ST	NO TAPE
3 GAMMA		GREEN BY	CHECK 5	C . SPEEN
3	2	BINLE	BLUE	HLIE
3	3	a receipt	BROWN AND	Turner.
3	4	WHITE	WHITE	WHITE
3	5	A SECTION AND A		
3	6	SIATE	SLATE	SARE
3	7	HORELS.	PHONE	PURT.
3	8	Day of the state o	DRANGE	DRANGE


4 COAXIAL CABLE COLOR CODE SCALE: N.T.S.

TECHNOLOGY COLOR CODE	FIRST RING	SECOND RING
800 #1	YELLOW	GREEN
1900 #1	YELLOW	100
1900 #2	YELLOW	
RESERVED	YELLOW	
RESERVED	YELLOW	SIATE
RESERVED	YELLOW	OHAHOE
RESERVED	YELLOW	WHITE

2 FREQUENCY COLOR CODE SCALE: N.T.S.

ANTENNA AND CABLE COLOR CODING

(3 SECTORED / MULTIPLE RF CHANNELS)
ASSUMING B LINES AND ANTENNAS

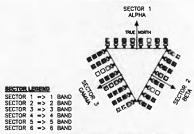

TECHNOLOGY COLOR CODE

II IDEN CDMA

WIMAX

EXAMPLE - SECTOR 2, CASLE 2, 800Mix RADIO #1 EXAMPLE - SECTOR 3. CABLE 1, 1900 EXAMPLE - SECTOR 1, CARLE 4, SSOMM, RADIO #1

COLOR BAND TO BE 2" WIDE ON MAIN LINE.
 SPACING TO BE 1" BETWEEN BANDS AND 2" BETWEEN LINE AND TECHNOLOGY BANDS NO SPACE BETWEEN TECHNOLOGY COLOR BANDS.
 COLOR BAND ON JUMPERS 1" WIDE W/ 1" SPACE.
 START COLOR BANDS 2" BEYOND WEATHERPROPOING.
 START SECTOR COLOR NEXT TO END CONNECTOR.



1 ANTENNA & CABLE COLOR CODE SCALE: N.T.S.



Alcatel-Lucent



PROJECT INFORMATION:

NETWORK VISION MAIBTS LAUNCH

AGOURA HILLS LA03XC200

28030 DOROTHY DR AGOURA HILLS, CA 91301 AGOURA HILLS

ISSUE DATE:

02/24/2012

ISSUED FOR:

100%CD's REVISIONS

REV.	CHATE	DESCRIPTION	INITIALS
Α	02/24/12	ISSUED FOR 90% CD REVIEW	DAR
В	03/13/12	ISSUED FOR 90% CD REVIEW	AMF
c	03/28/12	100%CD's	DY
Δ	10/8/12	CITY COMMENTS	DY
Α	10/18/12	CITY COMMENTS	KW
_			
	NO LA	T FOR CONSTRUCTION UNLESS BELED AS CONSTRUCTION SET	

LICENSURE:



SHEET TITLE:

(N) COLOR CODING


SHEET NUMBER

REVISION:


A-11



THE INFORMATION CONTAINED IN THIS SET OF CONSTRUCTION DOCUMENTS IS PROPRETARY BY HATURE. ANY USE OR DISCLOSURE OTHER THAN THAT WHICH RELATES TO CHRISTIN SERVICES IS STRICTLY PROPRETARY.

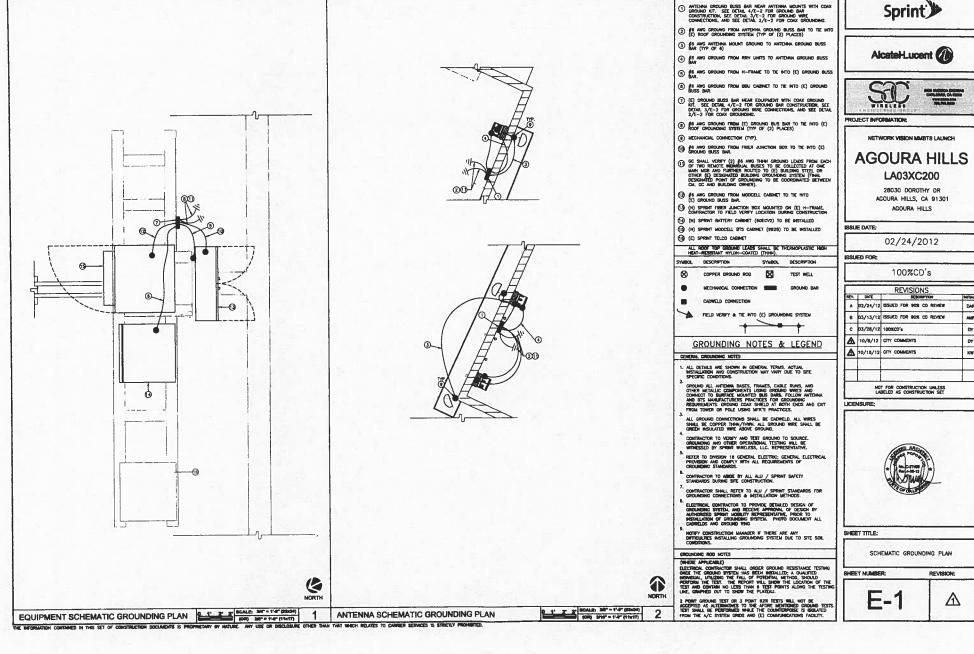

		100%CD's	
-		REVISIONS	
REV.	DATE	DESCRIPTION	MITALS
A	02/24/12	ISSUED FOR 90% CD REVIEW	DAR
В	03/13/12	ISSUED FOR 90% CO REVIEW	AME
c	03/28/12	100%CO's	DY
Δ	10/8/12	CITY COMMENTS	DY
Δ	10/18/12	CITY COMMENTS	ICW
_		THE STATE OF	

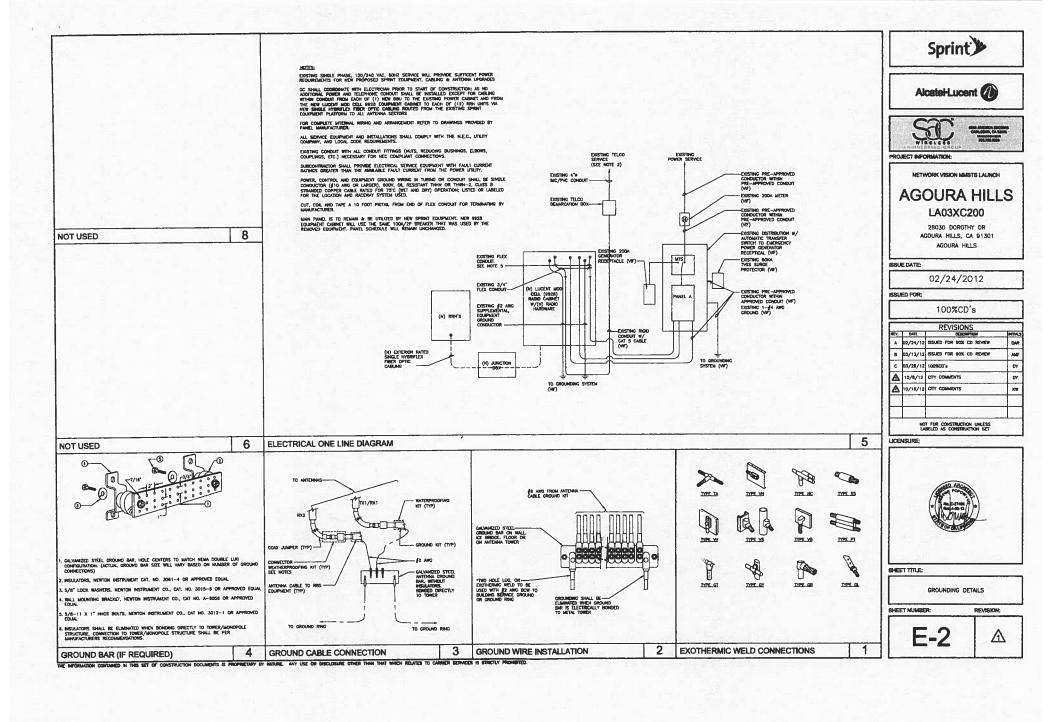


VICINITY MAP - PHOTOSIMULATION VIEWPOINTS

AGOURA HILLS LA03XC200 28030 DORTHY DRIVE, AGOURA HILLS, CA 91301

Sprint


CITY OF AGOUP, WILL 2013 JAN 22 PM 2: 03 WIRELESS ENGINEERING GROUP 5885 AVENIDA ENCINAS CARLSBAD, CA 92008 OFFICE: (760) 795-5200

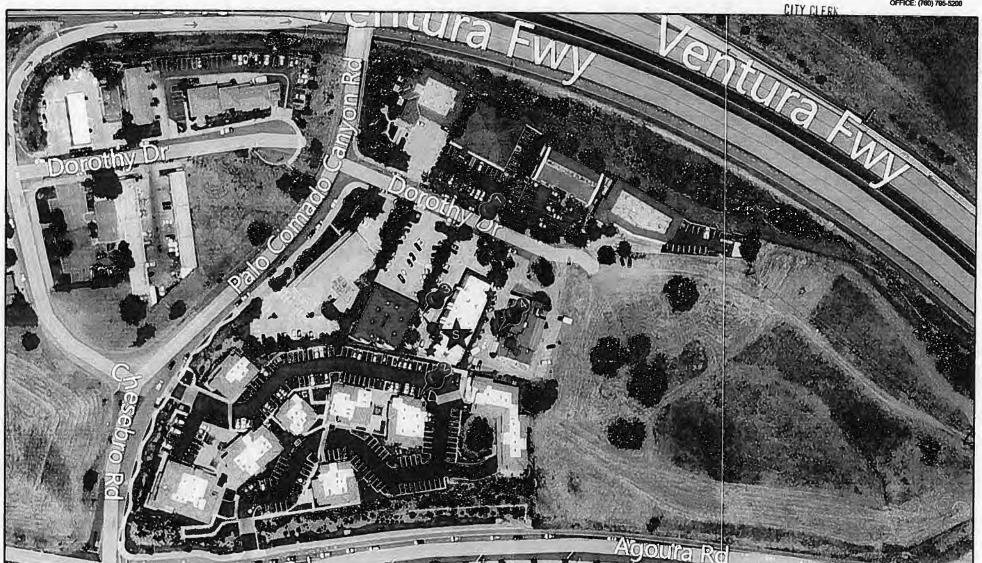

AGOURA HILLS LA03XC200 28030 DORTHY DRIVE, AGOURA HILLS, CA 91301

Sprint


WIRELESS ENGINEERING GROUP 5885 AVENIDA ENCINAS CARLSBAD, CA 2008 OFFICE: (780) 785-5200

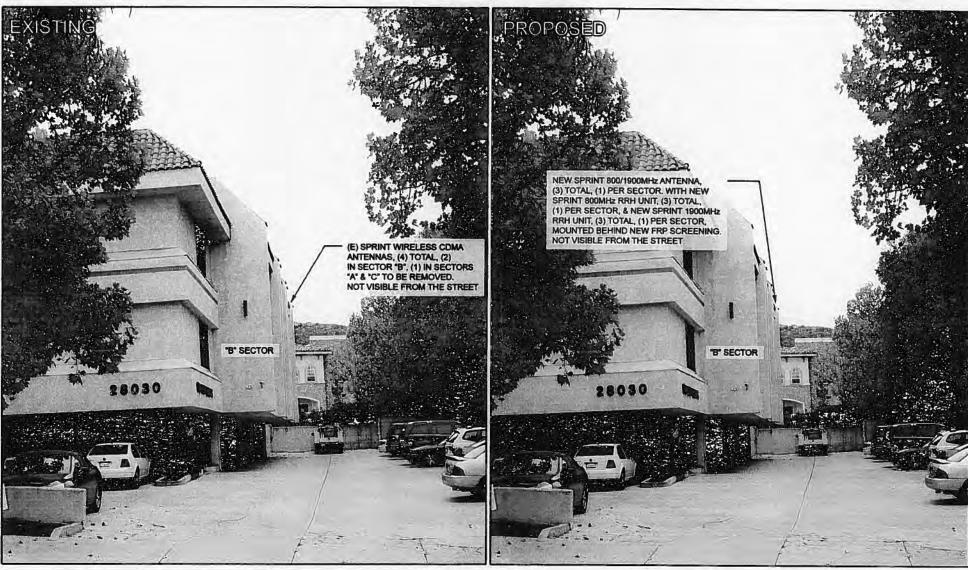


AGOURA HILLS LA03XC200 28030 DORTHY DRIVE, AGOURA HILLS, CA 91301

Sprint



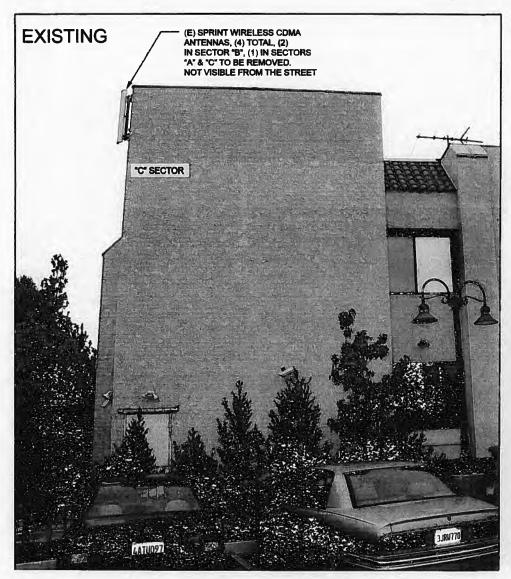


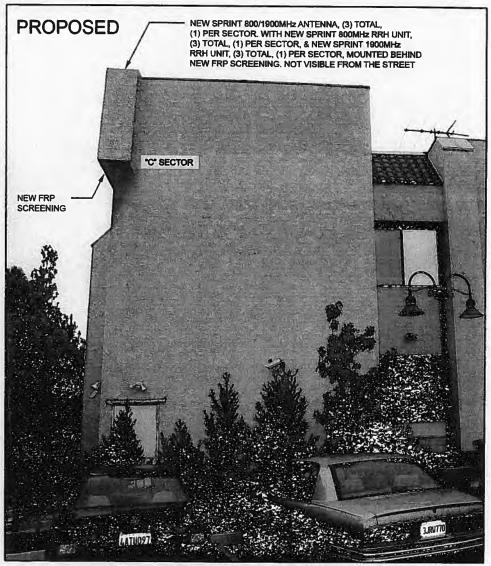


AGOURA HILLS LA03XC200 28030 DORTHY DRIVE, AGOURA HILLS, CA 91301

Sprint

WIRELESS ENGINEERING GROUP 5865 AVENIDA ENCINAS CARLSBAD, CA 92008 OFFICE: (780) 795-5200

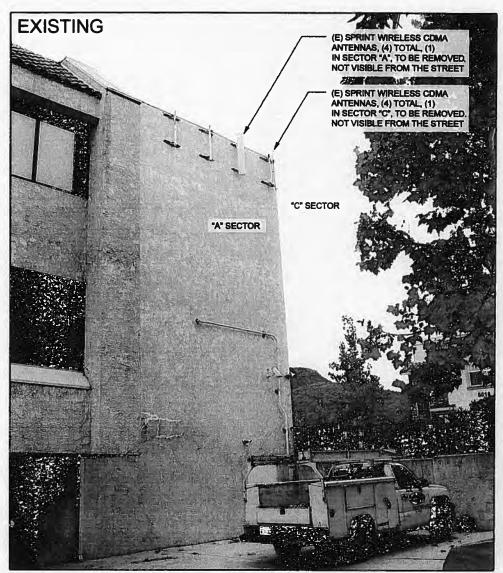


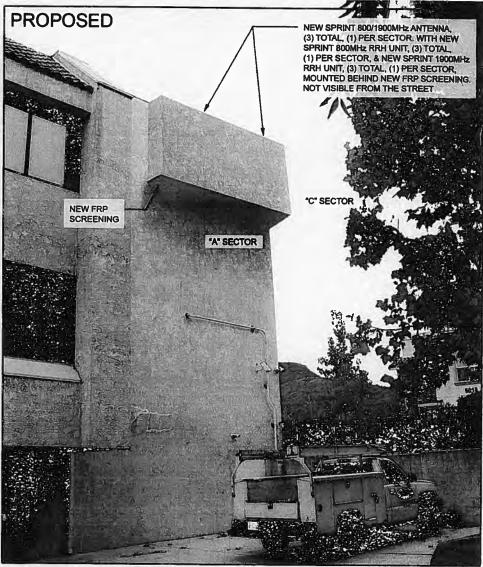


AGOURA HILLS LA03XC200 28030 DORTHY DRIVE, AGOURA HILLS, CA 91301

Sprint



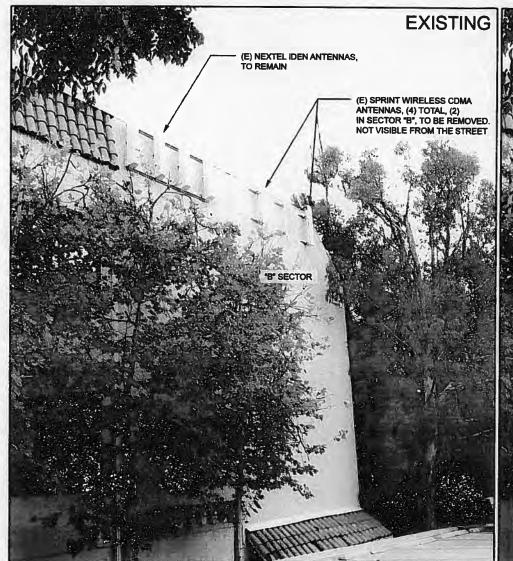

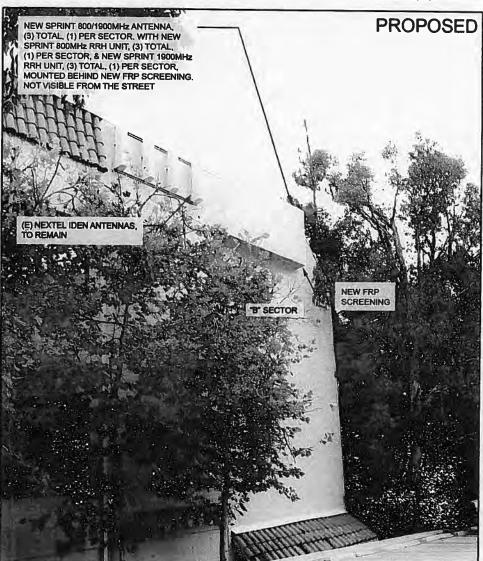




NORTHWEST CORNER VIEW OF THE BUILDING



WEST ELEVATION

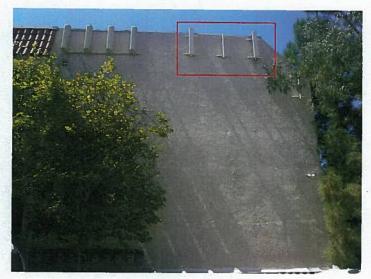

EAST ELEVATION



SOUTH ELEVATION

CONDITIONAL USE PERMIT CASE NO. 12-CUP-001



NETWORK VISION MMBTS LAUNCH

AGOURA HILLS

LA03XC200

ROOFTOP


28030 DOROTHY DR. AGOURA HILLS, CA 91301 CITY OF AGOURA HILLS

LATITUDE: 34° 8' 30.011" N 34.141670

LONGITUDE: 118° 44' 12.012" W

-118.736670

LOS ANGELES MARKET

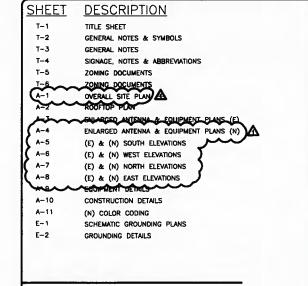

SHEET INDEX


CALIFORNIA STATE CODE COMPLIANCE:

ALL WORK AND MATERIALS SHALL BE PERFORMED AND INSTALLED IN ACCORDANCE WITH THE CURRENT EDITIONS OF THE FOLLOWING CODES AS ADOPTED BY THE LOCAL GOVERNING AUTHORITIES.

- CALIFORNIA ADMINISTRATIVE CODE (INCL TITLE 24 & 25)
 2010 CALIFORNIA BUILDING CODE
 2010 CALIFORNIA GREEN BUILDING STANDARDS CODE
 2010 CALIFORNIA LUMBING CODE
 2010 CALIFORNIA MECHANICAL CODE
 2010 CALIFORNIA ELECTRICAL CODE
 2010 CALIFORNIA FIRE CODE
 CITY OF AGOURA HILLS BUILDING CONSTRUCTION REGULATION
 CODE/CORDINANCE 410_T81)
- CODE(ORDINANCE #10-381)

ACCESSIBILITY REQUIREMENTS:

FACILITY IS UNMANNED AND NOT FOR HUMAN HABITATION. HANDICAPPED ACCESS REQUIREMENTS ARE NOT REQUIRED IN ACCORDANCE WITH THE 2010 CALIFORNIA BUILDING CODE.

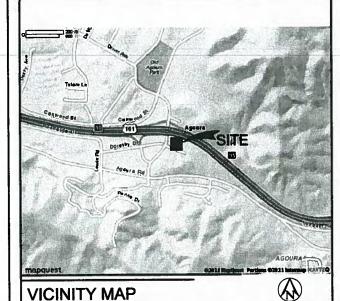

CODE BLOCK

Sprint

APPROVAL	SIGNATURE	DATE
PROJECT MANAGER		
CONSTRUCTION MANAGER	THOMAS TRAPANI	02/25/12
RF ENGINEER		
SITE	T. ANDREDE/SACW	02/28/12
PLANNING CONSULTANT		
PROPERTY OWNER		
SPRINT REP		

SIGNATURE BLOCK

SPRINT PROPOSES TO MODIFY AN (E) UNMANNED TELECOMMUNICATIONS FACILITY

- REMOVE (4) (E) PANEL ANTENNAS
 INSTALL (3) (N) PANEL ANTENNAS
 REMOVE ALL (E) ANTENNA COAX
 INSTALL (3) (N) HYBRIFLEX CABLES USING (E) COAX ROUTE
 INSTALL (3) (N) HYBRIFLEX CABLES USING (E) COAX ROUTE
 INSTALL (1) (N) MODECLL 4.0 COMPACT EQUIPMENT CABINET
 INSTALL (1) (N) DOCELL 4.0 CABINET WITH (N) RADIO HARDWARE
 REMOVE (1) (E) BATTERY BACK UP CABINET (50C)
 INSTALL (1) (N) BATTERY BACK UP CABINET (60EVC2)
 INSTALL (6) (N) RRH UNITS
 INSTALL (1) (N) JUNCTION BOX

- (E) APPROVAL (E) ON SITE (PROPOSED) MOD # OF ANTENNAS SIZE OF ANTENNAS 4'-0" 6'-0"

PROJECT DESCRIPTION

- START OUT GOING NORTHEAST ON COMMERCE TOWARD EL CAMINO REAL.
 TURN LEFT ONTO EL CAMINO REAL.
 TURN LEFT ONTO EL CAMINO REAL.
 TURN LEFT ONTO JAMBOREE RD.
 MERGE ONTO 1-5 N.
 KEEP LEFT TO TAKE US-101-N-TOWARD LOS ANGELES/CM/C CENTER.
 TAKE EXIT 35 TOWARD CHESEBRO RD/AGOURA HILLS.
 TURN LEFT ONTO PALO COMADO CANYON RD.
 TURN LEFT ONTO DOROTHY DR.
 28030 DOROTHY DR IS ON THE RIGHT.

DRIVING DIRECTIONS

APPLICANT:

SPRINT 310 COMMERCE IRVINE, CALIFORNIA 92602 CONTACT: TBD

PROPERTY INFORMATION:

JACK DANIELS & SHELLE HARRIS-DANIELS CAL WEST ENTERPRISES, INC. 28030 DORTHY DRIVE, SUITE 205 AGOURA HILLS, CA 91301

ADDRESS:

PROPERTY OWNER:

JACK DANIELS (818) 706-7383

CONTACT:

BUILDING CODE: 2010 CBC ZONING CLASSIFICATION R-1

OCCUPANCY / USE: PROPOSED PROJECT USE:

TELECOMMUNICATIONS FACILITY TYPE OF CONSTRUCTION: LOT AREA-±21.072 SQ.FT.

BUILDING AREAS # OF STORIES / HEIGHT: 2 FLOORS + GROUND LEVEL/±43'-6"

JURISDICTION: PARCEL NUMBER(S): CITY OF AGOURA HILLS

±14,476 SQ.FT.

LEGAL DESCRIPTION WAS OBTAINED ON 11-29-2011 VIA EXISTING PLANS.TITLE REPORT PARCEL 1:

LOT 24 IN BLOCK 13 OF TRACT NO. 8451, IN THE CITY OF AGOURA HILLS, IN THE COUNTY OF LOS ANGELES, STATE OF CALIFORNIA, AS PER MAP RECORDED IN BOOK 104 PAGES 79 THROUGH 90 INCLUSIVE OF MAPS, IN THE OFFICE OF THE COUNTY RECORDER

PAGES 79 THROUGH 90 INCLUSIVE OF MAPS, IN THE OFFICE OF THE COUNTY RECORDER OF SAID COUNTY.

EXCEPT THEREFROM THAT PORTION OF SAID LAND, DESCRIBED AS FOLLOWS:

BEGINNING AT THE MOST NORTHERN CORNER OF SAID LOT 24: THENCE SOUTH 64' 55'

00" EAST ALONG THE NORTHEASTERLY BOUNDRY OF SAID LOT 24 TO THE POINT OF

BEGINNING WHICH BEARS NORTH 65' 55' 00" WEST, 8 FEET FROM THE NORTHEASTERLY

CORNER OF SAID LOT 24; THENCE CONTINUING ALONG SAID LINE, SOUTH 64' 55' 00'

EAST, 8 FEET TO SAID NORTHEASTERLY CORNER; THENCE SOUTH 25' 05' 00" WEST,

197.01 FEET TO THE SOUTHEASTERLY CORNER; THENCE SOUTH 25' 05' 00" WEST,

NORTHERLY TO THE POINT OF BEGINNING.

LEASE AREA; APPROX 194 SQ.FT. (E)

PROJECT SUMMARY

ARCHITECT:

NESTOR POPOWYCH, AIA
SAC WIRELESS, LLC.
5865 AVENIDA ENCINAS, SUITE 142-B
CARLSBAD, CA 92008
CONTACT:DENNIS YOSHI
PH: (760) 795-5200
EMAIL: DENNIS.YOSHI@SACW.COM

STRUCTURAL:

SAC WIRELESS, LLC. 5865 AVENIDA ENCINAS, SUITE 142-B CARLSBAD, CA 92008

SITE ACQ PROJECT MANAGER:

ALCATEL-LUCENT CONTACT: RICHARD COONS PH: (925) 787-7286

CONSTRUCTION MANAGER:

ALCATEL-LUCENT CONTACT: KEITH BARNHART PH: (415) 404-1225

PLANNING CONSULTANT:

SAC WIRELESS CONTACT: JENNIFER CHESNEY PH: (949) 235-6262

ELECTRICAL ENGINEER

CONTACT: ROBBIE JOHNSON PH: 818-878-4433

POWER COMPANY:

SCE CONTACT: TRACY BASS PH: 949-697-1424

TELCO COMPANY: BRIAN BOTTS

Email: brian.botts@alcatel-lucent.com

PROJECT TEAM

Sprint*





PROJECT INFORMATION:

NETWORK VISION MMBTS LAUNCH

AGOURA HILLS LA03XC200

28030 DOROTHY DR AGOURA HILLS, CA 91301 AGOURA HILLS

ISSUE DATE:

02/24/2012

ISSUED FOR:

100%CD's

		REVISIONS	
REV.	DATE	DESCRIPTION	INITIALS
A	02/24/12	SSUED FOR 90% CD REVIEW	DAR
В	03/13/12	ISSUED FOR 90% CD REVIEW	AMF
C	03/28/12	100%CD's	DY
Δ	10/8/12	CITY COMMENTS	DY
Δ	10/16/12	CITY COMMENTS	KW
		T FOR CONSTRUCTION UNLESS BELED AS CONSTRUCTION SET	

LICENSURE:



SHEET TITLE:

TITLE SHEET

SHEET NUMBER:

REVISION:



EQUIPMENT

GENERAL NOTES:

- THE CONTRACTOR SHALL NOTIFY CARRIER OF ANY ERRORS, OMISSIONS, OR INCONSISTENCIES AS THEY MAY BE DISCOVERED IN PLANS, DOCUMENTS, NOTES, OR SPECIFICATIONS PRIOR TO STARTING CONSTRUCTION INCLUDING, BUT NOT LIMITED BY, DEMOLITION. THE CONTRACTOR SHALL BE RESPONSIBLE FOR CORRECTING ANY ERROR, OMISSION, OR INCONSISTENCY AFTER THE START OF CONSTRUCTION WHICH HAS NOT BEEN BROUGHT TO THE ATTENTION OF CARRIER CONSTRUCTION PROJECT MANAGER AND SHALL INCUR ANY EXPENSES TO RECTIFY THE STRUATION. THE MEANS OF CORRECTING ANY ERROR SHALL FIRST BE APPROVED BY CARRIER CONSTRUCTION PROJECT MANAGER.
- PRIOR TO THE SUBMISSION OF BIDS, CONTRACTORS INVOLVED SHALL VISIT THE JOB SITE TO FAMILARIZE THEMSELVES WITH ALL CONDITIONS AFFECTING THE (N) PROJECT. PRIOR TO THE COMMENCEMENT OF CONSTRUCTION, THE CONTRACTOR HAVING BEEN AWARDED TO THE COMMENCEMENT OF CONSTRUCTION, THE CUNTRACTOR FAVING BEEN AWARDED THIS PROJECT SHALL VISIT THE CONSTRUCTION SITE WITH THE CONSTRUCTION/CONTRACT DOCUMENTS TO VERIFY FIELD CONDITIONS AND CONFIRM THAT THE PROJECT WILL BE ACCOMPLISHED AS SHOWN. PRIOR TO PROCEEDING WITH CONSTRUCTION, ANY ERRORS, OMISSIONS, OR DISCREPANCIES SHALL BE BROUGHT TO THE ATTENTION OF THE ARCHITECT VERBALLY AND IN WRITING.
- FOR COLLOCATION SITES: CONTACT BUILDING PROPERTY OWNER'S REPRESENTATIVE FOR PARTICIPATION IN BID WALK.
- THE ARCHITECT HAS MADE EVERY EFFORT TO SET FORTH IN THE CONSTRUCTION AND CONTRACT DOCUMENTS THE COMPLETE SCOPE OF WORK. CONTRACTORS BIDDING THE JOB ARE NEVERTHELESS CAUTIONED THAT MINOR OMISSIONS OR ERRORS IN THE DRAWINGS AND OR SPECIFICATIONS SHALL NOT EXCUSE SAID CONTRACTOR FROM COMPLETING THE PROJECT AND IMPROVEMENTS IN ACCORDANCE WITH THE INTENT OF THESE DOCUMENTS. THE BIDDER SHALL BEAR THE RESPONSIBILITY OF NOTIFYING (IN WRITING) THE ARCHITECT/ENGINEER OF ANY CONFLICTS, ERRORS, OR OMISSIONS PROID TO SUBMISSION OF CONTRACTOR'S PROPOSAL. IN THE EVENT OF DISCREPANCES THE CONTRACTOR SHALL PRICE THE MORE COSTLY OR EXTENSIVE WORK, UNLESS DIRECTED
- OWNER, CONTRACTOR, AND CARRIER CONSTRUCTION PROJECT MANAGER SHALL MEET JOINTLY TO VERIFY ALL DRAWINGS AND SPECIFICATIONS PRIOR TO THE START OF CONSTRUCTION.
- THE GENERAL CONTRACTOR SHALL RECEIVE WRITTEN AUTHORIZATION TO PROCEED WITH CONSTRUCTION PRIOR TO STARTING WORK ON ANY ITEM NOT CLEARLY DEFINED BY TH CONSTRUCTION DRAWINGS/CONTRACT DOCUMENTS.
- THE CONTRACTOR SHALL PERFORM WORK DURING OWNER'S PREFERRED HOURS TO AVOID DISTURBING NORMAL BUSINESS.
- THE CONTRACTOR SHALL PROVIDE CARRIER PROPER INSURANCE CERTIFICATES NAMING CARRIER AS ADDITIONAL INSURED, AND CARRIER PROOF OF LICENSE(S) AND PE & PD INSURANCE.
- THE CONTRACTOR SHALL INSTALL ALL EQUIPMENT AND MATERIALS ACCORDING TO MANUFACTURER'S/YENDOR'S SPECIFICATIONS UNLESS NOTED OTHERWISE OR WHERE LOCAL CODES OR ORDINANCES TAKE PRECEDENCE.
- 10. ALL WORK PERFORMED ON THE PROJECT AND MATERIALS INSTALLED SHALL BE IN STRICT ACCORDANCE WITH ALL APPLICABLE CODES, REGULATIONS, AND ORDINANCES. CONTRACTOR SHALL GIVE ALL NOTICES AND COMPLY WITH ALL LAWS, ORDINANCES, RULES, REQULATIONS AND LAWFUL ORDERS OF ANY PUBLIC AUTHORITY, MUNICIPAL AND UTILITY COMPANY SPECIFICATIONS, AND LOCAL AND STATE JURISDICTIONAL CODES BEARING ON THE PERFORMANCE OF THE WORK.
- THE CONTRACTOR SHALL STUDY THE STRUCTURAL ELECTRICAL, AND MECHANICAL PLANS AND CROSS CHECK THEIR DETAILS, NOTES, DIMENSIONS, AND ALL REQUIREMENTS PRIOR TO THE START OF ANY WORK. 11.
- 12. THE REFERENCES ON THE DRAWINGS ARE FOR CONVENIENCE ONLY AND SHALL NOT LIMIT THE APPLICATION OF ANY DRAWING OR DETAIL.
- L (E) CONSTRUCTION, EQUIPMENT, AND FINISHES NOTED TO BE REMOVED SHALL COME THE PROPERTY OF THE CONTRACTOR AND WILL BE REMOVED FROM THE SITE THE FOLLOWING EXCEPTIONS:
 PROPERTY NOTED IN WRITING TO BE RETURNED TO THE OWNER.
 PROPERTY NOTED IN WRITING TO BE REMOVED BY THE OWNER.
- PRIOR TO THE POURING OF ANY NEW SLAB OVER AN (E) SLAB THE CONTRACTOR SHALL VERIFY LOCATIONS OF ALL OPENINGS, CHASES, AND EQUIPMENT WHICH ARE TO BE INCORPORATED INTO THE NEW WORK. ALL ITEMS DESIGNATED TO BE ABANDONED SHALL BE NOTED AND DISCUSSED WITH THE OWNER AND CARRIER CONSTRUCTION MANAGER AS THE AS-BUILT DRAWING PACKAGE.
- SEAL ALL PENETRATIONS THROUGH FIRE—RATED AREAS WITH U.L. LISTED OR FIRE MARSHALL APPROVED MATERIALS IF APPLICABLE TO THIS PROJECT SITE. 15.
- BUILDING INSPECTORS AND/OR OTHER BUILDING OFFICIALS ARE TO BE NOTIFIED PRIOR TO ANY GRADING, CONSTRUCTION, AND ANY OTHER PROJECT EFFORT AS MANDATED BY THE GOVERNING AGENCY.
- THE COMPLETED PROJECT SHALL COMPLY WITH LOCAL SECURITY CODES AND TITLE-24 ENERGY CONSERVATION REQUIREMENTS. (TITLE-24 WHEN APPLICABLE)
- ALL RF TRANSPARENT GLASS AND GLAZING IS TO COMPLY WITH CHAPTER 54 OF THE U.S. CONSUMER SAFETY COMMISSION SAFETY STANDARDS FOR ARCHITECTURAL GLAZING MATERIALS (42 FR 1428, CFR PART 1201) AND LOCAL SECURITY
- CONTRACTOR SHALL MAKE NECESSARY PROVISIONS TO PROTECT (E) SITE IMPROVEMENTS, HARDSCAPING, EASEMENTS, PAVING, CURBING, ETC. DURING CONSTRUCTION. UPON COMPLETION OF WORK, CONTRACTOR SHALL REPAIR ANY DAMAGE THAT MAY HAVE OCCURRED DUE TO CONSTRUCTION ON OR ABOUT THE PROPERTY.
- 20. CONTRACTOR SHALL KEEP GENERAL WORK AREA CLEAN AND HAZARD FREE DURING CONSTRUCTION. CONTRACTOR SHALL REMOVE EQUIPMENT NOT SPECIFIED AS REMAINING ON THE PROPERTY OR PREMISES. SITE SHALL BE LEFT IN CLEAN CONDITION AND FREE FROM PAINT SPOTS, DUST, OR SMUDGES OF ANY NATURE.
- . THE CONTRACTOR IS TO PROVIDE PROTECTION FOR ADJOINING PROPERTIES FROM PHYSICAL HARM, NOISE, DUST, DIRT, FIRE, AND FALLING OBJECTS AS REQUIRED BY THE GOVERNING AGENCIES.
- 22. THE CONTRACTOR IS RESPONSIBLE FOR THE STORAGE OF ALL BUILDING MATERIALS AND SHALL NOT DO SO ON PUBLIC PROPERTY WITHOUT A PERMIT FROM THE GOVERNING
- GENERAL NOTES AND STANDARD DETAILS ARE THE MINIMUM REQUIREMENTS TO BE USED IN CONDITIONS WHICH ARE NOT SPECIFICALLY SHOWN OTHERWISE.
- TRADES INVOLVED IN THE PROJECT SHALL BE RESPONSIBLE FOR THEIR OWN CUTTING, FITTING, PATCHING, ETC., SO AS TO BE COORDINATED TO THE WORK OF OTHER TRADES.
- 25. CARRIER DOES NOT GUARANTEE ANY PRODUCTS, FIXTURES, AND/OR ANY EQUIPMENT NAMED BY A TRADE OR MANUFACTURER. GUARANTEE OR WARRANTY THAT MAY BE IN FEFECT IS DONE SO THROUGH THE COMPANY OR MANUFACTURER PROVIDING THE PRODUCT, FIXTURE, AND/OR EQUIPMENT ONLY: UNLESS SPECIFIC RESPONSIBILITY IS ALSO PROMOFO BY THE CONTRACTOR/SUBCONTRACTOR IN WRITTEN FORM

- WHEN APPLICABLE, CONTRACTOR IS RESPONSIBLE TO CALL, COORDINATE AND/OR MAKE ARRANGEMENTS FOR RIGHT-OF-WAY AND/OR PRIVATE PROPERTY ACCESS BASED ON SPECIFIC
- 27. CONTRACTORS TO DOCUMENT ALL WORK PERFORMED WITH PHOTOGRAPHS AND SUBMIT TO CARRIER ALONG WITH REDLINED CONSTRUCTION SET.
- CONTRACTOR SHALL DOCUMENT ALL CHANGES MADE IN THE FIELD BY MARKING UP (REDUNING) THE APPROVED CONSTRUCTION SET AND SUBMITTING THE REDUNED ALONG WITH PHOTOGRAPHS PER CARRIER REQUIREMENTS.
- 29. GENERAL CONTRACTOR IS TO COORDINATE ALL POWER INSTALLATION WITH POWER COMPANY AS REQUIRED. CONTRACTOR TO REPORT POWER INSTALLATION COORDINATION SOLUTION(S) TO NETWORK CARRIER REPRESENTATIVE, PROJECT CONSTRUCTION MANAGER AND ARCHITECT.
- 30. ANY SUBSTITUTIONS OF MATERIALS AND/OR EQUIPMENT, MUST BE APPROVED BY CARRIER CONSTRUCTION MANAGER.
- THE GENERAL CONTRACTOR SHALL BE RESPONSIBLE FOR AND SHALL REMEDY ALL FAULTY, INFERIOR, AND/OR IMPROPER MATERIALS, DAMAGED GOODS, AND/OR FAULTY WORKMANSHIP FOR ONE (1) YEAR AFTER THE PROJECT IS COMPETE AND ACCEPTED UNDER THIS CONTRACT; UNLESS NOTED OTHERWISE IN THE CONTRACT BETWEEN THE OWNER AND THE CONTRACTOR. UNLESS NOTED OTHERWISE IN THE CONTRACT BETWEEN THE OWNER AND ITHE CONTRACTOR. (EXCEPTION) THE ROOFING SUBCONTRACTOR SHALL FURNISH A MAINTENANCE AGREEMENT FOR ALL WORK DONE, COSIGNED BY THE GENERAL CONTRACTOR, TO MAINTAIN THE ROOFING IN A WATERTICHT CONDITION FOR A PERIOD OF TWO (2) YEARS STARTING AFTER THE DATE OF SUBSTANTIAL COMPLETION OF THE PROJECT, UNLESS OTHERWISE WRITTEN IN THE CONTRACT BETWEEN THE OWNER AND THE CONTRACTOR.
- 32. THE CONTRACTOR SHALL PROVIDE ADEQUATE PROTECTION FOR THE SAFETY OF THE OWNER'S EMPLOYEES AT ALL TIMES DURING THE CONSTRUCTION OF THE PROJECT.
- 33. CARRIER WILL REVIEW AND APPROVE SHOP DRAWINGS AND SAMPLES FOR CONFORMANCE WITH DESIGN CONCEPT. CARRIER PROJECT APPROVAL OF A SEPARATE ITEM SHALL NOT INCLUDE APPROVAL OF AN ASSEMBLY IN WHICH THE ITEM FUNCTIONS.
- 34. ALL ANTENNAS MOUNTED ON ROOF SUPPORT FRAMES TO BE PROVIDED BY CARRIER
- CONTRACTOR TO REPAIR ALL GROUND SURFACES WITHIN THE CONSTRUCTION AREA AS NECESSARY TO PROVIDE A UNIFORM SURFACE AND MAINTAIN (E) SURFACE DRAINAGE SLOPES.
- CONTRACTOR TO REPLACE LANDSCAPE VEGETATION THAT WAS DAMAGED DUE TO CONSTRUCTION, AND TO MODIFY REMAINING IRRIGATION LINES TO OPERATING CONDITION, PROVIDING FULL COVERAGE TO IMPACTED AREAS.
- 37. IN THE CASE OF ROOFTOP SOLUTIONS FOR EQUIPMENT AND/OR ANTENNA FRAMES WHERE PENETRATION OF (E) ROOFING MATERIALS OCCUR, THE GENERAL CONTRACTOR SHALL COORDINATE WITH BUILDING OWNER AND BUILDING ROOFING CONTRACTOR OF RECORD FOR INSTALLATION, PATCH, REPAIR OR ANY AUGMENTATION TO THE ROOF, AND HAVE THE WORK GUARANTEED UNDER THE ROOFING CONTRACTOR'S WARRANTY FOR MOISTURE PENETRATION OR AND OTHER FUTURE BREACH OF ROOFING INTEGRITY.
- 38. IN THE CASE OF ROOFTOP SOLUTIONS WITH THE INSTALLATION OF ANTENNAS WITHIN CONCEALED RF TRANSPARENT SCREENS, MOUNTED ON SUPPORT FRAMES OR TRIPODS, THE CONCÉALED RF TRANSPARENT SCREENS, MOUNTED ON SUPPORT FRAMES OR TRIPODS, THE GENERAL CONTRACTOR SHALL COORDINATE WITH THE FRP DESIGNER/FABRICATOR TO ENSURE THAT THE FINAL FRP SHROUD IS SIMULATING (IN APPEARANCE) DESIGNATED (E) EXTERIOR BUILDING FACADE MATERIALS, TEXTURES, AND COLORS. THE CONTRACTOR SHALL FURTHERMORE ENSURE THE USE OF COUNTERSUNK FASTENERS IN ALL FRP CONSTRUCTION. WHEN PHOTOSIMULATIONS ARE PROVIDED, THE CONTRACTOR SHALL ENSURE THAT FINAL CONSTRUCTION REPRESENTS WHAT IS INDICATED IN PHOTOSIMULATION. SHOP DRAWINGS SHALL BE PROVIDED TO THE GENERAL CONTRACTOR, CONSTRUCTION COORDINATOR, AND ARCHITECT PRIOR TO FABRICATION AND CONSTRUCTION.
- THIS FACILITY IS AN UNMANNED CELLULAR TELEPHONE EQUIPMENT FACILITY. THE OCCUPANCY CLASSIFICATION IS B [2007 CBC, TITLE 24, PART 2, VOLUME 1, SECTION 311.3, AND SECTION 307.1 EXCEPTION [11].
- 41. THIS FACILITY IS EXEMPT FROM DISABLED ACCESSIBILITY REQUIREMENTS PER 2007 CBC SECTION 1105B.3.4 EXCEPTION 11 THIS FACILITY IS NON-OCCUPABLE SPACE AND ENTERED ONLY BY SERVICE PERSONNEL. THIS SPACE IS NOT FOR HUMAN OCCUPANCY.
- 42. THE CONTRACTOR SHALL VERIFY ALL (E) CONDITIONS AND DIMENSIONS PRIOR TO SUBMITTING THEIR BID. ANY DISCREPANCIES, CONFLICTS OR OMISSIONS SHALL BE REPORTED TO THE ARCHITECT PRIOR TO SUBMITTING BIDS, AND PROCEEDING WITH ANY WORK.
- 43. THE CONTRACTOR SHALL NOTIFY ARCHITECT OF ANY ERRORS, OMISSIONS, OR DISCREPANCIES AS THEY MAY BE DISCOVERED IN THE PLANS, SPECIFICATIONS, & NOTES PRIOR TO STATTING CONSTRUCTION. INCLUDING BUT NOT LIMITED BY DEMOLITION. THE CONTRACTOR SHALL BE RESPONSIBLE FOR CORRECTING ANY ERRORS, OMISSION, OR INCONSISTENCY AFTER THE START OF CONSTRUCTION WHICH HAS NOT BEEN BROUGHT TO THE ATTENTION OF THE ARCHITECT/FURGIERER AND SHALL INCUR ANY EXPENSES TO RECITEY THE SITUATION. THE METHOD OF CORRECTION SHALL BE APPROVED BY THE ARCHITECT OR THE ENGINEER RESPONSIBLE OF THE PROJECT.
- 44. PRIOR TO STARTING CONSTRUCTION. THE CONTRACTOR HAS THE RESPONSIBILITY TO LOCATE ALL (E) UTILITIES, WHETHER OR NOT SHOWN ON THE PLANS, AND TO PROTECT THEM FROM DAMAGE. THE CONTRACTOR OR SUBCONTRACTOR SHALL BEAR THE EXPENSE OF REPAIRING OR REPLACING ANY DAMAGE TO THE UTILITIES CAUSED DURING THE EXECUTION OF THE WORK. CONTACT USA DIG ALERT © 800-227-2800
- 45. PRIOR TO STARTING CONSTRUCTION, THE CONTRACTOR SHALL PROTECT ALL AREAS FROM DAMAGE WHICH MAY OCCUR DURING CONSTRUCTION, ANY DAMAGE TO NEW OR (E) SURFACES, STRUCTURES OR EQUIPMENT SHALL BE IMMEDIATELY REPAIRED OR REPLACED TO THE SATISFACTION OF THE PROPERTY OWNER. THE CONTRACTOR SHALL BEAR THE EXPENSE OF REPAIRING OR REPLACING ANY DAMAGED AREAS.
- 48. A COPY OF THE APPROVED PLANS SHALL BE KEPT IN A PLACE SPECIFIED BY THE GOVERNING AGENCY, AND BY LAW SHALL BE AVAILABLE FOR INSPECTION AT ALL TIMES. IT IS THE CONTRACTOR'S RESPONSIBILITY TO ENSURE ALL CONSTRUCTION SETS REFLECT THE SAME INFORMATION AS THE APPROVED PLANS. THE CONTRACTOR SHALL ALSO MAINTAIN ONE SET OF PLANS AT THE SITE FOR THE PURPOSE OF DOCUMENTING ALL AS—BUILT CHANCES, REVISIONS, ADDENDA, OR CHANGE ORDERS. THE CONTRACTOR SHALL FORWARD THE AS-BUILT/HIRED DRAWINGS TO THE ASCHITECT OR THE ENGINEER RESPONSIBLE OF THE PROJECT AT THE CONCLUSION OF THE PROJECT.
- 47. THE CONTRACTOR SHALL BE RESPONSIBLE FOR THE COMPLETE SECURITY OF THE SITE WHILE THE WORK IS IN PROGRESS UNTIL THE JOB IS COMPLETE.
- 48. THE CONTRACTOR IS RESPONSIBLE TO PROVIDE TEMPORARY POWER, WATER, AND TOILET FACILITIES AS REQUIRED BY THE PROPERTY OWNER OR GOVERNING AGENCY.

- 49. ALL CONSTRUCTION THROUGH THE PROJECT SHALL CONFORM TO THE LATEST C.B.C. AND ALL OTHER GOVERNING CODES, INCLUDING THE CALIFORNIA ADMINISTRATIVE CODES TITLE 8, 19, AND 24. THE MOST RESTRICTIVE CODE SHALL GOVERN.
- THE CONTRACTOR AND SUBCONTRACTOR SHALL COMPLY WITH ALL LOCAL AND STATE REGULATIONS INCLUDING ALL OSHA REQUIREMENTS.
- WHEN REQUIRED STORAGE OF MATERIALS OCCURS, THEY SHALL BE EVENLY DISTRIBUTED OVER THE FLOOR OR ROOF SO AS NOT TO EXCEED THE DESIGNED LIVE LOADS FOR THE STRUCTURE. TEMPORARY SHORING OR BRACING SHALL BE PROVIDED WHERE THE STRUCTURE HAS NOT ATTAINED THE DESIGN STRENGTH FOR THE CONDITIONS PRESENT.
- 52. THE CONTRACTOR SHALL SUPERVISE AND COORDINATE ALL WORK, USING HIS PROFESSIONAL KNOWLEDGE AND SKILLS. HE IS SOLELY RESPONSIBLE FOR ALL CONSTRUCTION MEANS, METHODS, TECHNIQUES, PROCEDURES AND SEQUENCING AND COORDINATING ALL PORTIONS OF THE WORK UNDER THE PROJECT.
- 53. THE CONTRACTOR SHALL BE RESPONSIBLE TO OBTAIN AND PAY FOR ALL PERMITS, LICENSES, FEES AND INSPECTIONS WITH RESPECT TO THE WORK TO COMPLETE THE PROJECT. HE/SHE MUST PROVIDE EB11 ADDRESS TO SPRINT WIRELESS. BUILDING PERMIT APPLICATIONS SHALL BE FILED BY THE OWNER OR AUTHORIZED AGENT, CONTRACTOR SHALL OBTAIN THE PERMIT AND MAKE FINAL PAYMENT OF SAID DOCUMENT.
- 54. ALL DIMENSIONS TAKE PRECEDENCE OVER SCALE. DRAWINGS ARE NOT TO BE SCALED UNDER
- THE CONTRACTOR SHALL PROVIDE ALL NECESSARY BLOCKING, BACKING, FRAMING, HANGERS OR SUPPORTS FOR INSTALLATION OF ITEMS INDICATED ON THE DRAWINGS.
- 56 THE CONTRACTOR SHALL PROVIDE THE FIRE MARSHALL OR U.L APPROVED MATERIALS TO
- NEW CONSTRUCTION ADDED TO (E) CONSTRUCTION SHALL BE MATCHED IN FORM, TEXTURE, MATERIAL AND PAINT COLOR EXCEPT AS NOTED IN THE PLANS.
- 58. THE CONTRACTOR IS TO PROVIDE PORTABLE FIRE EXTINGUISHERS HAVING A MINIMUM 2A:10-B:C RATING WITHIN 75FT. OF TRAVEL TO ALL PORTIONS OF THE CONSTRUCTION AREA. [2007 CFC SECTION 906-1-1 & 7 AND SECTION 906.3(1)]
- MATERIALS TESTING SHALL BE TO THE LATEST STANDARDS AVAILABLE AS REQUIRED BY THE LOCAL GOVERNING AGENCY RESPONSIBLE FOR APPROVING THE RESULTS.
- 60. ALL GENERAL NOTES AND STANDARD DETAILS ARE THE MINIMUM REQUIREMENTS TO BE USED IN CONDITIONS WHICH ARE NOT SPECIFICALLY SHOWN OTHERWISE.
- 61. ALL DEBRIS AND REFUSE IS TO BE REMOVED FROM THE PROJECT CONTINUOUSLY AND PREMISES SHALL BE LEFT IN A CLEAN BROOM FINISHED CONDITION AT ALL TIMES.
- 62. BUILDING INSPECTORS AND/OR OTHER BUILDING OFFICIALS ARE TO BE NOTIFIED PRIOR TO ANY GRADING AND CONSTRUCTION AS MANDATED BY THE GOVERNING AGENCY.
- 63. ALL SYMBOLS AND ABBREVIATIONS ARE CONSIDERED CONSTRUCTION INDUSTRY STANDARDS. IF CONTRACTOR HAS A QUESTION REGARDING THEIR EXACT MEANING THE ARCHITECT RESPONSIBLE FOR THE PROJECT SHALL BE NOTIFIED FOR CLARIFICATIONS.
- 64. IT IS THE INTENTION OF THESE DRAWINGS TO SHOW THE COMPLETED INSTALLATION. THE CONTRACTOR SHALL BE RESPONSIBLE FOR ALL TEMPORARY BRACING, SHORING, 115, FORM WORK, ETC. IN ACCORDANCE WITH ALL NATIONAL, STATE AND LOCAL ORDINANCES TO SAFLY EXECUTE ALL WORK AND SHALL BE RESPONSIBLE FOR SAME. ALL WORK SHALL BE IN ACCORDANCE WITH LOCAL CODES.
- THE CONTRACTOR SHALL USE ADEQUATE NUMBER OF SKILLED WORKMEN WHO ARE THOROUGHLY TRAINED AND EXPERIENCED IN THE NECESSARY CRAFTS AND WHO ARE COMPLETELY FAMILIAR WITH THE SPECIFIED REQUIREMENTS AND METHODS NEEDED FOR PROPER PERFORMANCE OF THE WORK.
- 68. CONSTRUCTION CONTRACTOR AGREES THAT IN ACCORDANCE WITH GENERALLY ACCEPTED CONSTRUCTION PRACTICES CONSTRUCTION CONTRACTOR WILL BE REQUIRED TO ASSUME SOLE AND COMPLETE RESPONSIBILITY FOR JOB SITE CONDITIONS DURING THE COURSE OF CONSTRUCTION OF THE PROJECT. INCLUDING THE SAFETY OF ALL PERSONS AND PROPERTY. THAT REQUIREMENT SHALL BE MADE TO APPLY CONTINUOUSLY AND NOT BE LIMITED TO NORMAL WORKING HOURS AND CONSTRUCTION CONTRACTOR FURTHER AGREES TO INDEMNIFY AND HOLD DESIGN ENGINEER HARMLESS FROM ANY AND ALL LUBILITY, REAL OR ALLEGED, IN CONNECTION WITH PERFORMANCE OF WORK ON THIS PROJECT.
- 67. GROUNDING SHALL COMPLY WITH SPRINT/NEXTEL GROUNDING STANDARDS, LATEST EDITION AND COMPLY WITH SPRINT/NEXTEL GROUNDING CHECKLIST, LATEST VERSION. WHEN NATIONAL AND LOCAL GROUNDING CODES ARE MORE STRINGENT, THEY SHALL GOVERN.
- 68. ALL WORK SHALL COMPLY WITH OSHA AND STATE SAFETY REQUIREMENTS. PROCEDURES FOR ALL WORK SHALL COMPLY WITH OSHA AND STATE SALETY REQUIREMENTS. PROCEDURES FOR THE PROTECTION OF EXCAVATIONS, EXISTING CONSTRUCTION AND UTILITIES SHALL BE ESTABLISHED PRIOR TO FOUNDATION INSTALLATION. IF TEMPORARY LIGHTING AND MARKING ARE REQUIRED BY THE FEDERAL AVATION ADMINISTRATION (FAA), IT IS THE CONTRACTOR'S RESPONSIBILITY TO MAINTAIN THE NECESSARY LIGHTS AND NOTIFY THE PROPER AUTHORITIES IN THE EVENT OF A PROBLEM.
- 69. ALL WORK SHALL BE ACCOMPLISHED IN ACCORDANCE WITH ALL LOCAL, STATE AND FEDERAL CODES OR ORDINANCES. THE MOST STRINGENT CODE WILL APPLY IN THE CASE OF DISCREPANCIES OR DIFFERENCES IN THE CODE REQUIREMENTS.
- 70. ANY DAMAGE TO ADJACENT PROPERTIES WILL BE CORRECTED AT THE CONTRACTOR'S EXPENSE
- THE CONTRACTOR IS RESPONSIBLE FOR PROVIDING AMPLE NOTICE TO THE BUILDING INSPECTION DEPARTMENT TO SCHEDULE THE REQUIRED INSPECTIONS. A MINIMUM OF 24 HOURS OF NOTICE SHOULD BE GIVEN AND THE BUILDING INSPECTION DEPARTMENTS HAVE REQUESTED THAT GROUPS OF TWO OR THREE SITES BE SCHEDULED AT ONE TIME IF
- 72. THE COMPLETE BID PACKAGE INCLUDES THESE CONSTRUCTION DRAWINGS ALONG WITH THE SPECIFICATIONS AND TOWER DRAWINGS/ANALYSIS. CONTRACTOR IS RESPONSIBLE FOR REVIEW OF THE TOTAL BID PACKAGE PRIOR TO BID SUBMITTAL
- THE CONTRACTOR SHALL VERIFY LOCATIONS OF ALL EXISTING UTILITIES WITHIN THE CONSTRUCTION LIMITS PRIOR TO CONSTRUCTION.
- CLEARING OF TREES AND VEGETATION ON THE SITE SHOULD BE KEPT TO A MINIMUM, ONLY THE TREES NECESSARY FOR CONSTRUCTION OF THE FACILITIES SHALL BE REMOVED. ANY DAMAGE TO TREES AND VEGETATION OUTSIDE THE LEASED PROPERTY SHALL BE REPAIRED BY THE CONTRACTOR.
- 75. RECORD DRAWINGS: MAINTAIN A RECORD OF ALL CHANGES, SUBSTITUTIONS, ETC., BETWEEN THE WORK AS SPECIFIED AND INSTALLED. RECORD CHANGES ON A CLEAN SET OF CONTRACT DRAWINGS WHICH SHALL BE TURNED OVER TO THE CONSTRUCTION MANAGER UPON
- 76. THE CONSTRUCTION SHALL NOT RESTRICT A FIVE—FOOT CLEAR AND UNOBSTRUCTED ACCESS TO ANY WATER OR POWER DISTRIBUTION FACILITIES (POWER POLES, PULL BOXES, TRANSFORMERS, VALUES, PUMP, VALVES, METERS, APPURTENANCES, ETC.) OR TO THE LOCATION OF THE HOOK—UP. THE CONSTRUCTION SHALL NOT BE WITHIN TEN FEET OF ANY POWER LINES—WHETHER OR NOPT THE LINES ARE LOCATED ON THE PROPERTY. FAILURE TO COMPLY MAY CAUSE CONSTRUCTION DELAYS AND/OR ADDITIONAL EXPENSES.
- 77. IF APPLICABLE AN APPROVED SEISMIC GAS SHUT OFF VALVE OR EXCESS FLOW SHUT OFF VALVE WILL BE INSTALLED ON THE FUEL GAS LINE ON THE DOWN STREAM SIDE OF THE UTILITY METER AND BE RIGIDLY CONNECTED TO THE EXTERIOR OF THE BUILDING OR STRUCTURE CONSTRUING THE FUEL GAS PIPING. (PER ORDINANCE 170, 158 AND 180,670) (INCLUDES COMMERCIAL ADDITIONS AND TI WORK OVER \$10,000.) SEPARATE PLUMBING PERMIT IS PERCURPED.
- PROVIDE DESIGN BY A LICENSED ENGINEER OR ARCHITECT FOR THE (VERTICAL) (SEISMIC/WIND LATERAL) FORCE RESISTING SYSTEM PER (LABC 2305, & 2307, R301.1.0).

SYMBOLS:

 \otimes GRID REFERENCE



DETAIL REFERENCE



ELEVATION REFERENCE





- - CENTERLINE

-- PROPERTY/LEASE LINE - MATCH LINE

--- WORK POINT

---- GROUND CONDUCTOR

TELEPHONE CONDUIT - ELECTRICAL CONDUIT ----- A ------ COAXIAL CABLE

- O/H- OVERHEAD SERVICE EMPRESSEDENCE GROUT OR PLASTER

CONDUCTORS

(E) BRICK (E) MASONRY

CONCRETE

EARTH GRAVEL

PLYWOOD SAND

> WOOD CONTINUOUS WOOD BLOCKING

STEEL STEEL

(N) NEW (E) (E)

NEW ANTENNA

(E) ANTENNA حہ 0 GROUND ROD

GROUND BUS BAR MECHANICAL GRND. CONN

CADWELD

 \otimes GROUND ACCESS WELL

E ELECTRIC BOX T TELEPHONE BOX

公 LIGHT POLE

FND. MONUMENT

0

Δ

SPOT ELEVATION

SET POINT

Δ







PROJECT INFORMATION

NETWORK VISION MMBTS LAUNCH

AGOURA HILLS LA03XC200

28030 DOROTHY DR AGOURA HILLS, CA 91301 AGOURA HILLS

ISSUE DATE:

02/24/2012

ISSUED FOR:

100%CD's

REVISIONS REV. DATE DESCRIPTION 02/24/12 ISSUED FOR 90% CD REVIEW 03/13/12 ISSUED FOR 90% CD REVIEW DY C 03/28/12 100%CD's 10/8/12 CITY COMMENTS DY 10/16/12 CITY COMMENTS KW NOT FOR CONSTRUCTION UNLESS LABELED AS CONSTRUCTION SET

LICENSURE



SHEET TITLE:

GENERAL NOTES & SYMBOLS

SHEET NUMBER:

REVISION:



TABLE OF CONTENTS GENERAL REQUIREMENTS PURPOSE AND INTENT 1.1 1.2 CONFLICTS 1.3 CLEANING 1.4 CODES 1.5 LICENSING 1.6 OSHA C. 1.7 PHOTOS BUILDING PERMITS 1.8 ZONING REGULATIONS & CONDITIONAL USE PERMITS 1.9 1.10 FAA PERMIT AND TOWER LIGHTING 1.11 TOWER SECURITY SITE CONTROL 1.12 2.0 SITE PREPARATION 1.3 CLEANING 2.1 PRODUCT AND MATERIALS 2.2 COMPACTION 3.0 CHAIN LINK FENCES AND GATES 4.0 GENERAL 1.5 LICENSING PRODUCTS AND MATERIALS LANDSCAPING 6.0 CONCRETE FORMWORK 7.0 CONCRETE REINFORCEMENT CAST-IN PLACE CONCRETE 8.0 STRUCTURAL STEEL an 10.0 GROUNDING 1.7-PHOTOS 1.8 BUILDING PERMITS 1.12 SITE CONTROL 2.0 SITE PREPARATION

COMPLY WITH THESE STANDARDS UNLESS OTHERWISE REQUIRED BY APPLICABLE CODES

*GENERAL CONTRACTOR SHALL COMPLY WITH OSHA AND SPRINT STANDARD SAFETY AND

1.0 CONSTRUCTION TO CONFORM TO SPRINT NEXTEL INTEGRATED CONSTRUCTION STANDARDS

- RPOSE AND INTENT
 THE DRAWINGS AND SPECIFICATIONS ARE INTENDED TO BE FULLY EXPLANATORY AND SUPPLEMENTARY, HOWEVER, SHOULD
 ANYTHING BE SHOWN, INDICATED OR SPECIFIED ON ONE AND NOT THE OTHER, IT SHALL BE DONE THE SAME AS IF SHOWN,
 INDICATED OR SPECIFIED IN BOTH. SHOULD THERE BE ANY DISCREPANCIES BETWEEN REQUIREMENTS SHOWN IN BOTH, THE
 MORE STRINGENT REQUIREMENTS SHALL APPLY.
 THE INTENTION OR THE DOCUMENTS IS TO INCLUDE ALL LABOR AND MATERIALS REASONABLY NECESSARY FOR THE PROPER
 EXECUTION AND COMPLETION OF THE WORK AS STIPULATED IN THE CONTRACT.
 THE PURPOSE OF THE SPRINT WIRELESS CONSTRUCTION SPECIFICATIONS IS TO INTERPRET THE INTENT OF THE DRAWINGS
 AND TO DESIGNATE THE METHOD OF THE PROCEDURE, TYPE AND QUALITY OF MATERIALS REQUIRED TO COMPLETE THE
 WORK

- 1.2 CONFLICTS

 A. VERIEY ALL MEASUREMENTS AT THE SITE BEFORE ORDERING MATERIAL OR DOING ANY WORK. NO EXTRA CHARGE OR COMPENSATION WILL BE ALLOWED DUE TO DIFFERENCES BETWEEN ACTUAL DIMENSIONS OR DIMENSIONS SHOWN ON PLANS. SUBMIT NOTICE OF ANY DISCREPANCY IN DIMENSIONS OR OTHERWISE TO SPRINT WIRELESS FOR RESOLUTION BEFORE PROCEEDING WITH THE WORK.

 B. NO PLEA OF IGNORANCE OF CONDITIONS THAT EXIST OR OF DIFFICULTIES OF CONDITIONS THAT MAY BE ENCOUNTERED, OR OF ANY OTHER RELEVANT MATTER CONCENTING THE EXECUTION OF THE WORK WILL BE ACCEPTED AS AN EXCUSE FOR ANY FAILURE OR OMISSION ON THE PART OF THE CONTRACTOR TO FULFILL EVERY DETAIL OF ALL THE REQUIREMENTS OF THE CONSTRUCTION DOCUMENTS GOVERNING THE WORK.

ANING
KEEP THE SITE FREE FROM ACCUMULATION OF WASTE AND RUBBISH CAUSED BY EMPLOYEES AT THE COMPLETION OF THE
WORK, REMOVE ALL WASTE AND NON-CONSTRUCTION MATERIAL INCLUDING ALL CONTRACTOR TOOLS, SCAFFOLDING AND
SURPLUS MATERIAL AND LEAVE SITE CLEAN AND READY FOR USE.

CONTRACTOR SHALL. BE RESPONSIBLE FOR FOLLOWING ALL LAWS, REGULATIONS AND RULES PROMULGATED BY FEDERAL STATE AND LOCAL AUTHORITIES WITH JURISDICTION OVER THE SITE. THIS RESPONSIBILITY IS IN EFFECT REGARDLESS OF WHETHER THE LAW, ORDINANCE, REGULATION OR RULE IS MENTIONED IN THESE SPECIFICATIONS.

NSING HAVE AND MAINTAIN A VALID CONTRACTORS LICENSE FOR THE LOCATION IN WHICH THE WORK IS TO BE PERFORMED. FOR THAT LICENSE INDIVIDUAL TRADES, THE TRADESMAN OR SUBCONTRACTORS PERFORMING THOSE TRADES SHALL BE LICENSED. RESEARCH AND COMPLY WITH LICENSING LAWS, PAY LICENSE FEES, AND SELECT AND INFORM SUBCONTRACTORS REGARDING

FOLLOW ALL APPLICABLE RULES AND REGULATIONS OF THE OCCUPATIONAL SAFETY AND HEALTH ADMINISTRATIONS, AND STATE LAWS BASED IN THE FEDERAL OCCUPATIONAL SAFETY AND HEALTH ACT. THESE REGULATIONS INCLUDE BUT ARE NOT LIMITED TO REGULATIONS DEALING WITH TOWER CONSTRUCTION AND SAFETY, EXCANATIONS AND TRENCHING, AND WORK IN CONFINED SPACES. ENSURE THAT EMPLOYEES AND SUBCONTRACTORS WEAR HARD HATS AT AII TIMES DURING

PROVIDE PHOTOGRAPHIC EVIDENCE OF ALL FOUNDATION INSTALLATION, GROUNDING AND TRENCHING AFTER PLACEMENT OF UTILITIES PRIOR TO BACKFILL.

- DING PERMITS

 SPRINT WIRELESS WILL SUBMIT CONSTRUCTION DOCUMENTS TO THE JURISDICTIONAL AUTHORITY FOR PLAN CHECK AND REVIEW. CONTRACTOR WILL SUBMIT LICENSING AND WORKMAN'S COMPENSATION INFORMATION TO THE JURISDICTION AS REQUIRED TO OBTAIN THE BUILDING PERMIT. CONTRACTOR SHALL COORDINATE AND SCHEDULE REQUIRED INSPECTIONS AND POST REQUIRED PERMITS AT THE JOB SITE. COMPLY WITH SPECIFIC PROJECT-RELATED REQUESTS AND SUGGESTIONS MADE BY BUILDING INSPECTOR AND INFORM CONSTRUCTION MANAGER OF ANY SUCH WORK THAT MAY BE BEYOND THE SCOPE OF THE CONTRACT ON DEVATE FROM THE CONSTRUCTION DOCUMENTS. SPRINT WIRELESS WILL REIMBURSE THE CONTRACTOR FOR FEES FOR PLAN REVIEW, BUILDING PERMIT, CONNECTIONS AND INSPECTION.
- 1.9 ZONING REGULATIONS AND CONDITIONAL USE PERMITS
 SPRINT WIRELESS WILL SUBMIT FOR AND OBTAIN ALL ZONING AND CONDITIONAL USE PERMITS. SOME USE PERMITS MAY
 HAVE SPECIFIC REQUIREMENTS RELATED TO THE CONSTRUCTION SUCH AS NOISE REGULATIONS, HOURS OF WORK, ACCESS
 LIMITATIONS, ETC. THE CONSTRUCTION MANAGER WILL INFORM THE CONTRACTOR OF THESE REQUIREMENTS AT THE PRE-BID
 MEETING OR AS SHOWN IN CONSTRUCTION DOCUMENTS.
- 1.10 FAA PERMIT AND TOWER LIGHTING PERMII AND TOWER LIGHTING REQUIREMENTS AND CONSTRUCTION MANAGER FOR FAA AND STATE LIGHTING REQUIREMENTS. CONTRACTOR SHALL PROVIDE TEMPORARY FAA APPROVED LIGHTING UNTIL PERMANENT LIGHTING IS OPERATIONAL
- 1.11 TOWER SECURITY
 TOWER MUST BE FENCED, TEMPORARILY OR PERMANENTLY WITHIN 24 HOURS OF ERECTION. DO NOT ALLOW THE GATE
 ACCESSING THE TOWER AREA TO REMAIN OPEN OR UNATTENDED AT ANY TIME FOR ANY REASON. KEEP THE GATE CLOSED
 AND LOCKED WHEN NOT IN USE.
 - CONTROL
 THE CONTRACTOR IS COMPLETELY RESPONSIBLE FOR CONTAINMENT OF
 SEDIMENT AND CONTROL OF EROSION AT THE SITE. ANY DAMAGE TO ADJACENT OR DOWNSTREAM PROPERTIES WILL BE
 CORRECTED BY THE CONTRACTOR AT NO EXPENSE TO SPRINT WIRELESS.
 - B. THE CONTRACTOR IS TO MAINTAIN ADEQUATE ROOF DRAINAGE AT ALL TIMES. DO NOT ALLOW WATER TO STAND OR POND ON ANY PORTION OF THE ROOF. ANY DAMAGE TO STRUCTURES OR WORK ON THE SITE CAUSED BY INADEQUATE MAINTENANCE OF ROOF DRAINAGE PROVISIONS WILL BE THE RESPONSIBILITY OF THE CONTRACTOR AND ANY COST ASSOCIATED WITH REPAIRS FOR SUCH DAMAGE WILL BE AT THE CONTRACTOR'S EXPENSE.
 - C. ALL WASTE MATERIAL SHALL BE PROPERLY DISPOSED OF OFF-SITE OR AS DIRECTED BY THE CONSTRUCTION MANAGER AND IN ACCORDANCE WITH JURISDICTIONAL AUTHORITIES.

- 2.1 SCOPE OF WORK INCLUDES:

 A. PROTECTION OF EXISTING TREES, VEGETATION AND LANDSCAPING MATERIALS WHICH MIGHT BE DAMAGED BY
- PROTECTION OF EXISTING TREES, VEGETATION AND LANDSCAPING MATERIALS WHICH MIGHT BE DAMAGED BY CONSTRUCTION ACTIVITIES.
 TRIMMING OF EXISTING TREES AND VEGETATION AS REQUIRED FOR PROTECTION DURING CONSTRUCTION ACTIVITIES.
 CLEARING AND GRUBBING OF STUMPS, VEGETATION, DEBRIS, RUBBISH, DESIGNATED TREES, AND SITE IMPROVEMENTS.
 TOPSOIL STRIPPING AND STOCKPILING.
 TEMPORARY EROSION CONTROL, SILTATION CONTROL AND DUST CONTROL CONFORMING TO LOCAL REQUIREMENTS AS APPLICABLE.
 TEMPORARY PROTECTION OF ADJACENT DECCEPTS.

 - APPLICABLE.

 F. TEMPORARY PROTECTION OF ADJACENT PROPERTY, STRUCTURES, BENCHMARKS AND MONUMENTS.

 F. TEMPORARY PROTECTION AND TEMPORARY RELOCATION, STORAGE AND RE—INSTALLATION OF DUSTING FENCING AND OTHER SITE IMPROVEMENTS SCHEDULED FOR REUSE.

 H. REMOVAL AND LEGAL DISPOSAL OF CLEARED MATERIALS.

2.2 PRODUCTS AND MATERIALS (AS APPROVED BY CONSTRUCTION MANAGER OR AS NOTED IN CONSTRUCTION DOCUMENTS.)

A. MATERIALS USED FOR TREE PROTECTION, EROSION CONTROL, SILTATION CONTROL AND DUST CONTROL AS SUITABLE FOR SPECIFIC SITE CONDITIONS.

- A. COMPACT BACKFILL TO A 95 PERCENT COMPACTION AT A MAXIMUM DRY DENSITY AS DETERMINED BY ASTM D-1557 OR WITHIN PLUS OR MINUS 3 PERCENT OF OPTIMUM MOISTURE CONTENT.

 B. IF REQUIRED COMPACTION DENSITY HAS NOT BEEN OSTAINED, REMOVE THE BACKFILL FROM THE TRENCH OR STRUCTURE, REPLACE WITH APPROVED BACKFILL AND RECOMPACT AS SPECIFIED.

 C. ANY SUBSEQUENT SETTLEMENT OF TRENCH OR STRUCTURE BACKFILL DURING MAINTENANCE PERIOD SHALL BE CONSIDERED THE RESULT OF IMPROPER COMPACTION AND SHALL BE PROMPTLY CORRECTED.

4.0 CHAIN LINK FENCES AND GATES

A. PROVIDE CHAIN LINK FENCES AND GATES AS COMPLETE UNITS BY A SINGLE SUPPLY SOURCE INCLUDING NECESSARY ERECTION ACCESSORIES, FITTINGS AND FASTENERS.

- 4.2 PRODUCTS AND MATERIALS (AS APPROVED BY CONSTRUCTION MANAGER OR AS WITHIN CONSTRUCTION DOCUMENTS)
- COMPOUND FABRIC 84 INCHES HIGH AND OVER WITH 2-INCH MESH SHALL BE KNUCKLED AT ONE SELVAGE AND TWISTED AT THE OTHER. STEEL FABRIC:
- STEEL FABRIC:

 COMPLY WITH CHAIN LINK FENCE MANUFACTURERS INSTITUTE (CLFMI) PRODUCT MANUAL FURNISH ONE PIECE OF FABRIC WIDTHS. WIRE SIZE INCLUDES ZINC OR ALLMINUM COATING.

1. SIZE: 2-INCH MESH 9 GAUGE (D.148-INCH DIAMETER) WIRE.
2. GALVANIZED STEEL FINISH: ASTM A 392. CLASS 2. WITH A MINIMUM 2.0 OZ. ZINC PER SQ. FT. OF UNCOATED WIRE SURFACE. FRAMEWORK AND ACCESSORIES:

MEWORK AND ACCESSORIES:

GENERAL REQUIREMENTS: EXCEPT AS INDICATED OTHERWISE CONFORM TO THE CHAIN LINK FENCE MANUFACTURERS INSTITUTE (CLFMI) PRODUCT MANUAL INDUSTRIAL STEEL GUIDE FOR FENCE RAILS, POSTS, GATES AND ACCESSORIES INCLUDING TABLE II.

STRENGTH REQUIREMENTS FOR POSTS AND RAILS CONFORMING TO ASTM F 1043.

TYPE 1 PIPE HOT—DIPPED GALVANIZED STEEL PIPE CONFORMING TO ASTM F 1083. PLANE ENDS, STANDARD WEIGHT (SCHEDULE 40) WITH NOT LESS THAN 18 02. ZINC PER SQ. FT. OF SURFACE AREA COATED.

IMAN 16 02. ZIME FEX SU, F1. UP SURFACE AREA COALED.
FILLINGS: COMPLY WITH ASTM F 526 MILE FINISHED ALMINIUM OR GALVANIZED IRON STEEL TO COMPLY WITH MANUFACTURER'S REQUIREMENTS.
TOP RAIL MANUFACTURERS LONGEST LENGTHS, WITH EXPANSION TYPE COUPLINGS, APPROXIMATELY 6 INCHES LONG, FOR EACH JOINT. PROVIDE MEANS
FOR ATTACHING TOP RAIL SECURELY TO EACH GATE CORNER, PULL AND END POST.

D. GALVANIZED STEEL 11/4 INCH NPS (1.66 INCH OD) TYPE I OR II STEEL PIPE OR 1.625 NCH x 1.25 INCH ROLL-FORMED C SECTIONS WEIGHING 1.35

COMPLY WITH ASTM F 900. PROVIDE HARDWARE AND ACCESSORIES FOR EACH GATE. GALVANIZED PER ASTM A 153, AND IN ACCORDANCE WITH THE FOLLOWING:

- HINGES: NON LIFT- OFF TYPE. OFFSET TO PERMIT ISO DEG. GATE OPENING.
 LATCH: MTS MULTI-LOCKING DEVICE MT-C6477 OR APPROVED EQUAL.
 KEEPER: PROVIDE KEEPER FOR VEHICLE GATES, WHICH AUTOMATICALLY ENGAGES GATE LEAF AND HOLDS IT IN OPEN POSITION UNTIL MANUALLY
- CONCRETE: PROVIDE CONCRETE CONSISTING OF PORTLAND CEMENT, ASTM C 150, AGGREGATES ASTMC 33, AND CLEAN WATER. MIX MATERIALS TO OBTAIN CONCRETE WITH A MINIMUM OF 28-DAY COMPRESSIVE STRENGTH OF 3000 PSI.

5.0 LANDSCAPING

A. FURNISH, INSTALL AND MAINTAIN LANDSCAPE WORK AS SHOWN AND OR REQUIRED WITHIN THE CONSTRUCTION DOCUMENTS OR AS SPECIFIED IN THE SPRINT WIRELESS CONSTRUCTION SPECIFICATIONS.

6.0 CONCRETE FORMWORK

- FORMS: SMOOTH AND FREE OF SURFACE IRREGULARITIES. UTILIZE FORM RELEASE AGENTS.
 CHAMFER: EXPOSED EDGES OF ALL TOWER FOUNDATIONS SHALL RECEIVE A 3/4" 97 3/4" 45 DEGREE CHAMFER. OTHER EXPOSED EDGES SHALL RECEIVE A TOOLED RADIUS FINISH.
 UPON COMPLETION, REMOVE ALL FORMS, INCLUDING THOSE CONCEALED OR BURIED.
 REFER TO STRUCTURAL DRAWINGS FOR ADDITIONAL REQUIREMENTS.
- 7.0 CONCRETE REINFORCEMENT REFER TO STRUCTURAL DRAWINGS FOR ALL REQUIREMENTS.

8.0 CAST IN PLACE CONCRETE

FOR STRUCTURAL CONCRETE (FOOTINGS, FOUNDATIONS, ETC.), REFER TO STRUCTURAL DRAWINGS FOR REQUIREMENTS. FOR ANY MISCELLANEOUS CONCRETE, REFER TO SPECIFICATION BOOK OR OBTAIN REQUIREMENTS FROM CONSTRUCTION MANAGER.

A. ALL CONCRETE SHALL COMPLY WITH ASTM C94 UNLESS NOTED OTHERWISE.

B. MINIMUM COMPRESSIVE STRENGTH (F°C) AT 28 DAYS: 4000 PSI FOR TOWER FOUNDATION AND 3500 PSI FOR ALL OTHER CONCRETE UNLESS SPECIFIED IN CONSTRUCTION DOCUMENTS.

C. AIR ENTRAINMENT: PROVIDE 4 TO 8% AIR ENTRAINMENT FOR ALL CONCRETE SUBJECT TO FREEZE—THAW CYCLE.

D. CONCRETE TESTING: ALL-FOUNDATION CONCRETE SHALL BE TESTED BY AM INDEPENDENT TESTING ACENCY APPROVED BY THE CONSTRUCTION MANAGER. ALL STRUCTURAL TOWER FOUNDATION CONCRETE MUST BE TESTED. EQUIPMENT OR BUILDING PADS ARE NOT REQUIRED TO BE TESTED, UNLESS OTHERWISE, NOTED BY CONSTRUCTION MANAGER. PROVIDE A MINIMUM OF 5 CYLINDERS (27-DAY, 2-28-DAY, 1-SPARE) FOR EACH DAYS POUR, OR FOR EVERY 50 YARDS PLACED, WHICHEVER 15 GREATER, ADDITIONAL TESTS OR CYLINDERS (27-DAY, 2-28-DAY, 1-SPARE) FOR EACH DAYS POUR, OR FOR TEMPERATURE TEST SHALL BE PERFORMED TO FER EACH SET OF CYLINDERS CAST. PREFERABLY, TESTS SHALL BE PERFORME AT THE LOCATION OF ANCHOR BOLITS (PIERS — FOR MAT & PIERS, CAISSONS — TOP1/3 OF CAISSON). TESTS SHALL ALSO BE REQUIRED BY CONCRETE CONSIDERED BEING LESS THAN DESIRABLE BY CONCRETE SPECIFICATION STANDARDS. THE TESTING ACENCY HAS THE AUTHORITY TO NOT ACCEPT CONCRETE MEETING THESE SPECIFICATIONS FOR SPRINT WIRELESS. THE CONTRACTOR IS RESPONSIBLE FOR ANY CONCRETE NOT EXTENDED FOR SPRINT CONSTRUCTION MANAGER. AS HORSON OF THE TESTING ACENCY A MINIMUM OF 24 HOURS IN ADVANCE OF EACH FOUNDATION POUR. TEST REPORTS SHALL BE FORWARDED TO SPRINT CONSTRUCTION MANAGER AS THE PROVIDENCE FOR THE STANDARDS. THE CONTRACTOR IS RESPONSIBLE FOR ANY CONCRETE MEETING THESE STANDARDS. THE CONTRACTOR IS RESPONSIBLE FOR ANY CONCRETE AND THE MEETING THESE STANDARDS. THE CONTRACTOR IS RESPONSIBLE FOR ANY CONCRETE OF EACH FOUNDATION POUR. TEST REPORTS SHALL BE FORMARDED TO SPRINT CONSTRUCTION MANAGE

- 5. ROCK POCKETS, HONEYCOMB, SAND STREAKS, DEBRIS AND VOIDS: CUT OUT AT LEAST 1 INCH DEEP WITH SIDES PERPENDICULAR TO SURFACE. FLUSH THOROUGHLY WITH CLEAN WATER, COAT SURFACE WITH NEAT CEMENT PASTE AND TAMP TO OVERFULL WITH DRYPACK IN AT LEAST TWO LAYERS. CURE FOR 10 DAYS AND HONE FLUSHED AND SMOOTH.
- 6. CONTRACTOR SHALL VERIFY ALL SIZES AND LOCATIONS OF ALL ELECTRICAL OPENINGS AND EQUIPMENT/BUILDING PADS WITH THE ELECTRICAL DRAWINGS AND SHOP DRAWINGS. IT SHALL BE THE RESPONSIBILITY OF THE CONTRACTOR TO PROVIDE ALL OPENINGS AND SLEEVES FOR PROPER DISTRIBUTION FOR ALL LITLITIES. CONTRACTOR SHALL REFER TO DRAWINGS OF OTHER TRADES AND VENDOR DRAWINGS FOR EMBEDDED ITEMS AND RECESSES NOT SHOWN ON STRUCTURAL DRAWINGS. PRIOR TO POURING CONCRETE THE INDEPENDENT TESTING AGENCY SHALL INSPECT ALL FOUNDATION STEEL AND FOUNDATION SUBGRADE

9.0 STRUCTURAL STEEL

MEET OR EXCEED MANUFACTURER'S RECOMMENDATIONS

A. UNLESS OTHERWISE NOTED, ALL DETAILING, FABRICATION AND PLACING OF REINFORCING STEEL SHALL CONFORM TO THE MANUAL OF STANDARD PRACTICE

- UNLESS OTHERWISE NOTED, ALL DETAILING, FABRICATION AND PLACING OF REINFORCING STEEL SHALL CONFORM TO THE MANUAL OF STANDARD PRACTICE FOR DETAILING REINFORCED CONCRETE STRUCTURES (ACI 315).
 ALL REINFORCING STEEL SHALL BE NEW BILLET STEEL, CONFORMING TO ASTM A-615, GRADE 60, DEFORMED.
 HATING AND WELDING OF BARS IS PROHIBITED WITH THE EXCEPTION OF WRITTEN APPROVAL BY THE STRUCTURAL ENGINEER.
 ALL REINFORCEMENT BARS TO BE FREE FROM LOOSE RUST AND SCALE.
 UNLESS OTHERWISE NOTED, ALL REINFORCEMENT SHALL HAVE A MINIMUM CONCRETE COVERAGE OF 3 INCHES. THIS MAY REQUIRE SPACERS AND CHAIRS AS REQUIRED BY TESTING AGENCY OR CONSTRUCTION MANAGER.
 SPLICES IN REINFORCEMENT STEEL ARE PROHIBITED, UNLESS APPROVED BY CONSTRUCTION MANAGER. ALL SPLICES MUST THEN MEET ALL APPLICABLE ASTM STANDARDS FOR SPLICING.

10.0 GROUNDING

MEET ALL APPLICABLE CODES, REQUIREMENTS OF THE CONSTRUCTION DOCUMENTS AND SPRINT WIRELESS CONSTRUCTION SPECIFICATIONS.







PROJECT INFORMATION:

NETWORK VISION MMBTS LAUNCH

AGOURA HILLS LA03XC200

28030 DOROTHY DR AGOURA HILLS, CA 91301 AGOURA HILLS

ISSUE DATE:

02/24/2012

ISSUED FOR:

100%CD's

12 CITY COMMENTS	KV
12 CITY COMMENTS	D'
12 100%CD's	D
12 ISSUED FOR 90% CD REVIEW	AN
12 ISSUED FOR 90% CD REVIEW	DA
DESCRIPTION	INITI
	12 ISSUED FOR 90% CD REVIEW 12 ISSUED FOR 90% CD REVIEW 12 100%CD's

LICENSURE:



SHEET TITLE:

GENERAL NOTES

SHEET NUMBER:

REVISION:

Г-3



BATTERY INFORMATION /NOTES:

EAST PENN MANUFACTURING BATTERY MEG.:

MODEL No.:

2.17 GALLONS FLECTROLYTE CONTENT PER BATTERY:

FLECTROLYTE HAZARD CLASSIFICATION PER '07 C.F.C. (8.7 % SULFURIC ACID):

No. OF BATTERIES TO BE INSTALLED: 20 MAX. (20 PER CABINET)

TOTAL ELECTROLYTE CONTAINED ON SITE (2.17 x 20 = 43.4):

A. QUANTITIES OF 500 GAL, OR LESS ARE EXEMPT PER TABLE 3-E OF THE

B. SINGLE VESSEL CAPACITIES OF 20 GAL OR LESS, AND AGGREGATE QUANTITIES NOT IN EXCESS OF 100 GAL, ARE EXEMPT PER ARTICLE 64 OF

CHANTITIES LESS THAN 50 GAL, ARE EXEMPT FROM C.F.C. ARTICLE 80, AND SHALL NOT REQUIRE PERMIT.

ANY CHANGES OR ADDITIONS TO BACK-UP BATTERIES MUST COMPLY WITH 2007 C.F.C. ARTICLE 64, AND SHALL NOT CONTAIN ELECTROLYTE QUANTITIES IN EXCESS OF 50

GENERATOR ACCESSORIES
1. MAIN LINE CIRCUIT BREAKER-100 AMPS, INSTALLED ON GENERATOR
2. VOLTAGE REGULATOR ±2%
3. SAFEGUARD BREAKER

ENGINE FLECTRICAL ACCESSORIES

1. ELECTRONIC/ISOCHRONOUS GOVERNOR

2. BATTERY RACK, CABLES AND STARTING
BATTERY SYSTEM-LEAD ACID TYPE

3. BATTERY CHARGER-AUTOMATIC 6 AMP

ABBREVIATION

DEFENITION

NCHOR BOLT

ANCHOR BOLT
ABOVE
ANTERNA CABLE COVER ASSEMBLY
ADDITIONAL
ABOVE FINISHED FLOOR
ADDITIONAL
ABOVE FINISHED FLOOR
ADDITIONAL
ABOVE FINISHED FLOOR
ADDITIONAL
ABOVE FINISHED GRADE
ALLMENATE
ALLMENATE
APPROXIMATE(LY)
AMERICAN WIRE GAUGE
BUILDING
BLOCKING
BOUNDAY
ANGLE
BOTTOM OF FOOTING
BACK-UP CABINET
CABINET
CABINET
CANTILEVER(ED)
CAST IN FLACE
CEILING
CLEAR
COLING
CLEAR
CONNECTION (OR)
CONNECTIO MAS.
MAS.
MAS.
MAS.
MAS.
M.B.C.
MFR.
MISC.

FABRICATION(OR)
FINISH FLOOR
FINISH GRADE
FINISH(ED)
FOURDATION
FACE OF CANCRETE
FACE OF CANCRETE
FACE OF MALL
FINISH SUBFACE
FOOTING
GROWTH (CABINET)
GAUGE
GALVANIZE(D)
GROWTH GLUE LAMINATED BEAM
GROUND FALL
FOOTING
GROWND FALL
FOOTING
GAUGE
GALVANIZE(D)
GROWND FALL
FOOTING
FOOTING
GROWND FALL
FOOTING
FOOTIN HEIGHT ISOLATED COPPER GROUND BUS HEIGHT
SOLATED COPPER GROUND BUS
INCH(ES)
INCH(ES)
INTERIOR
POUND(S)
LAG BOLTS
LINEAR FEET (FOOT)
LONG(TUDINAL)
MASONRY
MAXIMUM
MACHINE BOLT
MECHANICAL
MANUFACTURER
MINIMUM
MISCELLANEOUS
METAL
NEW
NOT TO SCALE
ON CENTER
OPENING
PRECAST
OPENING
PERSONAL
COMMUNICATION SERVICES
PERSONAL
POWER POTECTION CABINET
PRIMARY RADIO CABINET
POUNDS PER SOLARE FOOT
POUNDS PER SOLARE FOOT
POUNDS PER SOLARE FOOT
POUNDS PER SOLARE INCH
PRESSURE TREATED

DEFENITION

POWER (CABINET) (R) REF.NF. (R) RE

DEFENITION

ABBREVIATION

POWER (CABINET)
QUANTITY
RADIUS
REFERENCE
REINFORCEMENT(ING)
REQUIRED
REGULE
RADIO REMOTE UNIT
SCHEDULE
SHEET
SIMILAR
SPECIFICATION(S)
SOUARE
STANLESS STEEL
STANLESS
STANLESS
STEEL
STRUCTURAL
TEMPORARY
THICK(NESS)
TOWER MOUNTED AMPLIFIER
TOE NAIL TOWER MOUNTED AMPLIFIER
TOE NAL
TOE NAL
TOE OF ANTENNA
TOP OF EURB
TOP OF FURB
TOP OF FURB
TOP OF FURB
TOP OF STEEL
TOP OF WALL
TYPICAL
UNDER GROUND
UNDERWRITERS LABORATORY
UNLESS NOTED OTHERWISE
VERIFY IN FIELD
WIDE WIDTH
WITH
WOOD
WEATHERPROOF
WEIGHT
CEMTERLINE
PLATE Sprint*

Alcatel·Lucent



PROJECT INFORMATION:

NETWORK VISION MMBTS LAUNCH

AGOURA HILLS LA03XC200

28030 DOROTHY DR AGOURA HILLS, CA 91301 AGOURA HILLS

ISSUE DATE:

02/24/2012

ISSUED FOR:

5

3

100%CD's

REVISIONS REV. DATE 02/24/12 ISSUED FOR 90% CD REVIEW B 03/13/12 ISSUED FOR 90% CD REVIEW C 03/28/12 100%CD's DY 10/8/12 CITY COMMENTS DY 10/16/12 CITY COMMENTS KW

NOT FOR CONSTRUCTION UNLESS LABELED AS CONSTRUCTION SET

LICENSURE:



SIGNAGE, NOTES, & ABBREVIATIONS

SHEET NUMBER

REVISION:

Г-4

FIRE DEPARTMENT NOTES:

A. FIRE DEPARTMENT FINAL INSPECTION REQUIRED. SCHEDULE INSPECTION 2 DAYS IN ADVANCE.

B. A CFC PERMIT TO OPERATE BATTERY SYSTEMS WITH STATIONARY LEAD-ACID BATTERIES IS NOT REQUIRED FO THE QUANTITIES ON SITE.

C. A CFC PERMIT MAY BE REQUIRED FOR THE HAZARDOUS MATERIALS ON SITE.

D. A HAZARDOUS MATERIALS IDENTIFICATION SIGN IS REQUIRED FOR ALL ENTRANCES INTO BATTERY STORAGE AREAS. LETTERS MUST BE AT LEAST 1" IN HEIGHT AND IN A COLOR WHICH CONTRASTS TO THE BACKGROUND OF THE SIGN AND LIST THE FOLLOWING:

CLASS 1 WATER REACTIVE LIQUID
TOXIC LIQUID
CORROSIVE LIQUID
OTHER HEALTH HAZARD LIQUID

E. AN APPROVED METHOD TO NEUTRALIZE SPILLED ELECTROLYTE SHALL BE PROVIDED IN THE BATTERY ROOM.

F. BATTERIES SHALL BE PROVIDED WITH SAFETY VENTING CAPS.

G. LOCATIONS AND CLASSIFICATIONS OF EXTINGUISHERS SHALL BE IN ACCORDANCE WITH THE UNIFORM FIRE CODE STANDARD 10-1 AND PLACEMENT IS SUBJECT TO APPROVAL OF THE FIRE

H. STORAGE, DISPENSING OR USE OF ANY FLAMMABLE AND COMBUSTIBLE LIQUIDS, FLAMMABLE AND COMPRESSED GASES, AND OTHER HAZARDOUS MATERIALS SHALL COMPLY WITH UNIFORM FIRE CODE REGULATIONS.

I. EXIST DOORS SHALL BE ABLE TO OPEN FROM THE INSIDE WITHOUT THE USE OF KEY OR ANY SPECIAL KNOWLEDGE OR EFFORT.

J. ADDRESS NUMBERS SHALL BE A MINIMUM 6 INCHES HIGH AND PLAINLY VISIBLE FROM ROADWAY BUILDING IS ADDRESSED ON.

K. REQUIRED SIGNAGE SHALL INCLUDE LETTERING HEIGHT OF AT LEAST ONE INCH, IN A COLOR THAT CONTRASTS TO THE SIGN BACKGROUND, AND SHALL BE PROMINENTLY DISPLAYED. L. REQUIRED SIGNAGE SHALL INCLUDE, BUT MAY NOT BE LIMITED TO, APPLICABLE TYPES FROM

ABBREVIATIONS

WARNING

ARREVIATION

THIS FACILITY CONTAINS CORROSIVE LIQUID **TOXIC LIQUID**



CLASS 1 WATER REACTIVE LIQUID

BATTERY INFO & FIRE DEPT NOTES

EXAMPLES SHOWN HEREIN (SEE SIGNAGE).

HAZARDOUS MATERIAL SIGNAGE



REQUIRED NFPA SIGNAGE

IN CASE OF **EMERGENCY** - CALL -1-866-400-6040

SITE NUMBER: LA03XC200 **AGOURA HILLS** SITE NAME:

EMERGENCY CONTACT SIGNAGE



Radio frequency fields at this site may exceed FCC rules for human exposure.

For your safety, obey all posted signs and site guidelines for working in radio frequency environments. n promiera atriagna Consumos

NOTICE

this point may exceed the FCC eneral public exposure limit.



Introductional Federal Companies Committee and Federal Committee (CEP) | EILTA

Beyond this point: Radio frequency fields at this site exceed the FCC rules for human

WARNING

Failure to obey all posted signs and alte guidelines for working in radio frequency environments could result in serious inju

SITE IDENTIFICATION SIGNAGE

RF SIGNAGE

LAOBYCZUO

The City of Agoura Hills

AGREEMENT TO CONDITIONS OF APPROVAL

L Rob Lingta, of Cox Catifonia PCS, Inc., applicant for Conditional Use Permit Case No. 98-CUP-015, have need the Candisons of Approval Island in Pleaning Commission Reportation No. 508. 1 understand and agent to comply with all Candisons of Approval of Case No. 88-CUP-012 1 understand that Island to comply with the Candisons of Assumed man result in the provision of the SCENIGHOUSE VIEW STATES.

5-23-97

Conditions of Approver Case No. 96-CUF-6(3)
Page 2

O

•

1

The applicant shall pubult an austal monitoring raport, proposed by a faceneed engineer, to the Planning and Contensity Development Director for the purpose of democrations that the finitiny is in compliance with regulations entablished by the Telenial Communications Communication regarding electromagnetic field emission. The award report shall be due one (1) year than the date of approved of the angle purpose and each year thereafter. The applicant shall pur first the cost of probes of emission regarding electromagnetic field in the cost of probes of the cost of probes of the cost of probes of emissions and purpose the cost of probes of emissions and purpose the cost of probes of emissions and proposed to the cost of probes of emissions and the cost of probes of emissions are cost of emissions and the cost of probes of emissions and the cost of emissions are cost of emissions and the cost of emissions and the cost of emissions are cost of emissions and the cost of emissions are cost of emissions and the cost of emissions are cost of emissions and the cost of emissions are cost of emissions and the cost of emissions are cost of emissions and the cost of emissions are cost of emissions and the cost of emissions are cost of emissions are cost of emissions are cost of emissions and emissions are cost of emissions are cost of emissions are cost of emissions and emissions are cost of emissions are cost of emissions are cost of emissions are cost of emissions and emissions are cost of em

20(8) Agrana Court Suits 192 Agenra Hills, CA 9130;-4355 - Tolephone (818) 597-7500 - Fan (814) 597-7552

facoler as is familia, the operator shall ecoperus with sity autosparsi applicants for wiveless communications facilities in the visitity with regard to possible on-iconoles. Such autospared applications will be midgest to City approved of a repenter perceit as is required by the regulations in effect at the time of application submitted.

Upon installation of the facility, the applicant shall provide verbase verification for review and approved by the Director of Planning and Community Dovelopment that the assesses installation complies with Federal Contents Contents rates, the Natural Exercise Code, the American National Standards Invition, and any applicable published factoril standards that one of any applicable provided and maintenance of electric and calcio Disputery explanes. The power levels of each assesses that he weight the applican and approved by the Director of Planning and Community Development upon installation.

RESOLUTION NO 538

1 11; 2

-4

0

A RESOLUTION OF THE PLANNING COMMUSSION OF THE CITY OF ACQUIRA HELLS APPROVENG CONDITIONAL USE PERMIT NO. 96-CUP-013

THE MANNING COMMISSION OF THE CITY OF AGOURA HELLS HEREBY FINDS, RESOLVES AND OUDSIES AS POLLOWS:

Section 1. An application was daily find by Cor California PCS, Inc., with respect to the red property located at 20030 Dweethy Drive, Assessor's Parcel Number 2004-013-017, requesting a Conditional Use Purels to allow eight (8) well-accented uniconstant autocontest and accellary roof-contest of uniconstant autocontest with an antichard work and teleconomisation autocons. (Case No. 96-CLP-013). A Public Hessing was daily held on Agril 10, 1997, and on Agril 24, 1997 at 6.30 p. as. in the Commit Chamber, Cuy Fell, 10101-104 Agraen Churs, Salte 103, Agraen Hills, California 91301. Notice of the time, date and planes and purpose of the alternation was daily given.

<u>Section.2.</u> Evidence, both webten and oral, was duly presented to and tred by the Planning Commission at the afterestid Public Hearing.

Section 3. The Planning Commission finds, journage to the Agrows Hills to, the:

The proposed use, as conditioned, is consistent with the objectives of the Zeeing Ordinance and the purposes of the district in which the use is brasted. The stand purpose of the firetime is which the use is brasted. The stand purpose of the Freeway Consider During District is to encapsize the importance of the Seeway condition to the chyls brange and Stanze Involvement. The wall-mounted actions will not impost the visual quality of the thurway in that the customes will brind in with the building by being spaced four first sport, pairced to match the building and will not convex fine beingth of the nord pumpet.

The proposed use, as conditioned, will comply with each of the applicable provisions of the g Ordinance relative to the cas, the property location, and the aments beight.

3. The proposed use, as conditioned, is compatible with the nurrounding properties. The subject percei is abunted by Devodry Drive and two-or-drive story effice brillings to the north, a snedeal office building to the west, and sensor office building to the use, and sensor leafs to the south. The use is consistent with the BP-OR Zone which is appropriate for this type of see in that it does not immediately abut a snedential zone and the sees provides a consummination service to the comparabilitations are and the mightbeing 10 Taxway.

4. The proposed use and the conditions under which it would be operated or estimated will not be destinated in the public health, suffer, or welfare. Cellular teleptone Michigas on regulated from the Public Utilities Constraints as a patient cuting which have addressed better hard suffery manes. The applicant will be experient to administration under the constraints and an experience of the contract teleptone to the contract teleptone to the contract teleptone teleptone of the workets selectone understand healthy.

CITY OF AGOURA HILLS

April 10, 1997

96-CUP-013

CENERAL PLAN DESIGNATION: EP-OR Guines Park-Office/Retail

Con California PCS, Inc. has filed a Conditional Use Persoit Application, exquanting to install eight (8) well-excussed sciencementation assesses in groups of flue on the mod paraget of an estimate present of the deliber located at 2000 Descript Direct. The estimates are to be used for estillar simplement arrivator. A group of flour (4) beloncementation nationals are perspected to be placed on the conth side of the west building elevation. A group of flour (4) additional assesses are proposed to be placed on the conth side of the sea building elevation. All the parageo-excussed outcomes of contents have demanded to 51 inches in high, 6 inches in width, and three inches in depth. The assesses will be appeared 4 feat to part and princial to a count the building elevation tentific.

The accordance will be placed just below the top of the roof pursue. 43% above ground level to the top of the accordance. The accordance will be inconscend by consent debte to experience cultures that will be located near the south end of the roof. The equipment culturate as 5 feet in beight and will consider the 64° high roof purpose. A 30° over accordance in the proposed to be mounted on the

Request for approval of a Conditional Use Permit to allow eight (5) well-troussed teleconstruction anternas and seven (7) ancillary reof-mousted equipment televists with an etmehad

Commission Execute Store CEOA (Class 3) Staff recommends approved of Conditional Use Permit Case No. 95-CUP-013, subject to Conditions, based on the Endings of the approved conditions.

Planning Commission Cox Caldbrein PCS, Inc. 18200 Von Kerman Avez Irvina, CA 92612

UR63XLZOS

ACTION DATE

APPLICANT

CASE NOS

LOCATION

REQUEST

RECOMMENDATION

ZONING DESIGNATION.

ENVIRONMENTAL DETERMINATION

PROJECT DESCRIPTION

0

5. The proposed was, as conditioned, is consistent with the goals, objectives and policies of the General Flam. The General Flam caths for the maintenance of a quality visual aspertence along the entire target of the south influence of twoling production and enhancement of views. The reproduct size and location of the proposed are and location of the proposed are seen and encourage of the proposed are seen and encourage of the proposed are the area of the contribution of the proposed area and appeared and the policy and area of the proposed area.

Section 5. Based on the afbrevantioned findings, the Planning sization hereby approves Conditional Use Parath Case No. 95-CUP-913, subject to attached sizes, with respect to the property described in Section 5.

PASSED, APPROVED and ADOPTED this 30th day of April, 1997, by the Salaming vote to wit.

Hendricks, Koehler, Reisburdt, Walton None Friedt None

DEAFT RESOLUTION NO

A RESOLUTION OF THE PLANNING COMMISSION OF THE CITY OF AGOURA HELLS APPROVING CONDITIONAL USE FEBRIT NO. 96-CUF-013

THE PLANNING COMMISSION OF THE CITY OF AGOURA HELLS HEREBY FINDS, RESOLVES AND ORDERS AS FOLLOWS:

Section 1.

An application was shift Bird by Cost Chiffornia PCS, Irc., with respect to the real property located at 28000 Decemby Brens, Assessor's Passed Number 2061-013-017, requesting a Contributed Une Pursate to their eight (by well-constant disclorations asterons, and sactility troof-constant opagement exhibits with an assesshed used unbecommunication assessment (Case Vo. 97-CUP-031). A Public Herman was ship had on Apel 10, 1977, or 510 p or in the Countil Chambert, Corp Holl, 30101 Agears Cons., Soles 100, Agears Hills, California 91301. Notice of the inne, does and place and autopeace of the abstrasial towards why silves.

Section 2 Evidence, both votices and coul, was duly presented to and Section.) The Planning Commission Ends, pursuant to the Agoura Hith

The proposed tree, as conditioned, is consistent with the objectmens of the Ziming Ordennous and the purposes of the district in which the use is located. The mand purposes of the Feneracy Corridor between the tree of the only the proposes of the Seveny contriber to the only the longer and Manne indigenant. The well-constant attentions will not impain the vision quality of the Seveny in that the interests will be used in with the building by being queed four their apart, pulsed to metch the building and will not consider the highly of the respect to metch the building and will not consider the highly of the respect to the second of the se

The proposed use, as conditioned, will comply with much of the applicable provisions of the professor relative to the use, the property location, and the selection being it.

The proposed use, so consistent, is compatible with the surrounting properties. The subject read is should by Dorothy Drive and involvables many effect haldings to the sent, a method office diding to the west, and subsect office buildings to the earth sents had not the sent. The use is unusers with the BP-CRI Zeas which is appropries for this type of use in that it does not mediately when a replaced zeros and the use provides a communication service to the controllables are sent after the light depth of the provides a communication service to the controllables are sent after the light-bring (10 Fernancy).

The proposed use and the conditions under which it would be operated or excitational will not be should be the conditions and the condition are regulated foreign the fitting before the condition of the condition of the condition of compliance will be regulated to all they will be not additional backbase and story teams. The applicant will be regulated to solve the vertication of compliance with all applicable.

5. The proposed use, as conditional, is condition with the goods, objectives and policies of the General Flam. The General Flam cells for the maintenance of a quality visual suspections along the entire longs of the section light-year through postudents and elements on 6 they. The proposed statement of the proposed seasons, as conditionally, all not obsect the section forms to the service of continuous will be placed directly on the purpose buildings and, quality for the expert a building will, quality for the expert a building will, quality for the expert and pointed in exactly the buildings and out not executed to highly of the read pumper. Thus the assesses will not crosses a visual distriction or below, when along the fibroury confider.

CONSTRONS OF APPROVAL (CASE NO. TOUR 413)

0 STANDARD CONDITIONS

- This decision, or any appears of this decision, can be appealed to the City Council within fifthem (15) days from the date of this action, subject to filing the appropriate forms and subject
- Except as encoding hards, the approval of this action is limited to and requires complete confirmation to the approved Site Plan, Roof Plan. Elevation Plan, and Assesse. Description
- This action shall not be afflictive for any purpose until the applicant and property owner have agreed in writing that applicant and property owner a a immer of, and accepts, all Conditions of Approved of this penult with the Department of Floreing and Community Development.
- It is hereby declared to be the lessest that if any provision of this pursuk is held or ductiond invalid, the pursuk shall be void and the privileges graceed horounder shall lapter.
- It is further declared and made a Condition of this action that if any Condition havin to violated, this permit shall be mapmated and the privileges greated between thall layer, provided then the applicant has been given vertices notice to come such violation and has failed to do so within fairty (10) days.
- 0 All requirements of the Zoulog Ordinator and the specific storing of the subject property reset be compiled with unders our furth in the Conditional Use Portrict.
 - The applicant shall obtain all required parents for the project from the Department of Building and Safety,
 - Operation of the use shall not be granted until all Conditions of Approval have been complied with as determined by the Director of Planning and Community Development.
 - Unless this puresh is used within two (2) years from the date of City approved, Conditional Use Fermit No. 96-CUP-013 shall expire.

SPECIAL CONDITIONS

- The assumes shall be painted to metch the exterior building color as approved by the Director of Flanning and Community Development.
- No wires or cables shall be visible on the outside of the building. All wires and cables shall be located behind the editing paraget.
- The applicant shall install most shidding below the coof-mounted equipment cablests, in a manner approved by the Director of Planning and Constrainty Development and the Department of Building and Safety. 0

CONDITIONS OF APPROVAL (CASE NO 96-CLP-013)


STANDARD CONDITIONS

- This decision, or any aspects of this decision, can be appealed to the City Council within fifteen (15) days from the date of this action, adjust to filing the appropriate forms and related
- coupt as modified herein, the approval of this action is fimilial to and requires complete confirmation to the approved Site Plan. Roof Plan. Elevation Plan, and Antenna Description
- This action shall not be effective for any puspose until the applicant and property owner have agreed in vertices that applicant and property owner are aware of, and accepts, all Conditions of Approved of this partner with the Department of Flunting and Contensing Development.
- It is further declared and made a Condition of this action that if any Condition hards is volumed, this permit shall be asspended and the privileges ground forwarder shall lapse, provided that the applicant has been given written notice to come such violation and has falled to do so within thirty (10) skys
- ments of the Zoning Ordenmor and the specific scoring of the subject property must d'with unless set forth in the Conditional Uni Pornit.
- The applicant shall obtain all required patriets for the project floor the Department of Building and Safety.

 - Unless this permit is used within two (2) years from the date of City approved, Conditional Lite Permit No 96-CLP-006 shall expire

- The assesses shall be painted to match the exterior building color as approved by the Director of Physician and Community Development
- No wore or dates shall be visible on the outside of the building. All wires and eaties shall be located behalf the origing purpore.
- Upon institution of the facility, the applicant shall provide voltate verification for review and approval by the Director of Penning and Commently Development that the anisona institution confesses with Penderal Commissions rates, the Nucleonial Estantic Code, the American Nucleonial Stantisch: Institute, and any capitalists published infanted stantisch: that permit no concentrations field exposure trades and face the institutions and stantisches and stantisch that permit not return to the confession of approval type in Director of Penning and Commission Development upon institutions.

Sprint*

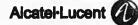



PROJECT INFORMATION:

NETWORK VISION MMBTS LAUNCH

AGOURA HILLS

LA03XC200

28030 DOROTHY DR AGOURA HILLS, CA 91301 AGOURA HILLS

ISSUE DATE:

02/24/2012

ISSUED FOR:

100%CD's

REV.	DATE	REVISIONS DESCRIPTION	INTIALS
A	02/24/12	ISSUED FOR 90% CD REVIEW	DAR
В	03/13/12	ISSUED FOR 90% CD REVIEW	AMF
С	03/28/12	100%CD's	DY
A	10/8/12	CITY COMMENTS	DY
A	10/16/12	CITY COMMENTS	KW

LICENSURE:



ZONING DOCUMENTS

SHEET NUMBER:

REVISION:

-5



CITY OF AGOURA HILLS

CONDITIONAL USE PERMIT - BURDEN OF PROOF

28030 Dorothy Drive

LA200

- A. The requested use at the location proposed will not:
 - Adversely affect the health, peace, comfort or welfare of persons residing or working in the secrounding area, or
 - Be malerially detrimented to the use, enjoyment or valuation of property of other persons located in the vicinity of the site, or
 - Jeopardize, endanger at otherwise constitute a menace to the public health, unfaity or general welfare because:

The proposed project consists of a roof/building incurred, unmanned wireless triacommunications facility. The sits is an existing office building in the BP-OR-PC cone. The building will accommodes the antennas and related equipment on the roof and along the perimeter of the structure, and will not utilize any leasable space. Being unmanned, the proposed use requires no packing, has no impacts on circulation and will generate an online, odor, amoles or other adverse impacts to adjacent hand use.

The requested use at the proposed location will provide an invaluable public benefit in the event of smergericine (traffic aexidents, crime reporting, etc.) and natural disastents (narthquakes, firm, etc.) by providing reliable viscines electronimunications in these situations. This service will be used by public safety entities and virtually any entity which must have seliable, portable communications for emergency attustions. The proposed use also will provide a sulfable and convenient means of communication for everyday personnal and business use.

The Federal Communications Commission (FCC) licenses all wireless telecommunications facilities, including PCS. This installation will comply with all FCC rules and standards.



DEPARTMENT OF PLANNING AND COMMUNITY DEVELOPMENT

ACTION DATE: February 1, 2001

TO: Pleasing Commission

APPLICANT: Negati Communication

310 Commerce Irvine, CA 92602-1300

irvine, CA 92602-1300 00-CUP-013

LOCATION: 28030 Dorothy Drive

CASE NO.:

RECUIEST:

Request for approval of a Conditional Use Permit to allow an annument wireless triccommunication facility including four (4) wall-incusted assertance and four (4) and incusted asserts as the condition of the properties of the pr

ENVIRONMENTAL DETERMINATION: Categorically Exempt from CEQA (Class 3)

RECOMMENDATION: Soft money
No. 00-CU

Staff seconmends approved of Conditional Use Permit Case No. 00-CUP-013, subject to Conditions, based on the findings of the attached resolution.

ZONING DESIGNATION: BP-OR-FC (Business Park-Office Resail-Freeway Corridor)
GENERAL PLAN DESIGNATION: Business Park-Office/Retail

I. PROJECT BACKGROUND AND DESCRIPTION

Needel Communications is proposing the construction of an unmanned whreless telecommunications facility at 28300 Denothy Drive in Agount Hilbs. There is vacant land to the nouth and office buildings are becared to the cast, west, and sorth of the subject property. Due to the location of this building above and adjacent so the 101 Freeway, this size is presently occupied by two other vertices astecommensationtors providers. Previous approval has been given for a total of 12 wall-encented antennae and four roof-mounted unstranse on this building (Case Nos. 95-CUP-053 and 96-CUP-013). The newly proposed facility would consist of four new wall-mounted entermae painted to match the building and four antennae to the monated directly noto the surface of the enternated roof. A Sherghast noting material would be placed over the mannard-mounted antennae to hide them from view.

Planning Commission

Case No. 00-CUP-013 (Nextel)

While a small portion of landscaping would be lost to this equipment cablest, this landscaping area is covered by the building and has been buren for some time. In return for noticing the attract national landscape sets. Inoverte, the applicant has agained to provide quala landscaping in other sense on the rise and so refurbish the plantings in the relating landscape planters. Specifically, sinempovements would include scenerals give into of the voltage box in the northeast covers of the size with a buildy, rejuventing the existing landscape planters with plants with more height, adding when to the low wills across the four of the property, and adding a landscape planter (equal to the amount of landscaping lost to the squipment box) between the two gamps doors on the west side of the building. These landscape istems would help improve the appearance of the castring site and landscaping.

9. Conditional Use Permit Findings

The Zoulag Ordinance allows whether telecommunication facilities in the Shokness Park-Office Result Zone cast of Palo Connado Caryon Road on properties which from on Dorothy Drive, subject to agreemed of a Conditional Use Permit by the Harming Commission. In order to approve a Conditional Use Permit for the facility, the following Studings must be made.

The Planning Commission tenst first find that the proposed use is consistent with the objectives of the Zozlag Code and the purposes of the district in which the use is located, and that the proposed use will comply with each of the applicable provisions of the Zozlag Code. The four proposed was unit comply with each of the applicable provisions of the Zozlag Code. The four proposed was necessary to world be accreted by fiberglands singles that look like the existing noof clies. This proposed would comply with the applicable provisions of the Zozlag Colisance relative to the star, the proposery location, and the antenna height. The proposed location was chosen after nonsideration of other locations for optimals evenings are also give to 10 Fewery and its high wrings point in the city. The stated purpose of the Feetway Consider Overlay District is to encognize the importance of the foreway consider to the city is indige and fature development. The placenator of these entennae is consistent with the Planning Commission's prior actions regarding wireless telecommunication facilities.

Another funding that the Planning Construintion must make is thus the proposed use is computible with the summerfunding properties. The proposed wireless telecommunication facility is permitted in this zone and this particular site has been chosen as an appropriate use for the facility because it is located close to the freeway in a business district, and does not immediately about a residential zone. The use would provide a communication service to the neighboring constructual area and 101 Freenance.

The Planning Commission must also find that the proposed use and the conditions under which is would be operated or natinational will not be destinented to the public health, safety, or welfare. Cellular inclination exceeds beauth and safety issues. It approved by the Planning Commission as a public utility and have addressed health and safety issues. It approved by the Planning Commission, staff recommends the amenona installation comply with PCC rules, the National Electric Code, AMSI, and any applicable published federal students that persian to electroscapacite field exposure limits and the safe installation and maintenance of electric and radio Brequency equipment.

DRAFT RESOLUTION NO. --

A RESOLUTION OF THE PLANNING COMMISSION OF THE CITY OF AGOURA HILLS APPROVING CONDITIONAL USE PERMIT NO. 60-CUP-013

THE PLANNING COMMISSION OF THE CITY OF AGOURA HILLS HEREBY FINDS, RESOLVES AND ORDERS AS FOLLOWS:

Section L. An application was duly filed by Nextel Communications with seapect to the real property located at 20010 Denotry Drive, Assessor's Parcel Number 2061-013-037, requienting a Conditional Use Pennis for a wireless telecommunication facility consisting of four (4) wall-mounted and four (4) measured-mounted antenane on an office building. A Public Hearing was duly held on February 1, 2001, at 6-30 p.m. in the Council Chambers, City Hall. 30101 Agains Cons., Saire 107, Against Hills, California 91301. Notice of the time, there and place and purpose of the aforesaid was shuly given.

<u>Section 2.</u> Evidence, both written and one, was duly presented to and considered by the Planning Commitmion at the aforesaid Public Hearing.

Section 3. The Planning Controllston finds, pursuant to the Agoura Shills Zoning Ordinance, that:

 The proposed use, as conditioned, is consistent with the objectives of the Zuning Code and the purposes of the discrict in which the use is located. The attack purpose of the Freeway Corridor Overlay District is in recognizing the improviment of the freeway corridor to the city's image and finare development. The ficility would not negatively impact the visual quality of the freeway corridor because it would not be readily visible from the negligious theseuse or Aquara Road.

2. The proposed use, as conditioned, will comply with each of the applicable provisions of the Zoning Code. The antennee and accompanying facility, as proposed by the applicant will comply with the applicable provisions Business Part-Office Result zone relative to the use, the property location, amontes height, and storening. The untennees would not be accessible to the public or potentiars, and the paint end fiberglass scoring will ensure the facility would not be readily visible from a distance.

3. The proposed use, as conditioned, is compatible with the surrounding properties. Vacant land and office buildings are the only surrounding land uses. This particular size is natiable for such a two because it does not immediately about a residential zone, it is anostly surrounded by vacant land and office buildings, and the use provides a communication service to the neighboring commercial area and 101 Faceway. The proposed wheeless telecommunication facility is consistent with the Business Park-Office Renal zone and would be an appropriate use for the area.

4. The proposed use and the conditions under which it would be operated or maintained will not be detrimened to the public health, safety, or welfare. Cellular schephone facilities are regulated through the Same Public Utilities Commission, as a public utility which have addressed health and safety issues. If approved by the Planeing Commission, staff recommends the antenna installation comply with FCC rules, the National Electric Code, ANSI, and any applicable published federal standards that persian to electroscapacite field exposure familia and the safe installation and maintenance of electric and radio frequency equipment.

Sprint'





PROJECT INFORMATION:

NETWORK VISION MMBTS LAUNCH

AGOURA HILLS

28030 DOROTHY DR AGOURA HILLS, CA 91301 AGOURA HILLS

ISSUE DATE:

02/24/2012

ISSUED FOR:

100%CD's

		REVISIONS	
REV.	DATE	DESCRIPTION	INITIALS
A	02/24/12	ISSUED FOR 90% CD REVIEW	DAR
В	03/13/12	ISSUED FOR 90% CD REVIEW	AMF
С	03/28/12	100%CD's	DY
Δ	10/8/12	CITY COMMENTS	DY
Δ	10/15/12	CITY COMMENTS	KW

NOT FOR CONSTRUCTION UNLESS LABELED AS CONSTRUCTION SET

LICENSURE:



SHEET TITLE:

ZONING DOCUMENTS

SHEET NUMBER:


REVISION:

T-6



app DE . www.fosho.com

•

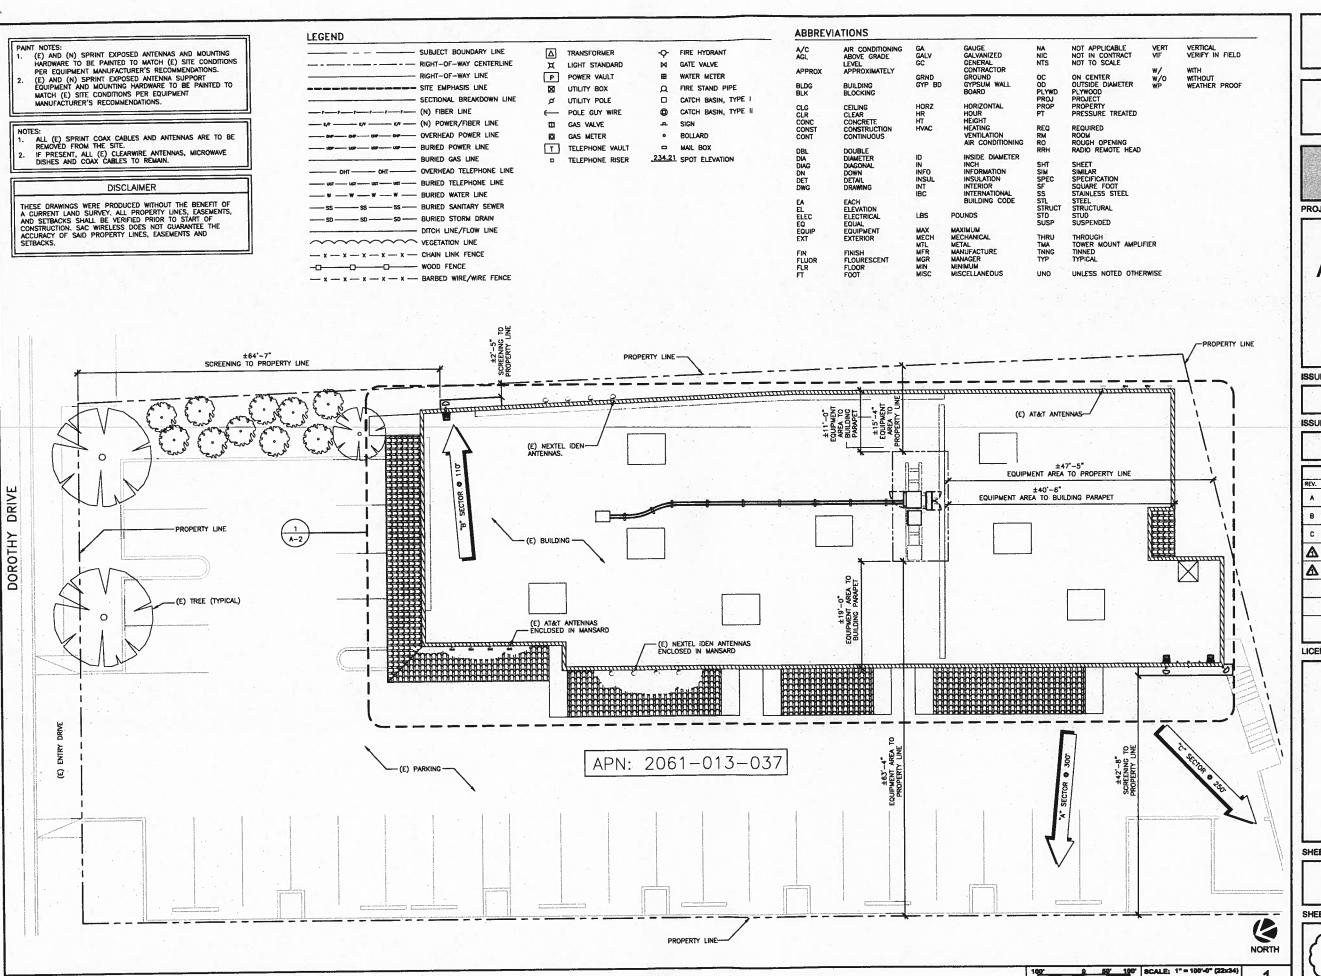







SRIS AYENDIA ENCHAS CARLSBAD, CA 22008 WWW.SECH.com PSO.795.5200

PROJECT INFORMATION:

NETWORK VISION MMBTS LAUNCH

AGOURA HILLS

28030 DOROTHY DR AGOURA HILLS, CA 91301 AGOURA HILLS

ISSUE DATE:

02/24/2012

ISSUED FOR:

REV. DATE DESCRIPTION IN A 02/24/12 ISSUED FOR 90% CD REVIEW B 03/13/12 ISSUED FOR 90% CD REVIEW C 03/28/12 100%CD's			REVISIONS	
B 03/13/12 ISSUED FOR 90% CD REVIEW	REV.	DATE	DESCRIPTION	INITIA
	À	02/24/12	ISSUED FOR 90% CD REVIEW	DAS
C 03/28/12 100%CD's	В	03/13/12	ISSUED FOR 90% CD REVIEW	AMI
	C	03/28/12	100%CD's	DY
10/8/12 CITY COMMENTS	Δ	10/8/12	CITY COMMENTS	DY
10/16/12 CITY COMMENTS	Δ	10/16/12	CITY COMMENTS	kw

NOT FOR CONSTRUCTION UNLESS LABELED AS CONSTRUCTION SET

LICENSURE:




SHEET TITLE:

OVERALL SITE PLAN


SHEET NUMBER:

REVISION:

 \triangle

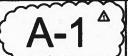



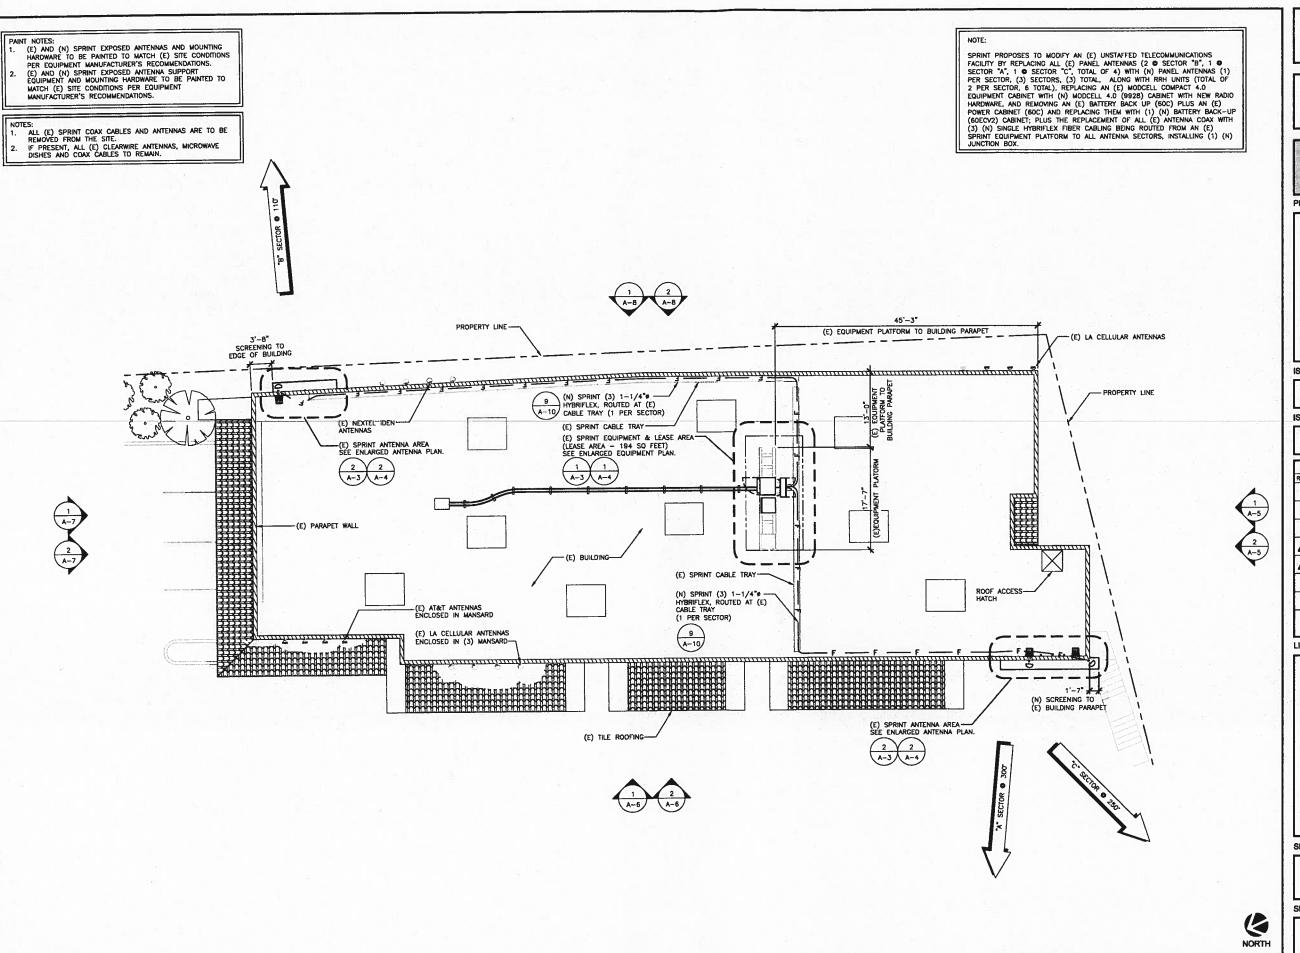







CARLEBAD: CA 22008 WWW.RECH.COM 760.796.8200

PROJECT INFORMATION:

NETWORK VISION MMBTS LAUNCH

AGOURA HILLS

28030 DOROTHY DR AGOURA HILLS, CA 91301 AGOURA HILLS

ISSUE DATE:

02/24/2012

ISSUED FOR:

100%CD's

		REVISIONS	
REV.	DATE	DESCRIPTION	INITIALS
A .	02/24/12	ISSUED FOR 90% CD REVIEW	DAR
В	03/13/12	ISSUED FOR 90% CD REVIEW	AMF
C	03/28/12	100%CD's	DY
Δ	10/8/12	CITY COMMENTS	DY
Δ	10/16/12	CITY COMMENTS	kw

LICENSURE:



SHEET TITLE:

ROOFTOP PLAN

SHEET NUMBER:


0 4' 8' SCALE: 1/8" = 1'-0" (22:34)
(OR) 1/4" = 1'-0" (11x17)

REVISION:


A-2



ROOFTOP PLAN

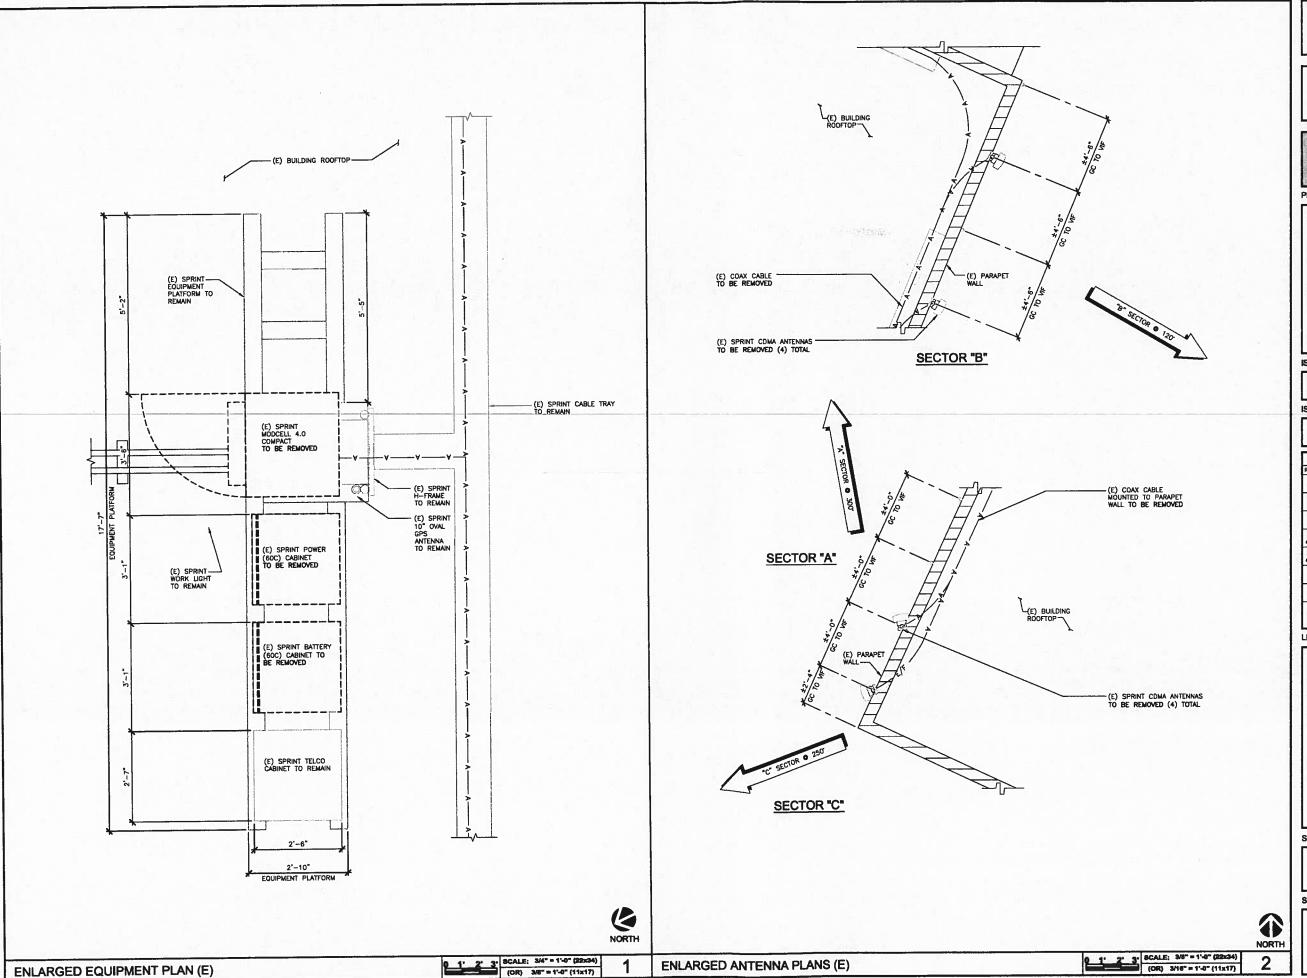



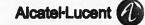



PROJECT INFORMATION:

NETWORK VISION MMBTS LAUNCH

AGOURA HILLS LA03XC200

28030 DOROTHY DR AGOURA HILLS, CA 91301 AGOURA HILLS

ISSUE DATE:

02/24/2012

ISSUED FOR:

100%CD's

C 03/28/12 100%CD's D 10/8/12 CITY COMMENTS D	A		ISSUED FOR 90% CD REVIEW ISSUED FOR 90% CD REVIEW	DAR
				DY
10/16/12 CITY COMMENTS K	Δ	10/8/12	CITY COMMENTS	DY
	Δ	10/16/12	CITY COMMENTS	KW

LICENSURE:



SHEET TITLE:

ENLARGED ANTENNA & EQUIPMENT PLANS (E)


SHEET NUMBER:

REVISION:



THE INFORMATION CONTAINED IN THIS SET OF CONSTRUCTION DOCUMENTS IS PROPRIETARY BY NATURE. ANY USE OR DISCLOSURE OTHER THAN THAT WHICH RELATES TO CARRIER SERVICES IS STRICTLY PROHIBITED.

ENLARGED EQUIPMENT PLAN (E)

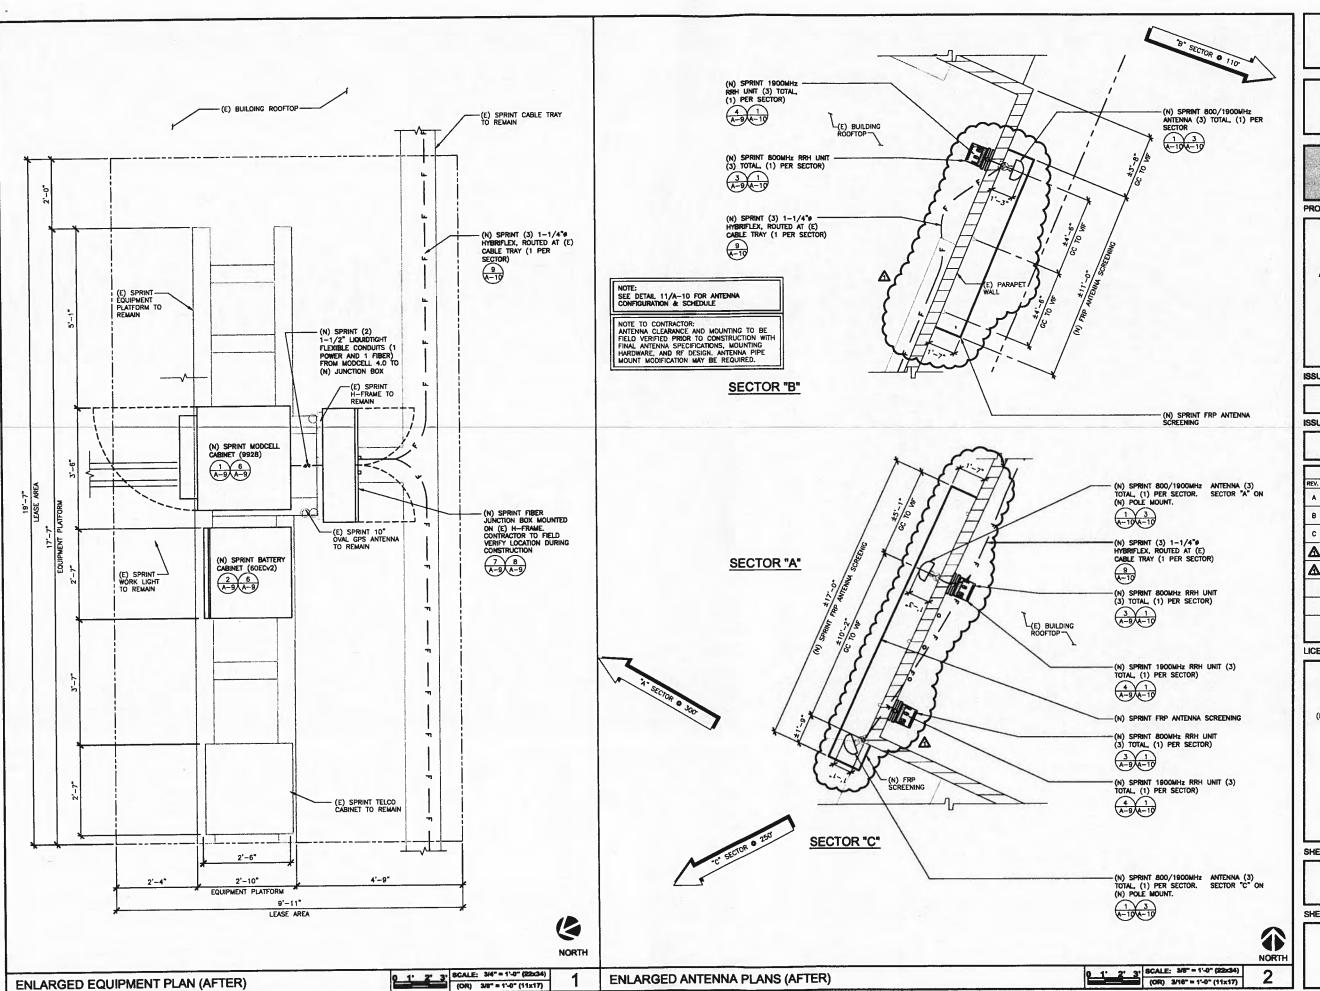







GBS AVENDA ENCINAS CARLEBAD. CA 62008 WWW.comm.com 780.798.8000

PROJECT INFORMATION:

NETWORK VISION MMBTS LAUNCH

AGOURA HILLS

28030 DOROTHY DR AGOURA HILLS, CA 91301 AGOURA HILLS

ISSUE DATE:

02/24/2012

ISSUED FOR:

100%CD's

		REVISIONS	411
REV.	DATE	DESCRIPTION	INITIALS
A	02/24/12	ISSUED FOR 90% CD REVIEW	DAR
8	03/13/12	ISSUED FOR 90% CD REVIEW	AMF
C	03/28/12	100%CD's	DY
Δ	10/8/12	CITY COMMENTS	DY
Δ	10/16/12	CITY COMMENTS	kw
		T FOR CONSTRUCTION UNLESS RELED AS CONSTRUCTION SET	

LICENSURE:



SHEET TITLE:


ENLARGED ANTENNA & EQUIPMENT PLANS (N)

SHEET NUMBER:

REVISION:

A-4



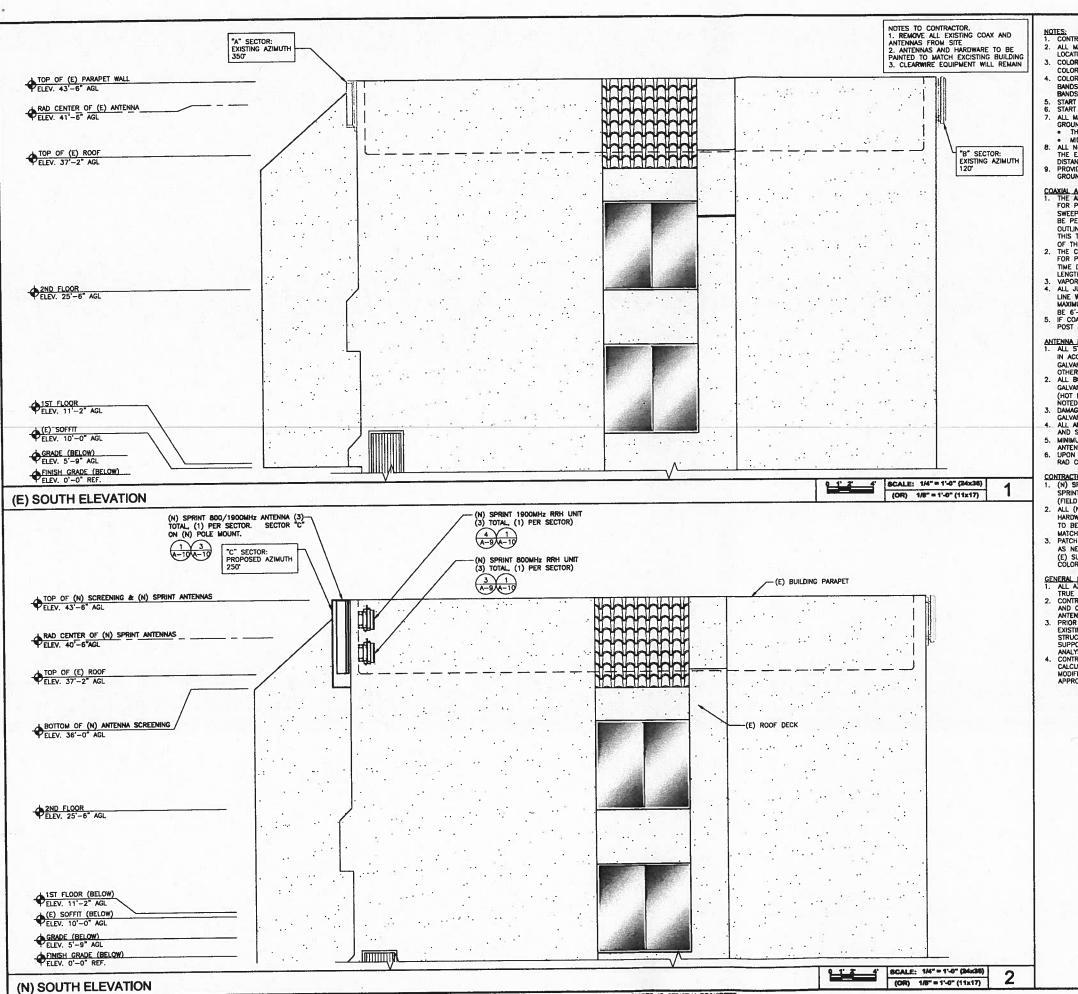

- NOTES:
 1. CONTRACTOR TO FIELD VERIFY ANTENNA CABLE LENGTHS.
 2. ALL MAIN CABLES WILL BE COLOR CODED AT THREE (3) LOCATIONS.
- COLOR CODE ALL ANTENNA AND COAX WITH 2" WIDE BANDS OF COLORED TAPE WITH 1" SEPARATION BETWEEN BANDS
 4. COLOR CODE ALL TOP AND BOTTOM GROUND KITS WITH 1" WIDE
- BANDS OF COLORED TAPE WITH 1/2" SEPARATION BETWEEN BANDS.
- 5. START COLOR BANDS 2" BEYOND WEATHERPROOFING.
 6. START SECTOR COLOR NEXT TO END CONNECTOR.
 7. ALL MAIN CABLES WILL BE GROUNDED W/ COAXIAL CABLE GROUND KITS AT:
- GROUND KITS AT:

 THE ANTENNA LEVEL

 MID LEVEL IF TOWER IS OVER 200'
 ALL NEW GROUND BAR DOWNLEADS ARE TO BE CADWELDED TO THE EXISTING ADJACENT GROUND BAR DOWNLEADS A MINIMUM DISTANCE OF 4FT BELOW GROUND BAR PROVIDE BUSS BAR NEAR BTS FOR ATTACHMENT OF WIMAX COAX GROUND KITS

COAXIAL ANTENNA CABLE NOTES:

1. THE ANTENNA COAXIAL CABLE INSTALLER SHALL BE RESPONSIBLE FOR PERFORMING AND SUPPLYING SPRINT WITH 3 TYPEWRITTEN SWEEP TESTS (ANTENNA RETURN LOSS TEST). THIS TEST SHALL BE PERFORMED TO THE SPECIFICATIONS AND PARAMETERS OUTLINED BY THE SPRINT RADIO FREQUENCY (RF) ENGINEER.
THIS TEST SHALL BE PERFORMED PRIOR TO FINAL ACCEPTANCE

- THIS TEST SHALL BE PERFORMED PRIOR TO FINAL ACCEPTANCE
 OF THE SITE/
 OF THE COAXIAL ANTENNA CABLE INSTALLER SHALL BE RESPONSIBLE
 FOR PERFORMING AND SUPPLYING SPRINT WITH 3 TYPEWRITTEN
 TIME DOMAIN REFLECTOMETER (TDR) TESTS TO VERIFY CABLE
 LEINGTH AND TO CHECK FOR WATER DAMAGE.
 3. VAPOR WRAP WILL BE USED TO SEAL ALL CONNECTIONS.
 4. ALL JUMPERS TO THE ANTENNAS FROM THE MAIN TRANSMISSION
 LINE WILL BE 1/2" JUMPERS AND SHALL NOT EXCEED 6"-0".
 MAXIMUM LENGTH FOR THE JUMPERS AT WIMAX BTS UNITS WILL
 DEC 6"-0".
- BE 6'-0".

 5. IF COAX IS BEING RE-USED FOR THIS INSTALLATION, PRE AND POST ANTENNA LINE SWEEPS ARE REQUIRED.

- ANTENNA MOUNTING NOTES:

 1. ALL STEEL MATERIALS SHALL BE GALVANIZED AFTER FABRICATION IN ACCORDANCE WITH ASTM A123 "ZINC (HOT-DIPPED GALVANIZED) COATINGS ON IRON AND STEEL PRODUCTS", UNLESS OTHERWISE NOTED.

 2. ALL BOLTS, ANCHORS AND MISCELLANEOUS HARDWARE SHALL BE GALVANIZED IN ACCORDANCE WITH ASTM A153 "ZINC-COATING (HOT DIP) ON IRON AND STEEL HARDWARE", UNLESS OTHERWISE NOTED.
- NOTED.

 3. DAMAGED GALVANIZED SURFACES SHALL BE REPAIRED BY COLD GALVANIZING IN ACCORDANCE WITH ASTM A780.

 4. ALL ANTENNA MOUNTS SHALL BE INSTALLED WITH DOUBLE NUTS AND SHALL BE INSTALLED SHOULTS.

 5. MINIMUM HORIZONTAL SPACING SHALL BE 2'-0" BETWEEN ALL ANTENNAS.

 6. UPON COMPLETION, PROVIDE A HEIGHT VERIFICATION DEPICTING RAD CENTER AND TOP OF ANTENNA.

- CONTRACTOR NOTES:
 1. (N) SPRINT FIBER LINES FROM (E)/(N) EQUIPMENT, TO (N) SPRINT ANTENNAS ARE TO FOLLOW (E) FIBER/COAX ROUTE (FIELD VERIFY).
- ALL (N) MATERIALS (ANTENNAS, EQUIPMENT /RRH'S AND ALL HARDWARE) THAT ARE EXPOSED (NOT BEHIND SCREENING) ARE TO BE PAINTED (PER MANUFACTURERS RECOMMENDATIONS) TO
- TO BE PAINTED (FER MANOFACTORERS RECOMMENDATIONS) TO MATCH (E) BUILDING FINISH.

 3. PATCH AND REPAIR EXISTING MATERIALS, FINISHES, WALLS, ETC. AS NEEDED TO PROVIDE A SEAULESS TRANSITION FROM (N) TO (E) SUFFACES. (N) CONSTRUCTION MUST MATCH (E) BUILDING COLOR, FINISH AND TEXTURE.

- GENERAL NOTES:

 1. ALL AZIMUTHS ARE TO BE ESTABLISHED CLOCKWISE FROM THE TRUE NORTH HEADING.

 2. CONTRACTOR SHALL VERIFY PROPOSED ANTENNA RAD CENTER AND ORIENTATIONS WITH SPRINT PRIOR TO INSTALLATION OF ANTENNAS.

 3. PRIOR TO ATTACHING ANTENNAS AND MOUNTING SECTIONS, EXISTING BUILDING WALL MUST BE ANALYZED BY A LICENSED STRUCTURAL ENGINEER TO VERIFY BUILDING WALL IS CAPABLE OF SUPPORTING THE PROPOSED LOADS. REFER TO STRUCTURAL ANALYSIS BY OTHERS.

 4. CONTRACTOR SHALL REFER TO BUILDING WALL STRUCTURAL CALCULATIONS FOR ADDITIONAL LOADS. NO ERECTION OR MODIFICATION OF BUILDING WALL SHALL BE MADE WITHOUT APPROVAL OF STRUCTURAL ENGINEER.







PROJECT INFORMATION:

NETWORK VISION MMBTS LAUNCH

AGOURA HILLS LA03XC200

28030 DOROTHY DR AGOURA HILLS, CA 91301 AGOURA HILLS

ISSUE DATE:

02/24/2012

ISSUED FOR:

100%CD's

		REVISIONS	
REV.	DATE	DESCRIPTION	INITIALS
A	02/24/12	ISSUED FOR 90% CD REVIEW	DAR
В	03/13/12	ISSUED FOR 90% CD REVIEW	AMF
С	03/28/12	100%CD's	DY
Δ	10/8/12	CITY COMMENTS	DY
Δ	10/16/12	CITY COMMENTS	KW

NOT FOR CONSTRUCTION UNLESS LABELED AS CONSTRUCTION SET

LICENSURE:




SHEET TITLE:


(E) & (N) SOUTH ELEVATIONS

SHEET NUMBER


REVISION:

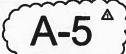



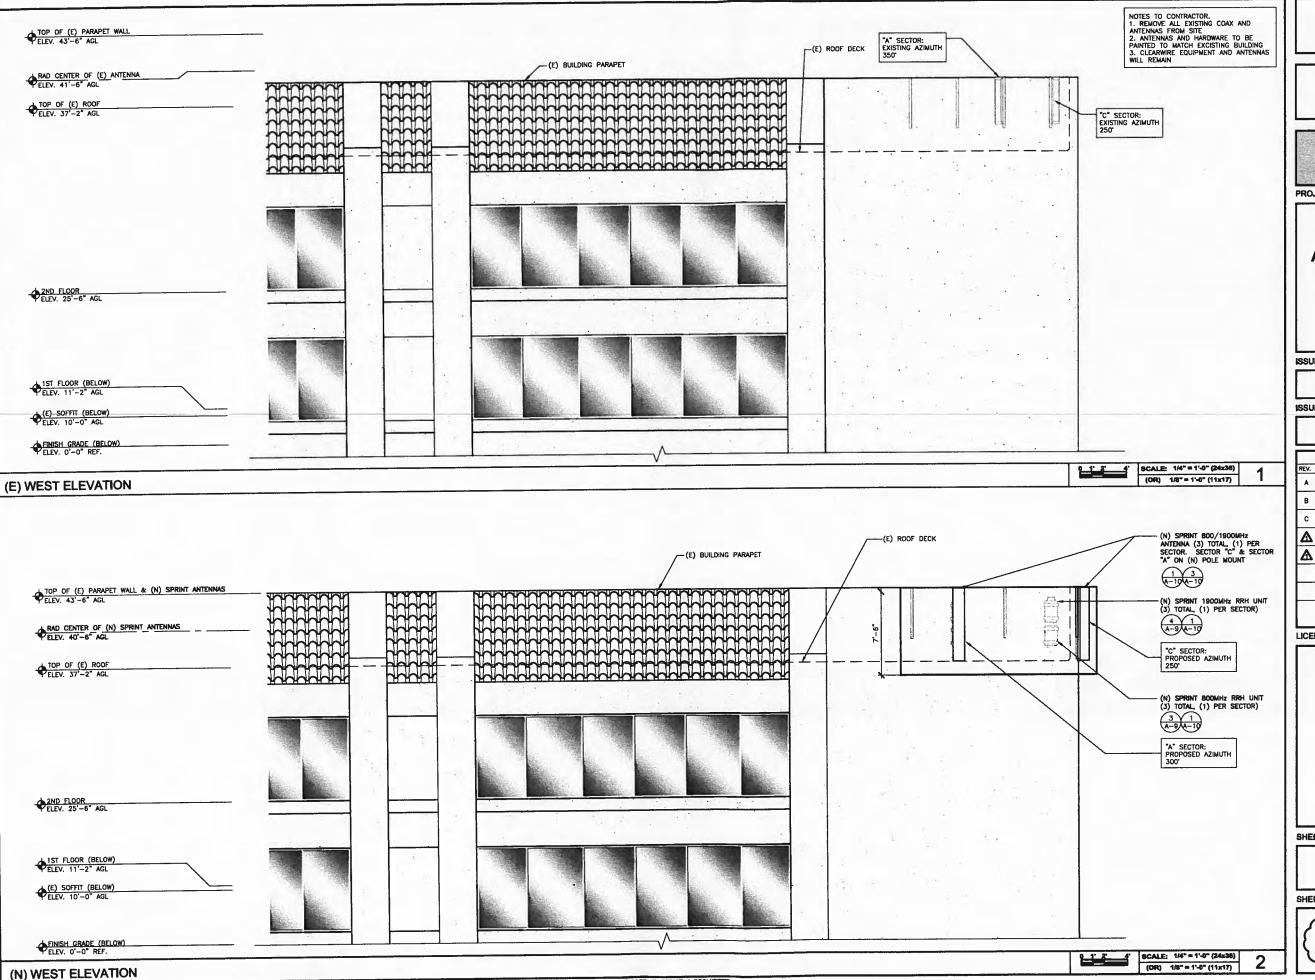

Sprint

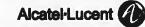



PROJECT INFORMATION:

NETWORK VISION MMBTS LAUNCH

AGOURA HILLS

LA03XC200

28030 DOROTHY DR AGOURA HILLS, CA 91301 AGOURA HILLS

ISSUE DATE:

02/24/2012

ISSUED FOR:

100%CD's

		REVISIONS	
REV.	DATE	DESCRIPTION	INITIALS
A	02/24/12	ISSUED FOR 90% CD REVIEW	DAR
В	03/13/12	ISSUED FOR 90% CD REVIEW	AMF
С	03/28/12	100%CD's	DY
Δ	10/8/12	CITY COMMENTS	DY
Δ	10/16/12	CITY COMMENTS	KW

NOT FOR CONSTRUCTION UNLESS LABELED AS CONSTRUCTION SET

LICENSURE:




SHEET TITLE:

(E) & (N) WEST ELEVATIONS

SHEET NUMBER:

REVISION:

1-6 ^A

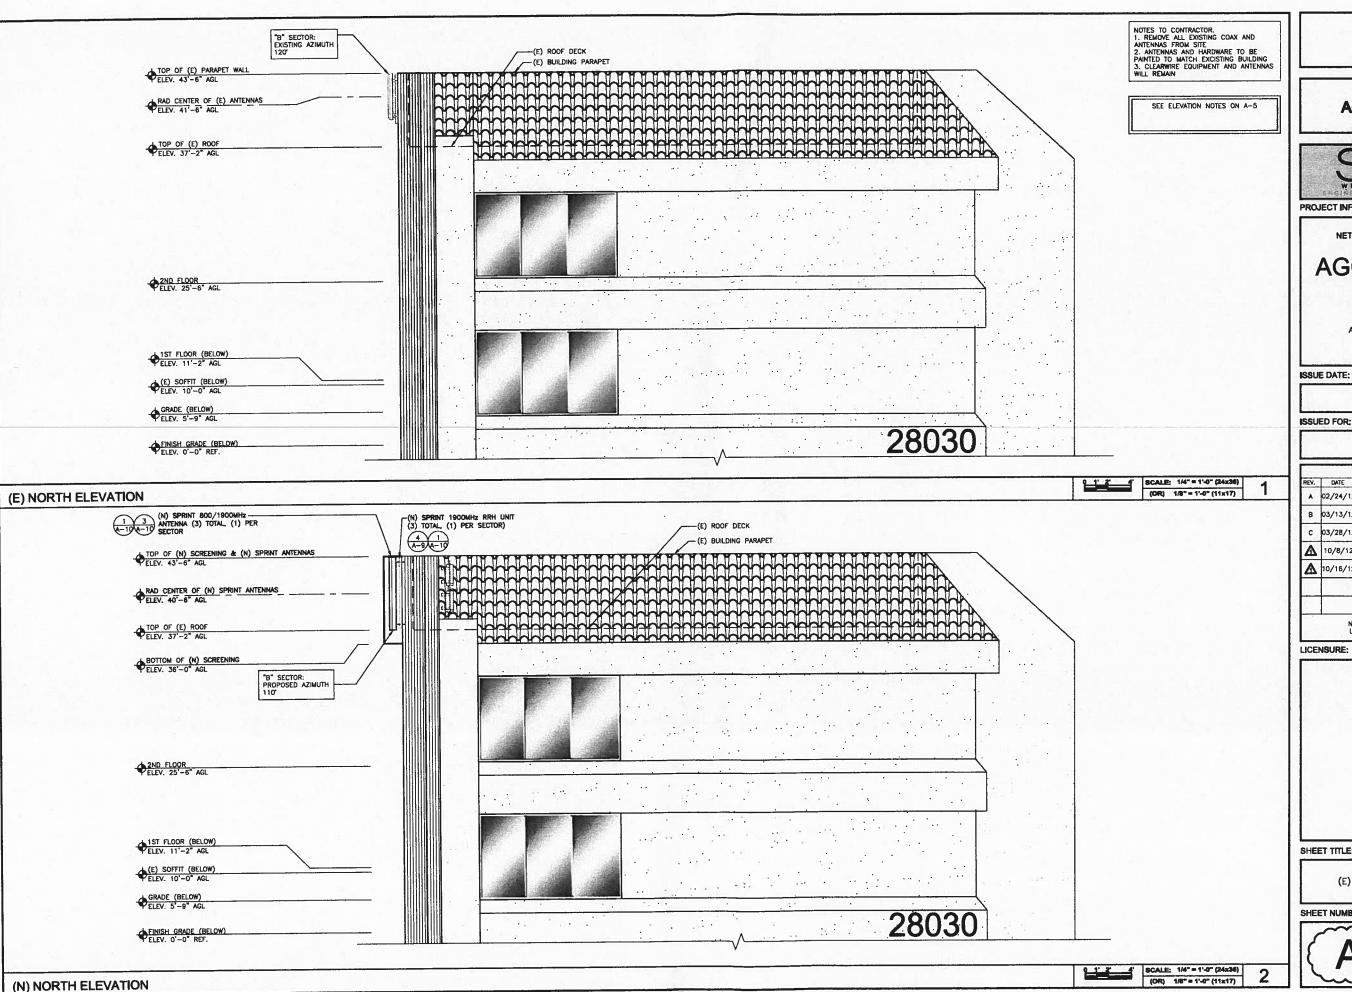

Sprint'





PROJECT INFORMATION:

NETWORK VISION MMBTS LAUNCH

AGOURA HILLS LA03XC200

28030 DOROTHY DR AGOURA HILLS, CA 91301 AGOURA HILLS

ISSUE DATE:

02/24/2012

100%CD's

	DATE	REVISIONS DESCRIPTION	INITIAL
REV.			
A	02/24/12	ISSUED FOR 90% CD REVIEW	DAR
В	03/13/12	ISSUED FOR 90% CD REVIEW	AMF
С	03/28/12	100%CD's	DY
Δ	10/8/12	CITY COMMENTS	DY
Δ	10/15/12	CITY COMMENTS	kw
			100

LICENSURE:




SHEET TITLE:

(E) & (N) NORTH ELEVATIONS

SHEET NUMBER:



REVISION:

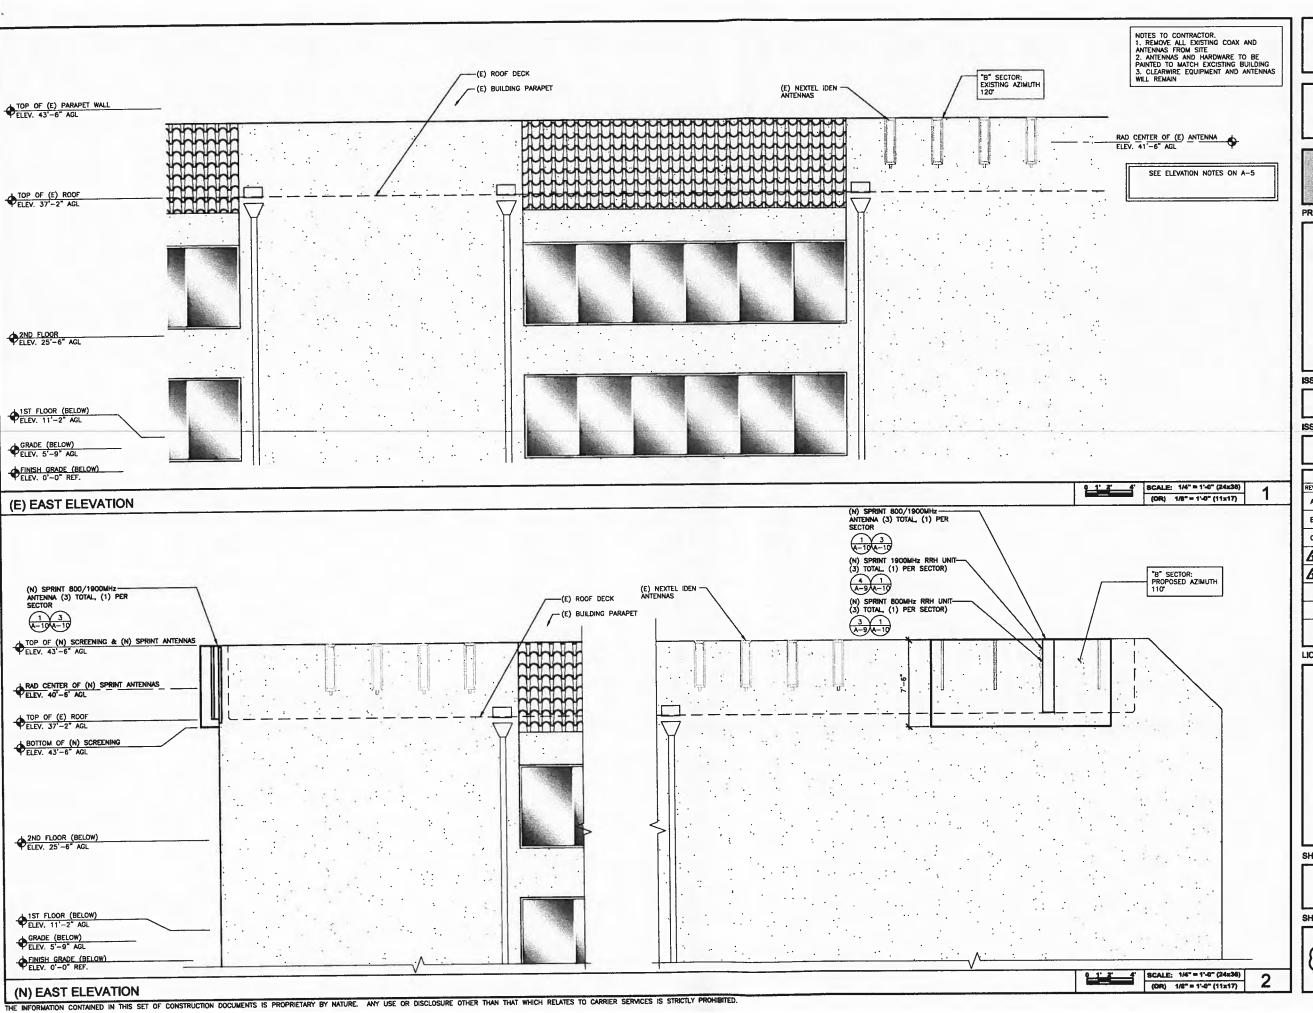







PROJECT INFORMATION:

NETWORK VISION MMBTS LAUNCH

AGOURA HILLS LA03XC200

28030 DOROTHY DR AGOURA HILLS, CA 91301 AGOURA HILLS

ISSUE DATE:

02/24/2012

ISSUED FOR:

100%CD's

REV.	DATE	REVISIONS DESCRIPTION	INITIAL
A	02/24/12	ISSUED FOR 90% CD REVIEW	DAR
В	03/13/12	ISSUED FOR 90% CD REVIEW	AMF
С	03/28/12	100%CD's	DY
Δ	10/8/12	CITY COMMENTS	DY
Δ	10/16/12	CITY COMMENTS	KW

LICENSURE:




SHEET TITLE:


(E) & (N) EAST ELEVATIONS


SHEET NUMBER:

REVISION:

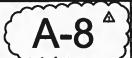




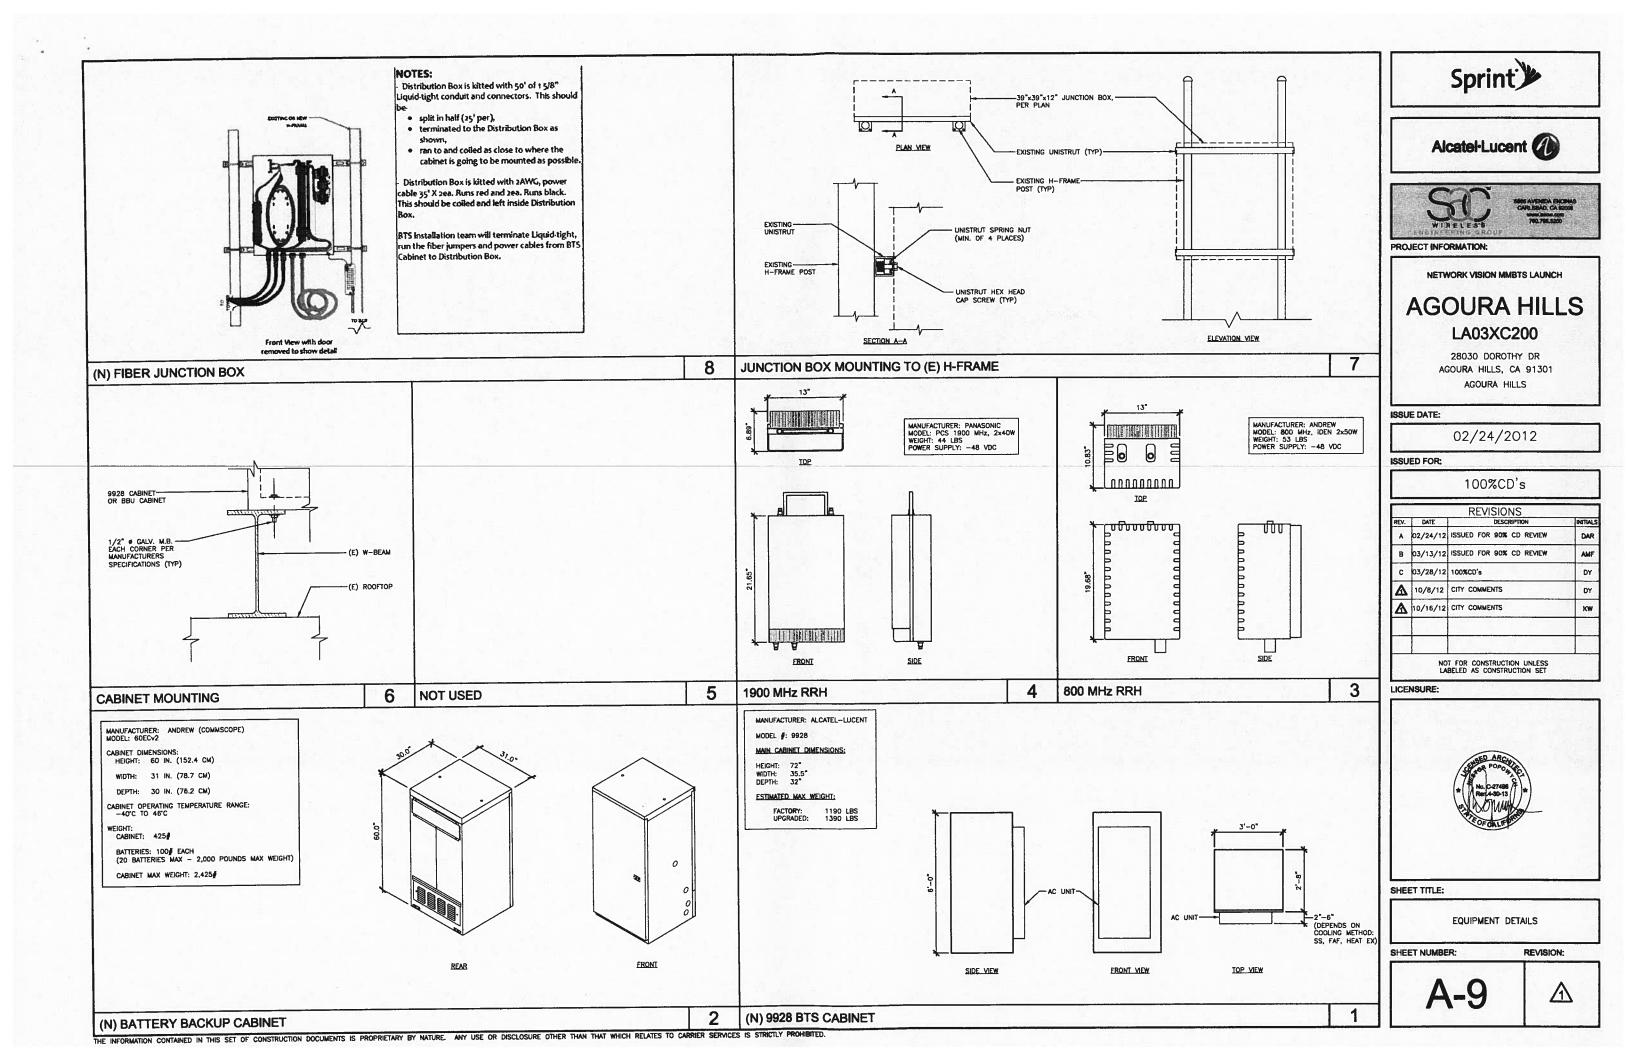

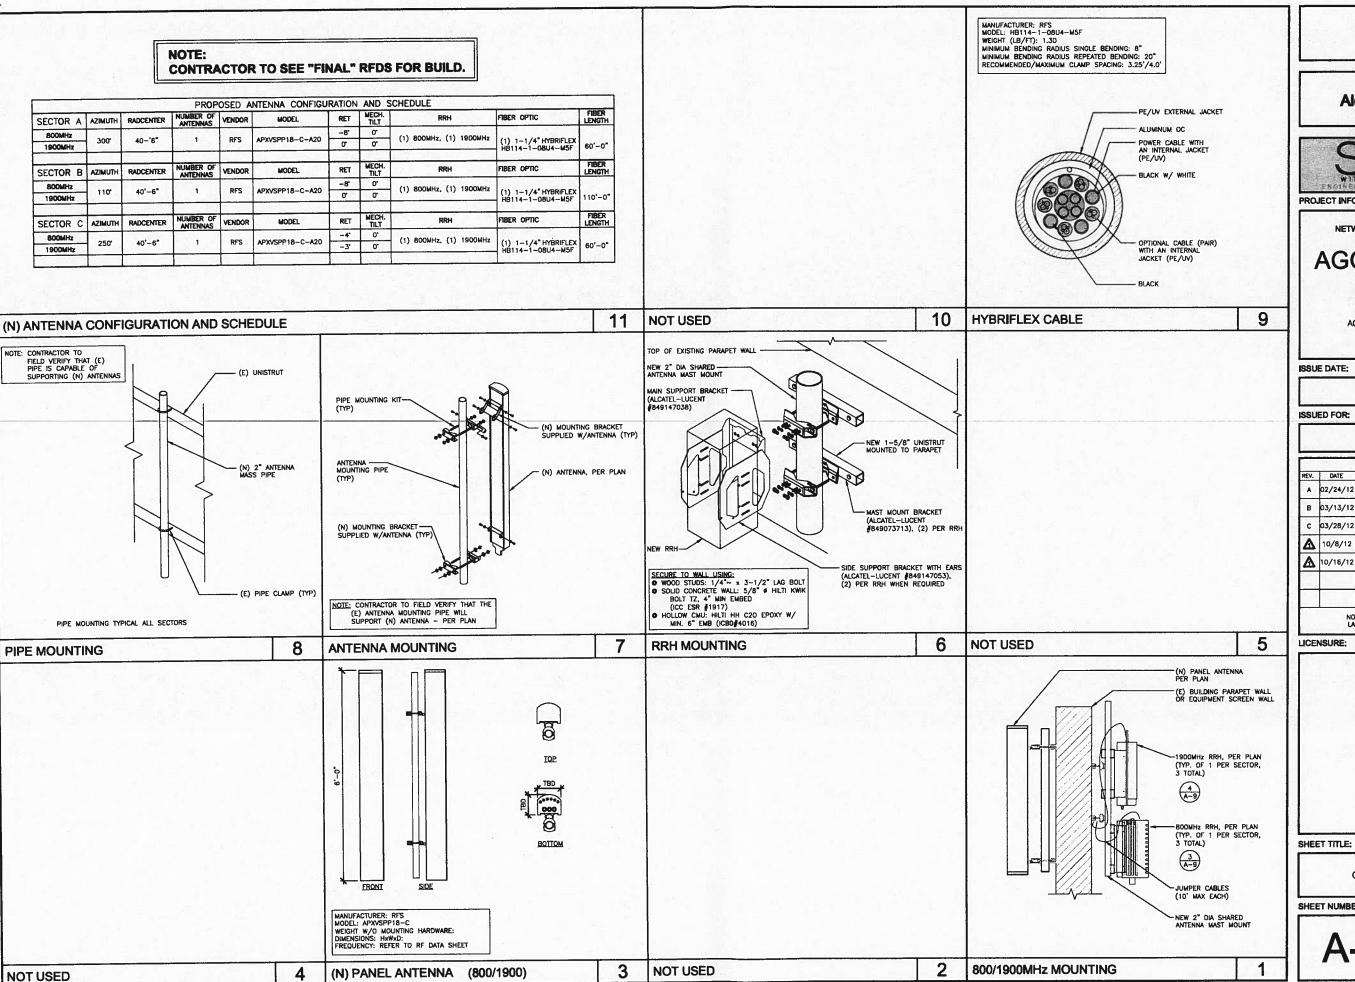



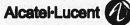



PROJECT INFORMATION:

NETWORK VISION MMBTS LAUNCH

AGOURA HILLS LA03XC200

28030 DOROTHY DR AGOURA HILLS, CA 91301 AGOURA HILLS

02/24/2012

100%CD's

		REVISIONS	
REV.	DATE	DESCRIPTION	INITIALS
A	02/24/12	ISSUED FOR 90% CD REVIEW	DAR
В	03/13/12	ISSUED FOR 90% CD REVIEW	AMF
С	03/28/12	100%CD's	DY
Δ	10/8/12	CITY COMMENTS	DY
Δ	10/16/12	CITY COMMENTS	kw
		T FOR CONSTRUCTION UNLESS BELED AS CONSTRUCTION SET	

LICENSURE:



CONSTRUCTION DETAILS


SHEET NUMBER:

REVISION:

 Λ

A-10

5 NOT USED SCALE: N.T.S.

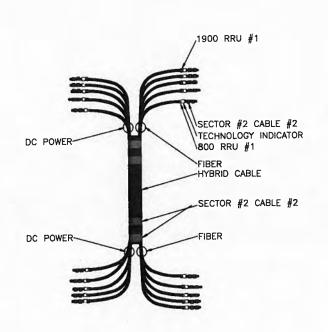

3 HYBRID CABLE COLOR CODE SCALE: N.T.S.

NO TAPE 7 NO TAPE 8 2 BETA CREEN 2 2 3 WHITE WHITE 2 4 5 2 SLATE SLATE 6 2 2 7 2 8 GREEN GREEN 3 GAMMA 3 2 3 3 3 4 WHITE WHITE 3 5 SLATE SLATE 3 6 3 3 4 COAXIAL CABLE COLOR CODE SCALE: N.T.S.

TYPICAL COAX CABLE COLOR CODING SCHEME

FIRST RING

WHITE

CABLE

2

3

4

5

6

SECTOR

1 ALPHA

1

THIRD RING

NO TAPE

GREEN

WHITE

SLATE

SECTOR LEGEND

SECTOR 6 => 6 BAND

SECOND RING

NO TAPE

NO TAPE

NO TAPE

NO TAPE

NO TAPE

NO TAPE

COLOR CODE	FIRST RING	SECOND RING
800 #1	YELLOW	GREEN
1900 #1	YELLOW	960
1900 #2	YELLOW	The Hillson
RESERVED	YELLOW	BL-14.
RESERVED	YELLOW	SLATE
RESERVED	YELLOW	- ORANGE
RESERVED	YELLOW	WHITE

2 FREQUENCY COLOR CODE SCALE: N.T.S.

ANTENNA AND CABLE COLOR CODING

(3 SECTORED / MULTIPLE RF CHANNELS)
ASSUMING 8 LINES AND ANTENNAS

SECTOR 1 ALPHA SECTOR 1 => 1 BAND SECTOR 2 => 2 BAND SECTOR 3 => 3 BAND SECTOR 4 => 4 BAND SECTOR 5 => 5 BAND

TECHNOLOGY COLOR CODE

iDEN CDMA

WiMAX


EXAMPLE - SECTOR 2, CABLE 2, 800Mhz RADIO #1 EXAMPLE - SECTOR 3, CABLE 1, 1900Mhz RADIO #1 EXAMPLE - SECTOR 1, CABLE 4, 800Mhz RADIO #1 AND 190Mh RADIO #1

COLOR BAND TO BE 2" WIDE ON MAIN LINE.
 SPACING TO BE 1" BETWEEN BANDS AND 2" BETWEEN LINE AND TECHNOLOGY BANDS. NO SPACE BETWEEN TECHNOLOGY COLOR BANDS.

3. COLOR BAND ON JUMPERS 1" WIDE W/ 1" SPACE.

START COLOR BANDS 2" BEYOND WEATHERPROOFING.

5. START SECTOR COLOR NEXT TO END CONNECTOR.

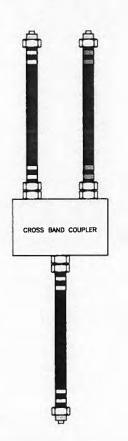

ANTENNA & CABLE COLOR CODE







PROJECT INFORMATION:

NETWORK VISION MMBTS LAUNCH

AGOURA HILLS LA03XC200

28030 DOROTHY DR AGOURA HILLS, CA 91301 AGOURA HILLS

ISSUE DATE:

02/24/2012

ISSUED FOR:

100%CD's

		REVISIONS	
REV.	DATE	DESCRIPTION	INITIAL
A	02/24/12	ISSUED FOR 90% CD REVIEW	DAR
В	03/13/12	ISSUED FOR 90% CD REVIEW	AMF
С	03/28/12	100%CD's	DY
Δ	10/8/12	CITY COMMENTS	DY
Δ	10/16/12	CITY COMMENTS	KW
		T FOR CONSTRUCTION UNLESS BELED AS CONSTRUCTION SET	

LICENSURE:



SHEET TITLE:


(N) COLOR CODING

SHEET NUMBER:

REVISION:

A-11



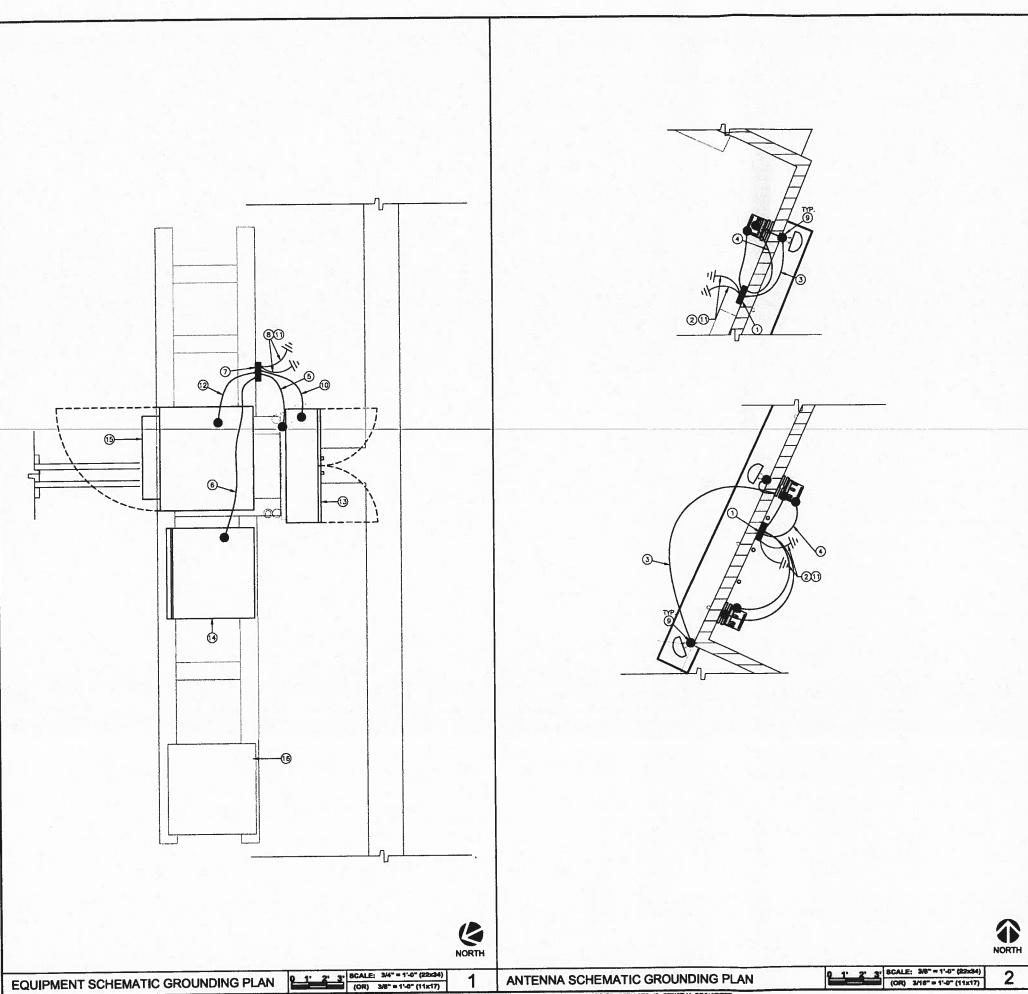



- ANTENNA GROUND BUSS BAR NEAR ANTENNA MOUNTS WITH COAX GROUND KIT. SEE DETAIL 4/E-2 FOR GROUND BAR CONSTRUCTION, SEE DETAIL 3/E-2 FOR GROUND WIRE CONNECTIONS, AND SEE DETAIL 2/E-2 FOR COAX GROUNDING.
- (2) #6 AWG GROUND FROM ANTENNA GROUND BUSS BAR TO TIE INTO
- 3 #6 AWG ANTENNA MOUNT GROUND TO ANTENNA GROUND BUSS BAR (TYP OF 6)
- 46 AWG GROUND FROM RRH UNITS TO ANTENNA GROUND BUSS
- (5) #6 AWG GROUND FROM H-FRAME TO TIE INTO (E) GROUND BUSS
- 6 #6 AWG GROUND FROM BBU CABINET TO TIE INTO (E) GROUND BUSS BAR.
- (7) (E) GROUND BUSS BAR NEAR EQUIPMENT WITH COAX GROUND KIT. SEE DETAIL 4/E-2 FOR GROUND BAR CONSTRUCTION, SEE DETAIL 3/E-2 FOR GROUND WIRE CONNECTIONS, AND SEE DETAIL 2/E-2 FOR COAX GROUNDING.
- (8) #6 AWG GROUND FROM (E) GROUND BUS BAR TO TIE INTO (E) ROOF GROUNDING SYSTEM (TYP OF (2) PLACES)
- (9) MECHANCIAL CONNECTION (TYP).
- $\textcircled{\scriptsize{0}}$ \$6 AWG GROUND FROM FIBER JUNCTION BOX TO TIE INTO (E) GROUND BUSS BAR.
- GC SHALL VERIFY (2) #6 AWG THHN GROUND LEADS FROM EACH OF TWO REMOTE INDIVIDUAL BUSES TO BE COLLECTED AT ONE MAIN MGB AND FURTHER ROUTED TO (5) BUILDING STEEL OR OTHER (E) DESIGNATED BUILDING GROUNDING SYSTEM (FINAL DESIGNATED POINT OF GROUNDING TO BE COORDINATED BETWEEN CM, GC AND BUILDING OWNER).
- (E) GROUND BUSS BAR.
- (N) SPRINT FIBER JUNCTION BOX MOUNTED ON (E) H-FRAME.
 CONTRACTOR TO FIELD VERIFY LOCATION DURING CONSTRUCTION
- (4) (N) SPRINT BATTERY CABINET (60ECV2) TO BE INSTALLED
- (5) (N) SPRINT MODCELL BTS CABINET (9928) TO BE INSTALLED
- (6) (E) SPRINT TELCO CABINET

ALL ROOF TOP GROUND LEADS SHALL BE THERMOPLASTIC HIGH HEAT-RESISTANT NYLON-COATED (THHN).

MBOL DESCRIPTION

SYMBOL DESCRIPTION

TEST WELL

COPPER GROUND ROD

MECHANICAL CONNECTION

GROUND BAR

CADWELD CONNECTION

FIELD VERIFY & TIE INTO (E) GROUNDING SYSTEM

GROUNDING NOTES & LEGEND

GENERAL GROUNDING NOTES

- ALL DETAILS ARE SHOWN IN GENERAL TERMS, ACTUAL INSTALLATION AND CONSTRUCTION MAY VARY DUE TO SITE SPECIFIC CONDITIONS.
- 2.

 GROUND ALL ANTENNA BASES, FRAMES, CABLE RUNS, AND OTHER METALLIC COMPONENTS USING GROUND WIRES AND CONNECT TO SURFACE MOUNTED BUS BARS, FOLLOW ANTENNA AND BTS MANUFACTURERS PRACTICES FOR GROUNDING REQUIREMENTS. GROUND COAX SHIELD AT BOTH ENDS AND EXIT FROM TOWER OR POLE USING MER'S PRACTICES.
- ALL GROUND CONNECTIONS SHALL BE CADWELD. ALL WIRES SHALL BE COPPER THHN/THWN. ALL GROUND WIRE SHALL BE GREEN INSULATED WIRE ABOVE GROUND.
- CONTRACTOR TO VERIFY AND TEST GROUND TO SOURCE.
 GROUNDING AND OTHER OPERATIONAL TESTING WILL BE
 WITNESSED BY SPRINT WIRELESS, LLC. REPRESENTATIVE.
- 5.
 REFER TO DIVISION 16 GENERAL ELECTRIC; GENERAL ELECTRICAL PROVISION AND COMPLY WITH ALL REQUIREMENTS OF GROUNDING STANDARDS.
- CONTRACTOR TO ABIDE BY ALL ALU / SPRINT SAFETY STANDARDS DURING SITE CONSTRUCTION.
- CONTRACTOR SHALL REFER TO ALU / SPRINT STANDARDS FOR GROUNDING CONNECTIONS & INSTALLATION METHODS.
- 8.

 ELECTRICAL CONTRACTOR TO PROVIDE DETAILED DESIGN OF GROUNDING SYSTEM. AND RECEIVE APPROVAL OF DESIGN BY AUTHORIZED SPRINT MOBILITY REPRESENTATIVE, PRIOR TO INSTALLATION OF GROUNDING SYSTEM. PHOTO DOCUMENT ALL CADWELDS AND GROUND RING
- NOTIFY CONSTRUCTION MANAGER IF THERE ARE ANY DIFFICULTIES INSTALLING GROUNDING SYSTEM DUE TO SITE SOIL CONDITIONS.


GROUNDING ROD NOTES

(WHERE APPLICABLE)

(WHER APPLICABLE) ELECTRICAL CONTRACTOR SHALL ORDER GROUND RESISTANCE TESTING ONCE THE GROUND SYSTEM HAS BEEN INSTALLED; A QUALIFIED INDIVIDUAL, UTILIZING THE FALL OF POTENTIAL METHOD, SHOULD PERFORM THE TEST. THE REPORT WILL SHOW THE LOCATION OF THE TEST AND CONTAIN NO LESS THAN 9 TEST POINTS ALONG THE TESTING LINE, GRAPHED OUT TO SHOW THE PLATEAU.

2 POINT GROUND TEST OR 3 POINT 62% TESTS WILL NOT BE ACCEPTED AS ALTERNATIVES TO THE AFORE MENTIONED GROUND TESTS TEST SHALL BE PERFORMED WHILE THE COUNTERPOISE IS ISOLATED FROM THE A/C SYSTEM GRIDS AND (E) COMMUNICATIONS FACILITY.



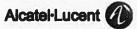



PROJECT INFORMATION:

NETWORK VISION MMBTS LAUNCH

AGOURA HILLS

28030 DOROTHY DR AGOURA HILLS, CA 91301 AGOURA HILLS

ISSUE DATE:

02/24/2012

ISSUED FOR:

100%CD's

REV.	DATE	REVISIONS DESCRIPTION	INITIALS
A	02/24/12	ISSUED FOR 90% CD REVIEW	DAR
В	03/13/12	ISSUED FOR 90% CD REVIEW	AMF
С	03/28/12	100%CD's	DY
Δ	10/8/12	CITY COMMENTS	DY
Δ	10/15/12	CITY COMMENTS	кw
			(A)

NOT FOR CONSTRUCTION UNLESS
LABELED AS CONSTRUCTION SET

LICENSURE:



SHEET TITLE:


SCHEMATIC GROUNDING PLAN

SHEET NUMBER:

REVISION:

E-1

 \triangle

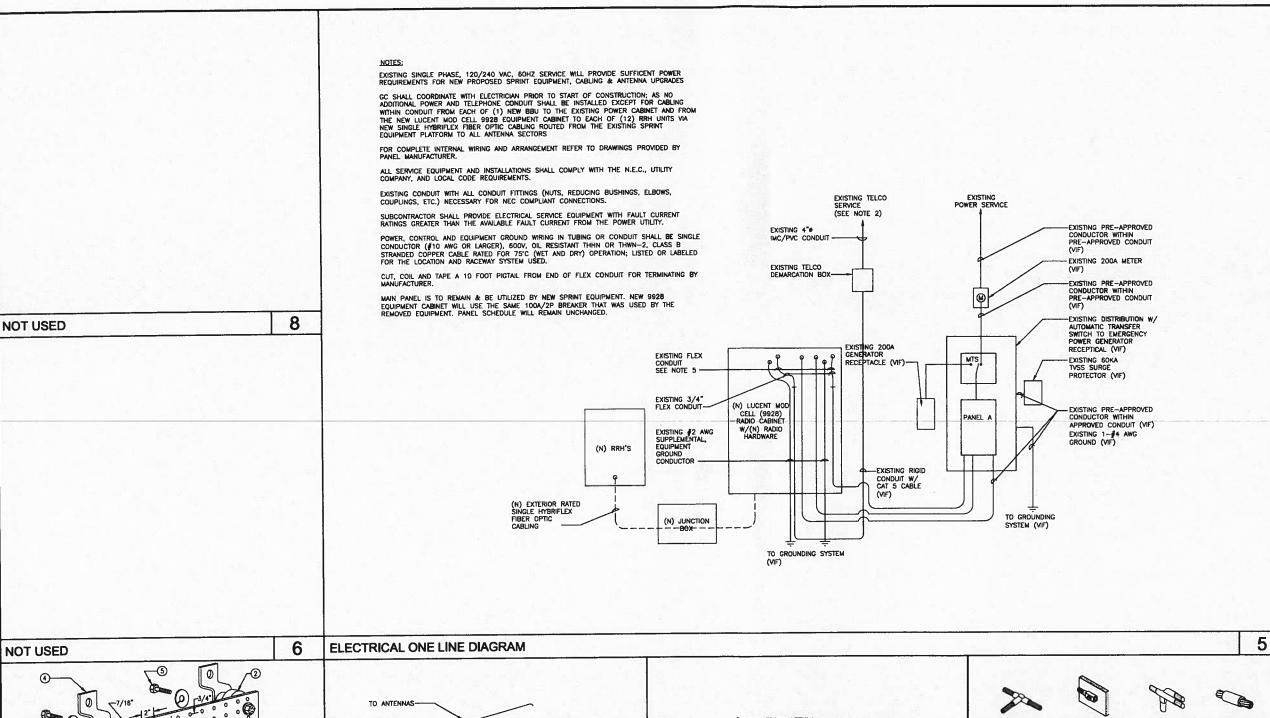







PROJECT INFORMATION:

NETWORK VISION MMBTS LAUNCH

AGOURA HILLS

LA03XC200

28030 DOROTHY DR AGOURA HILLS, CA 91301 AGOURA HILLS

ISSUE DATE:

02/24/2012

ISSUED FOR:

100%CD's

		REVISIONS	
REV.	DATE	DESCRIPTION	INITIALS
A	02/24/12	ISSUED FOR 90% CD REVIEW	DAR
B	03/13/12	ISSUED FOR 90% CD REVIEW	AMF
С	03/28/12	100%CD's	DY
Δ	10/8/12	CITY COMMENTS	DY
Δ	10/16/12	CITY COMMENTS	KW

LICENSURE:




SHEET TITLE:

GROUNDING DETAILS

SHEET NUMBER:

REVISION:

E-2

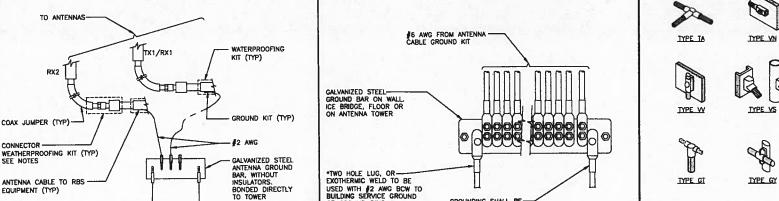

I. WALL MOUNTING BRACKET, NEWTON INSTRUMENT CO., CAT NO. A-6056 OR APPROVED EQUAL

 $5.5/8-11\ \times\ 1"$ HHCS BOLTS, NEWTON INSTRUMENT CO., CAT NO. 3012-1 OR APPROVED EQUAL

CALVANIZED STEEL GROUND BAR, HOLE CENTERS TO MATCH NEMA DOUBLE LUG CONFIGURATION. (ACTUAL GROUND BAR SIZE WILL VARY BASED ON NUMBER OF GROUND

3.5/8" LOCK WASHERS, NEWTON INSTRUMENT CO., CAT. NO. 3015-8 OR APPROVED EQUAL

. INSULATORS SHALL BE ELIMINATED WHEN BONDING DIRECTLY TO TOWER/MONOPOLE STRUCTURE. CONNECTION TO TOWER/MONOPOLE STRUCTURE SHALL BE PER MANUFACTURERS RECOMMENDATIONS.

. INSULATORS, NEWTON INSTRUMENT CAT. NO. 3061-4 OR APPROVED EQUAL

GROUND CABLE CONNECTION

TO GROUND RING

GROUND WIRE INSTALLATION

GROUNDING SHALL BE— ELIMINATED WHEN GROUND BAR IS ELECTRICALLY BONDED TO METAL TOWER

EXOTHERMIC WELD CONNECTIONS

TYPE NC

10

TYPE VB

TYPE GR

TYPE SS

TYPE PI

TYPE GL

GROUND BAR (IF REQUIRED) THE INFORMATION CONTAINED IN THIS SET OF CONSTRUCTION DOCUMENTS IS PROPRIETARY BY NATURE. ANY USE OR DISCLOSURE OTHER THAN THAT WHICH RELATES TO CARRIER SERVICES IS STRICTLY PROHIBITED

TO GROUND RING

VICINITY MAP - PHOTOSIMULATION VIEWPOINTS

AGOURA HILLS LA03XC200 28030 DORTHY DRIVE, AGOURA HILLS, CA 91301



CITY OF AGOURA HILLS

2013 JAN 22 PM 2: 03

5865 AVENIDA ENCINAS CARLSBAD, CA 92008 OFFICE: (760) 795-5200

CITY CLERK

