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**DEPARTMENT OF PLANNING AND COMMUNITY DEVELOPMENT**

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**DATE:** July 16, 2015

**TO:** Planning Commission

**APPLICANTS:** Vineet and Annette Sharma  
29617 Canwood Street  
Agoura Hills, CA 91301

**CASE NOS.:** CUP-01014-2014 and OTP-01015-2014

**LOCATION:** 5952 Lapworth Drive

**REQUEST:** Request for a Conditional Use Permit to construct a 4,712 square foot, two-story, single-family residence with a 692 square foot attached garage, and a swimming pool; a request for an Oak Tree Permit to encroach within the protected zone of one off-site Oak tree for the proposed construction; and making a finding of exemption under the California Environmental Quality Act.

**ENVIRONMENTAL DETERMINATION:** Exempt from the California Environmental Quality Act (CEQA) per Section 15303 of the CEQA Guidelines.

**RECOMMENDATION:** Staff recommends the Planning Commission approve Conditional Use Permit Case No. CUP-01014-2014 and Oak Tree Permit Case No. OTP-01015-2014, subject to conditions, based on the findings of the attached draft Resolution.

**ZONING DESIGNATION:** RV-OA-EQ (Very Low Density Residential-Old Agoura Design-Equestrian Overlay District)

**GENERAL PLAN DESIGNATION:** RV – (Very Low Density Residential)

## I. PROJECT BACKGROUND AND DESCRIPTION

On August 2, 2007, the Planning Commission approved a Conditional Use Permit application to build a 5,376 square foot, two story, single-family residence with a 910 square foot attached garage, a swimming pool and a 1,446 square foot detached garage and barn on a 1.38 acre parcel located on the northeast corner of Balkins Drive Lapworth Drive. An Oak Tree Permit was also approved to allow encroachment within the protected zone of one Oak tree for the proposed construction.

The property has remained vacant and has been sold to Vineet and Annette Sharma, who are requesting approval of a Conditional Use Permit (CUP) to construct a new 4,712 square foot, two-story, single-family residence with a 692 square foot, attached three-car garage and a swimming pool in the Very Low Density Residential-Old Agoura Design-Equestrian Overlay (RV-OA-EQ) zoning districts. The project will encroach within the protected zone of one off-site oak tree for the proposed construction, which requires approval of an Oak Tree Permit.

This hillside lot rises 48 feet in elevation from the average street elevation (96 feet) of Balkins Drive to the average rear or north elevation (144 feet) of the lot, with an average slope of 19.84%. New single-family homes are subject to review by the Planning Commission. Since the parcel has an average topographic slope that exceeds 10% (19.8%), the project is subject to the City Hillside Ordinance standards and, therefore, requires approval of a Conditional Use Permit application.

The proposed single-family residence is a permitted use in the Very Low Density Residential (RV) zone and will meet the required development standards, relative to lot coverage, height and building setbacks. Listed below are the proposed development data pertaining to the project:

### Pertinent Data

	<u>Proposed</u>	<u>Allowed/ Required</u>
1. Lot Size:	1.38 acres (existing) (59,983 sq. ft.)	1 acre min. (43,560 sq. ft.)
2. Building Height:	32 ft.	35 ft. max.
3. Building Sizes:		
First Floor	1,043 sq. ft.	N/A
<u>Second Floor</u>	<u>3,669 sq. ft.</u>	N/A
Total House Area	4,712 sq. ft.	
Attached Garage	692 sq. ft.	N/A
<u>Covered Patio</u>	<u>604 sq. ft.</u>	N/A
Total Attached Structures	1,296 sq. ft.	

4. Bldg. Lot Coverage:		
Residence	3,669 sq. ft.	
Attached Garage	692 sq. ft.	
Covered Patios	302 sq. ft.	
Swimming Pool	748 sq. ft.	
Pool Deck	1,836 sq. ft.	
Driveway/Motorcourt	3,653 sq. ft.	
<u>Hardscape/Walkways</u>	<u>968 sq. ft.</u>	
Total	11,868 sq. ft. (19.8%)	Max. 25% (14,996 sq. ft.)
5. Building Setbacks from Property Lines:		
Front (South)	308 ft.	25 ft. min.
Rear (North)	48 ft.	25 ft. min.
Left Side (West)	22 ft.	12 ft. min.
Right Side (East)	24 ft.	12 ft. min.
6. No. of Oak Trees:		
On-Site	15	N/A
Off-Site	4	N/A
7. Average Topographic Slope:	19.84%	N/A

## II. STAFF ANALYSIS

### Site Plan

The proposed residence and attached garage, which occupies 7.8 percent of the lot, has been proposed to be situated in the lower, flatter portion of the 59,983 square foot parcel, near the northeast end of the lot, thereby protecting on-site Oak trees and reducing the amount of grading of the site, while exceeding the minimum yard setback distances for the RV zone. The lot includes a proposed lower floor elevation of 127 feet, which is 8 feet below Lapworth Drive. The applicants are also proposing a 604 covered loggia at the rear of the residence. The 748 square foot swimming pool is proposed 15 feet from the covered patio at the northeast portion of the property. The front of the house faces southwest. Although the house is oriented toward Lapworth Drive to the west, for zoning standard purposes, Balkins Drive is considered to be the frontage street as the south property line is the narrowest in length of the two street frontages. The 20-foot wide driveway access to the three (3) car garage, located at the front of the house, is provided from Lapworth Drive. Existing hillside single-family homes are present on the adjacent properties located to the west, east and south of the subject property. The adjacent property to the north of the lot is vacant. The Los Angeles County Fire District has tentatively approved their Site Plan for the required access.

The footprint of the proposed residence, attached garage, swimming pool and the hardscape totals 11,868 square feet, or 19.8% of the lot area. The driveway by itself, including a required on-site fire truck turn-around area, would occupy 6.1% of the maximum lot coverage allowed by the Hillside Ordinance. The RV zone allows for a maximum 25% lot

coverage for lots that have an average slope of less than 10%. In addition, the Hillside Ordinance requires that at least 47.5% of the lot remain in undisturbed open space for parcels that have an average slope of 16-20%. Thus, the maximum amount of construction area should not exceed 52.5% of the lot. Currently the project meets this requirement because 80.2% of the parcel would remain undisturbed.

The Old Agoura Residential Design Guidelines recommends a maximum 5,319 square feet of floor area (8.9%) based on the size and topography of the lot. The applicant has proposed a floor area ratio (FAR) of 8.9% or 5,316 square feet. The 5,316 square feet is the same as the maximum recommended. The proposed residence is not the largest in the immediate neighborhood. Across Balkins Drive and to the west is a 5,420 square foot, two-story, single-family residence on a 1.01 acre parcel. Two lots directly to the east is a 5,324 square foot, two-story, single-family residence on a 2.56 acre parcel. On the southeast corner of Balkins Drive and Lapworth Drive is a 5,536 square foot, two-story, single-family residence on a 0.92 acre parcel. The proposed size of the applicant's residence is consistent with the most recently approved homes in the surrounding area.

The project was reviewed for compliance with the Equestrian Overlay District, which requires properties to accommodate for a potential horse keeping area of at least 1,500 square feet in size that could include a 144 square foot covered stall with a corral and a 150 square foot area for hay and tack storage. Furthermore, the location of the equestrian area must be accessible from the street for veterinary care and the delivery of supplies. The proposed site plan shows a horse keeping area in the southern portion of the property, which includes an area approximately 3,000 square feet in size, which would be able to accommodate horse facilities and meet the Old Agoura Design Overlay requirement for equestrian use of the property. The proposed horse keeping area could be assessed from Lapworth Drive, or from the proposed on-site driveway. The applicants not proposing fencing around the property at this time.

### Architectural Design

As the property is also located within the Old Agoura Design Overlay District, which calls for the preservation of the semi-rural character of the community and promotion of the natural environment with the utilization of natural materials and earth-tone colors. The applicant is proposing Mediterranean/Spanish style architecture that includes earth-tone building materials of beige colored stucco exterior walls with a smooth finish, brown trim, a clay tile roof, exposed wood beams and decorative corbels/rafter tails. The residence will have a prominent arched entryway and two chimneys with a natural stone façade. Decorative arches are proposed on each side of the front entrance with the actual walls set back, providing depth/dimension to the structure, while avoiding the appearance of large blank walls. The roof is designed using multi-level roof lines. Proposed garage doors are decorative, wood-finished garage doors that closely resemble barn door. A decorative color stamped concrete driveway and motor court with semi-permeable interlocking pavers is proposed at the entrance (first 10 feet) of the driveway.

The proposed residence is positioned parallel to Lapworth Drive. The most prominent elevation visible from the street (Lapworth Drive) will be the southwest elevation, which

from Lapworth drive appears to be a single story. The overall height of the proposed residence is 32 feet, not exceeding the maximum height of 35 feet allowed for a residence in the RV zone. The City Architectural Review Panel (ARP) found the architectural style of the proposed residence to be in keeping with the Old Agoura Design Overlay requirements and the City Architectural Design Guidelines and Standards. The Old Agoura Homeowners Association has also reviewed the project. A copy of their letter is attached to the report for the Commission's review.

#### Engineering Department

The Engineering Department has reviewed the proposed Grading Plan and will require Lapworth Drive, which is a private street, to be improved along the west property line. The street improvements are to include 20 feet of pavement and an asphalt curb along the entire side of the property on Lapworth Drive. No improvements are required for Balkins Drive.

The subject property is situated on a considerably sloped area and receives no offsite flow from the adjacent road or properties. Currently, all of the runoff generated from the property flows to the south, towards Balkins Drive. In an effort to comply with the City of Agoura Hills recently adopted Low Impact Development (LID) requirements the applicant is proposing a bio-filtration pond system on the southern portion of the lot. The runoff from the property will be conveyed to a bio-filtration pond area. Once the water is cleaned through the pond area, it will outlet onto Balkins Drive where it will then sheet flow down the street. Final street plans and drainage plans will be subject to approval by the City Engineer prior to issuance of a building permit.

Grading required for the proposed project includes 906 cubic yards of cut, 1,117 cubic yards of fill and 212 cubic yards of import to create the building pad elevations, access driveway, and useable yard areas. Proposed grading will require retaining walls to support the driveway and walkway area on the south side of the residence. The retaining wall proposed at the westerly edge of the driveway will begin with a height of three feet at the southerly end and ends at a maximum height of six feet. A three to four foot stem wall is proposed along the easterly edge of the driveway. An additional stem wall is proposed to supporting the walkway on the south side of the residence and will remain under six feet.

An onsite sewer disposal system is proposed on the middle portion of the property to serve the residence. The location, at the south side of the proposed residence, and feasibility of the septic system has been tentatively approved by the Los Angeles County Health Department.

The City's Geotechnical Consultant has reviewed the geotechnical reports prepared for this project and recommends that the project be approved from a geotechnical perspective at the planning stage. Construction traffic and related vehicular routes will also be reviewed by the City Engineer prior to the issuance of a grading permit, with the intent to minimize impacts to the neighbors.

### Oak Trees and Landscaping

Located on the site are 15 protected oak trees. Four off-site oak trees are located on the adjacent property to the north. The current plans indicate that encroachment would be required within the protected zone of one off-site Coast Live Oak tree (*Quercus agrifolia*) located at the northwest boundary of the site in order to construct an asphalt curb along the edge of Lapworth Street. This encroachment would amount to approximately three percent of the oak tree's protected zone and the work, if performed carefully using hand tools, as conditioned, would allow for preservation of the tree.

Since the topographic slope of the property exceeds 10%, the applicant is required to prepare a landscape plan for the City's review. The preliminary landscape plan was reviewed by the City Landscape Consultant, who recommends that the applicant submit final, detailed landscape and irrigation plans for review by the City Landscape Consultant and the Planning Director prior to building permit issuance, and subject to attached conditions. The final plans will be reviewed for slope stabilization and the incorporation of native plant species.

### Environmental Review

Upon review of this project by the City Environmental Analyst, no environmental impacts have been identified for construction of the project. The project has been determined to be Categorically Exempt from the California Environmental Quality Act per Section 15303. This exemption includes, but is not limited to, the construction of a single-family residence.

### **III. RECOMMENDATIONS**

Based on the foregoing analysis, staff recommends that the Planning Commission adopt a motion to approve Conditional Use Permit Case No. CUP-01014-2014 and Oak Tree Permit Case No. OTP-01015-2014, subject to Conditions, based on the findings of the attached Draft Resolution.

### **IV. ATTACHMENTS**

- Conditional Use Permit Draft Resolution and Conditions
- Letter from Old Agoura Homeowners Association
- Colored Elevations of the Residence and Colors and Material Board
- Vicinity Map
- Reduced copies of project plans
- Photographs of applicants' lot and surrounding parcels

Case Planner: Renee Madrigal, Associate Planner

DRAFT RESOLUTION NO. \_\_\_\_\_

A RESOLUTION OF THE PLANNING COMMISSION OF THE CITY OF AGOURA HILLS APPROVING CONDITIONAL USE PERMIT CASE NO. CUP-01014-2014 FOR THE CONSTRUCTION OF A SINGLE-FAMILY RESIDENCE AT 5952 LAPWORTH DRIVE; A OAK TREE PERMIT CASE NO. OAK-01015-2014 TO ENCROACH WITHIN THE PROTECTED ZONE OF ONE OFF-SITE OAK TREE FOR THE PROPOSED CONSTRUCTION; AND MAKING A FINDING OF EXEMPTION UNDER THE CALIFORNIA ENVIRONMENTAL QUALITY ACT.

THE PLANNING COMMISSION OF THE CITY OF AGOURA HILLS HEREBY FINDS, RESOLVES, AND ORDERS AS FOLLOWS:

Section 1. An application was duly filed by Vineet and Annette Sharma with respect to the real property located at 5952 Lapworth Drive (Assessor's Parcel Number 2055-022-091), requesting the approval of a Conditional Use Permit (Case No. CUP-01014-2014) to construct a 4,712 square-foot, two-story, single-family residence with a 692 square foot attached three-car garage and a swimming pool, and an Oak Tree Permit (Case No. OAK-01015-2014) to encroach within the protected zone of one off-site Oak tree for the proposed construction. A public hearing was duly held on July 16, 2015, at 6:30 p.m. in the Council Chambers of City Hall, 30001 Ladyface Court, Agoura Hills, California; and that notice of time, date and place and purpose of the aforesaid was duly given and published as required by state law.

Section 2. Evidence, both written and oral, including the staff report and supporting documentation, was duly presented to and considered by the Planning Commission of the aforesaid public hearing.

Section 3. Based on the evidence presented at the public hearing, including the staff report and oral and written testimony, the Planning Commission finds, pursuant to the Agoura Hills Municipal Code Section 9673.2.E, that:

A. The proposed use, as conditioned, is consistent with the objectives of the Zoning Ordinance and the purposes of the district in which the use is located. The proposed project is located within the Very Low Density Residential–Old Agoura Design-Equestrian Overlay (RV-OA-EQ) zoning districts, which allows for the development of single-family residences. The City's minimum development standards have been met for the proposed two-story residence with regard to lot coverage, building height, and building setbacks from the property lines.

B. The proposed use, as conditioned, is compatible with the surrounding properties. The proposed building design and building materials of the residence that include beige colored stucco with brown trim, stone, and a clay tile roof, exposed wood beam, corbels/rafter tails and wrought iron railing, are compatible with the neighboring

structures and the topography of the property. The residence is located in the flatter portion of a sloped lot to minimize grading and to reduce visual impacts as viewed from Lapworth Road. The project was reviewed by the City's Architectural Review Panel and was found to be in compliance with the City's Architectural Design Guidelines and standards of the Old Agoura Design Overlay District.

C. The proposed use, as conditioned, and the conditions under which the project will be operated or maintained will not be detrimental to the public health, safety or welfare, in that the proposed use will ensure adequate light, air and privacy, and open space to surrounding properties. The proposed two-story structure is situated in the flatter portion of the on-site hillside slope, which will preserve the views and privacy of the surrounding properties. The project complies with the maximum allowable building height limitations of hillside properties. Geological, geotechnical, and drainage studies, as well as landscape plans, have been provided and approved by the City's Consultants. Vehicular access to the property will be provided via Lapworth Drive. The applicant will be required to construct the project in full compliance with the City's Building Code. A private septic system will serve the 1.38 acre parcel and has been tentatively approved by the Los Angeles County Health Department.

D. The proposed use, as conditioned, will comply with each of the applicable provisions of the Zoning Ordinance. The project meets the development standards of the underlying zone relative to the required lot coverage, building height, and building setbacks. The incorporation of permeable or semi-permeable driveway and hardscape materials and bio-filtration area will reduce runoff.

E. The distance from other similar and like uses is sufficient to maintain the diversity of the community in that the project will meet the minimum yard setback requirements for the RV zone. The residence will be placed an appropriate distance from Lapworth Drive, to preserve public views. The distance to the closest home is approximately 45 feet.

F. The proposed use, as conditioned, is consistent with the City's General Plan. The proposed residence is located and designed to incorporate the existing terrain into the site plan to the maximum extent possible to minimize grading and to preserve view sheds, as called for in Policy Section LU-8.3 of the General Plan. The difference in elevation from the street is approximately 12 feet.

Section 4. The Planning Commission finds, pursuant to Section 9652.15.A of the Agoura Hills Municipal Code, which establishes special regulations for hillside development areas, that:

A. The proposed project is located and designed so as to protect the safety of current and future community residents, and will not create significant threats to life and/or property due to the presence of geologic, seismic, slope instability, fire, flood mud flow, erosion hazards or other hazards. A geotechnical report has been approved by the City Geological Consultant, which is recommended for approval at a planning feasibility



stage. Final geotechnical reports are required for review by the City prior to grading permit issuance.

B. The proposed project is compatible with the natural, biotic, cultural, scenic and open space resources of the area. The project does not protrude above protected ridgelines and will not significantly block neighbors' views.

C. The proposed project can be provided with essential public services and is consistent with the objectives and policies of the general plan. All utility services will be brought to the parcel without interference to the existing infrastructure.

D. The proposed development will complement the community character and benefit current and future community residents. The proposed house and lot size are consistent with the average neighboring homes.

Section 5. The project is a request for one single-family residence and is exempt from the California Environmental Quality Act (CEQA), per CEQA Guidelines Section 15303 (New Construction or Conversion of Small Structures) and is not subject to a negative declaration or environmental impact report.

Section 6. Based on the aforementioned findings, the Planning Commission hereby approves Conditional Use Permit Case No. CUP-01014-2014 and Oak Tree Permit Case No. OAK-01015-2014, subject to the attached Conditions, with respect to the property described in Section 1 hereof.

PASSED, APPROVED and ADOPTED this 16th day of July 2015, by the following vote to wit:

AYES: (0)  
NOES: (0)  
ABSENT: (0)  
ABSTAIN: (0)

\_\_\_\_\_  
Linda Northrup, Chairperson

ATTEST:

\_\_\_\_\_  
Doug Hooper, Secretary

CONDITIONS OF APPROVAL  
(Case Nos. CUP-01014-2014 and OAK-01015-2014)

STANDARD CONDITIONS

1. This decision, or any aspect of this decision, can be appealed to the City Council within fifteen (15) days from the date of Planning Commission action, subject to filing the appropriate forms and related fees.
2. The approval of this permit shall not be effective for any purpose until the applicants have agreed in writing that they are aware of, and accepts, all Conditions of this Permit with the Department of Planning and Community Development.
3. Except as modified herein, the approval of this action is limited to and requires complete conformation to the labeled exhibits: Site Plan, Building Elevation Plans, Floor Plan, Roof Plan, Grading Plans, and Landscape Plan.
4. All exterior materials used in this project shall be in conformance with the materials samples submitted as a part of this application.
5. It is hereby declared to be the intent that if any provision of this Permit is held or declared invalid, the Permit shall be void and the privileges granted hereunder shall lapse.
6. It is further declared and made a Condition of this action that if any Condition herein is violated, the Permit shall be suspended and the privileges granted hereunder shall lapse; provided that the applicant has been given written notice to cease such violation and has failed to do so for a period of thirty (30) days.
7. All requirements of the Zoning Ordinance and of the specific zoning designation of the subject property must be complied with unless set forth in this permit or on the approved Site Plan.
8. No occupancy shall be granted for any new building until all Conditions of Approval have been complied with as determined by the Director of Planning.
9. A minimum of two (2) enclosed parking spaces shall be provided on the subject property, in conformance with the City Parking Ordinance. A minimum interior clear space of 20 feet by 20 feet must be maintained within the garage.
10. All structures shall conform to the requirements of the Division of Building and Safety of the City of Agoura Hills.
11. The applicant shall comply with the requirements of the Los Angeles County Fire Department prior to the issuance of Building or Grading Permits. The Forester and Fire Warden shall be consulted to ascertain the required fire flows and fire hydrants to accommodate the proposed development.

12. Unless this permit is used within two (2) years from the date of City approval, Conditional Use Permit Case No. CUP-01014-2014 and Oak Tree Permit Case No. OAK-01015-2014 will expire. A written request for a one (1) year extension may be considered prior to the expiration date.
13. The applicant shall pay to the City the applicable General Plan Update Recovery Fee prior to the issuance of a Building Permit. The current fee is \$1.41/\$1,000 of building valuation. Actual fees will be determined at the time of building permit issuance.
14. The applicant shall comply with the school impact fee requirements of the Las Virgenes Unified School District. The current fee is \$3.36 per square foot for residential construction.
15. No roof-mounted equipment, other than attic ventilation systems and solar panels, as allowed by the Municipal Code, shall be permitted.
16. Prior to the issuance of a Building Permit, the applicant shall submit a letter to the Director of Planning agreeing to suspend construction in the vicinity of a cultural resource encountered during development of the site, and leave the resource in place until a qualified archaeologist can examine them and determine appropriate mitigation measures. All fees and expenses for the retaining of a qualified archaeologist shall be paid by the applicant and shall not be at City expense. The applicant shall agree to comply with mitigation measures recommended by the archaeologist and approved by the Director of Planning.
17. All outstanding fees owed to the City, if any, shall be paid by the applicant within thirty (30) days from the date of this approval.
18. It is the responsibility of the applicant and/or his or her representatives to report to the City any changes related to any aspects of the construction prior to undertaking the changes.

#### BUILDING AND SAFETY DEPARTMENT CONDITIONS

19. All exterior materials used for eaves, sidings, porch, patio, decks, carport and other similar structures shall meet the Very High Fire Hazard Severity Zone (VHFHSZ) as outlined in Chapter 2 of Article VIII in the Agoura Hills Municipal Code (AHMC).
20. A Soils Report is required to be submitted for this project.
21. The applicant shall note on the plans that all new or replaced windows will be tempered on at least one side of the dual pane, or a 20 min rated window or glass blocks per Section 704A.3.2.2 of the 2010 California Building Code.
22. This project is subject to the 2013 California Building, Mechanical, Plumbing, Electrical, and Energy Codes.

23. As part of the permitting process and prior to building permit issuance, two (2) complete sets of construction plans, including Structural, Floor Plan, Plumbing, Energy Plans, plans shall be submitted to the Building and Safety Department for plan review and approval.
24. Per AQMD Rule 445 only fireplaces fueled by gas (such as gas logs) may be installed in a new residence. Permanently installed indoor or outdoor wood-burning fireplaces or stoves are not permitted.
25. Fire Sprinklers will be required for this project per Section 903.2, Article VIII of the Agoura Hills Municipal Code (AHMC)
26. The size and depth of the septic tank shall be indicated to verify that the elevation and the size can work with the proposed structure. Los Angeles County Health Department approval is required for installation of any septic tanks, leach fields or seepage pits.
27. Handrails shall be required for exterior stairs with four (4) or more risers (2013 California Residential Code Section 311.7.8).
28. Hillside setbacks shall be met per AHMC 1805.3.2.
29. Built in BBQ's shall be 3 feet away from any combustible materials unless the material above is non-combustible or fire rated.
30. Los Angeles County Fire Department review and approval will be required for all new structures.
31. Pool fencing shall be provided. If utilizing the parameter fencing for this purpose, the fence must meet the pool fencing requirement for the height, type, latch and swing of door, etc.

#### ENGINEERING/PUBLIC WORKS DEPARTMENT CONDITIONS

32. Prior to permitting, all required plans and studies shall be prepared by a Registered Professional Engineer in the State of California, and submitted to the City Engineer for review and approval.
33. For all work within the public right-of-way, the applicant shall obtain an Encroachment Permit. Prior to issuance of this permit, all public improvement plans, which include but are not limited to, street, water, sewer, storm drain, lighting, signing and striping, etc shall be reviewed and approved by the City Engineer. Water plans shall be designed to meet LVMWD standards and contain a signature block for the City Engineer. All associated fees and securities shall be based upon completed Engineering Cost Estimate forms, approved by the Engineering Department. Forms are available for download from the City's website at [www.ci.agoura-hills.ca.us](http://www.ci.agoura-hills.ca.us).

34. Applicants shall pay a Transportation Impact Fee (TIF) in the amount of \$3,094 to the Building and Safety Department prior issuance of grading permit.
35. All existing street and property monuments within or abutting this project site shall be preserved consistent with AB1414. If during construction of onsite or offsite improvements monuments are damaged or destroyed, the applicant shall retain a licensed land surveyor or civil engineer to reset those monuments per City's Standards and file the necessary information with the County Recorder's office.
36. Detailed on-site utility information shall be shown on the grading plan, which includes, but is not limited to, backflow prevention devices, exact location of laterals water meter size and location, invert elevations and grades for all gravity lines. The grading plan will not be approved by the Engineering Department until this detailed utility information is included on the plans.
37. The Grading Plan shall show locations of all Oak trees, if any, within the vicinity of the site. Applicants shall adhere to all requirements pertaining to Oak trees as outlined in the City's Oak tree Consultant's conditions of approval, if any.
38. Prior to permitting, the applicants shall submit electronic files (i.e., CAD file, on disc) of project-related off-site improvement plans as deemed necessary by the City Engineer. These electronic files shall accompany original Mylars of improvement plans to be approved/signed by the City Engineer. Improvement plans will not be approved by the City Engineer if not accompanied by CAD files.
39. Prior to permitting, the applicant shall submit a soils/geology report to the project engineer for review and approval in accordance with Government Code, Section 66434.5 as required by the City Engineer.
40. Building Permits shall not be issued until graded building pad(s) have been certified for compaction and elevation to the City's satisfaction. The applicant shall contact the City Engineering Department at (818) 597-7322 for approved City certification forms.
41. Building Permits shall not be issued until the applicant has obtained septic system approval from Los Angeles County Health Department.
42. Prior to permitting, all public improvements shall be designed in accordance with City Code, Specifications, approved Specific Plan, and/or approved Conditions of Approval for the area. The project is required to install an asphalt concrete berm and widen the asphalt concrete pavement on Lapworth Drive to provide a 20 foot minimum paved surface along the entire west property line, install a new driveway approach with concrete pavers, and all water appurtenances per LVMWD standards.
43. The following existing street being cut for new services or being finish with curb and gutter may require an asphalt concrete overlay: Lapworth Drive along the entire westerly property line.

44. This property is within the Las Virgenes Municipal Water District (LVMWD) service area. The applicant shall make arrangements with LVMWD for those services and provide the City with proof that all LVMWD fees have been paid.
45. All water facilities shall be designed to comply with all LVMWD requirements. Final plans must be reviewed and approved by LVMWD and City.
46. A hydrology study and drainage analysis, prepared and signed by a Civil Engineer registered in the State of California, in accordance with the Los Angeles County Hydrology Manual, is required. Additional drainage facilities or portions of the site/grading plan may need to be altered as a result of the findings of this study.
47. The project shall be subject to the Low Impact Development (LID) requirements of Chapter 5 of Article V of the Agoura Hills Municipal Code.
48. Prior to the approval of the Grading Plan and issuance of Grading Permits, an Erosion and Sediment Control Plan (ESCP) shall be submitted to and approved by the Engineering Department. The Erosion and Sediment Control Plan shall specifically identify the Best Management Practices (BMPs) that will be implemented on this project, during construction, to reduce the discharge of sediment and other pollutants into the City's storm drain system. Said plan shall ensure, among other things, that the following minimum requirements are effectively implemented at all construction sites:
  - a. Sediments generated on the project site shall be retained using adequate Treatment Control or Structural BMPs;
  - b. Construction-related materials, wastes, spills, or residues shall be retained at the project site to avoid discharge to the streets, drainage facilities, receiving waters, or adjacent properties by wind or runoff;
  - c. Non-storm water runoff from equipment and vehicle washing and any other activity shall be contained at the project site;
  - d. Erosion from slopes and channels shall be controlled by implementing an effective combination of BMPs such as the limiting of grading scheduled during the wet season; inspecting graded areas during rain events; planting and maintenance of vegetation on slopes and covering erosion susceptible slopes.
49. Prior to the approval of the Grading Plan and issuance of Grading Permits, a completed Standard Urban Storm water Mitigation Plan (SUSMP) shall be submitted to and approved by the Engineering Department. The SUSMP shall be prepared per the Los Angeles County Standard Urban Storm water Mitigation Plan (SUSMP) design guidelines. SUSMP shall identify, among other things, all Post-Construction, Site Design, Source Control and Treatment Control Best Management Practices (BMPs) that will be incorporated into the development project in order to minimize the adverse effects on receiving waters.
50. All remaining fees/ deposits required by the Engineering Department must be paid in full prior to issuance of grading permit.

51. All requirements including construction of improvements covered in condition number 43 must be completed to the satisfaction of the City Engineer.
52. The applicants' Engineer shall submit a set of MYLAR, Record (as-built) Drawings, for off-site improvements, to accurately reflect the constructed improvements. This set of Record Drawings reflecting all change orders during construction, must be submitted to the City via City's inspection prior to scheduling of final inspection for acceptance of the improvements. No final inspection will be scheduled and subsequently no release of securities, posted for the project if any, will take place unless MYLAR, Record (as-built) Drawings, satisfactory to the City, are submitted.
53. The applicants shall record a covenant for continued storm water maintenance, using City-approved forms, with the Los Angeles County. An electronic copy of this document is available on the City's website: [www.agoura-hills.ca.us](http://www.agoura-hills.ca.us).
54. All monuments shall be set in accordance with the final map, and all centerline ties shall be submitted to the Engineering Department. Any monuments damaged as a result of construction, shall be reset to the City's satisfaction.
55. Upon receiving the Title Report, if conflicts/issues arise regarding recorded documents over property, applicant shall take all measures necessary, as directed by the City Engineer, to resolve said conflicts/issues. All conditions are to be complied with to the satisfaction of the City Engineer in accordance with the applicable provisions of the Agoura Hills Municipal Code.

#### GEOTECHNICAL CONDITIONS

56. The applicants shall comply with all the City Geotechnical Consultant's (GeoDynamics, Inc.) Conditions of Approval letter dated April 9, 2015.

#### OAK TREE CONDITIONS

57. The applicant is permitted to encroach within the protected zone of Oak Tree Number OS-4 to construct the asphalt berm in accordance with the approved plans.
58. All excavation within the protected zone of Oak Tree Number OS -4 shall be performed using only hand tools under the direct observation of the applicant's oak tree consultant. Light construction equipment may be utilized with prior approval of the City Oak Tree Consultant.
59. The final design of all retaining walls shall utilize a foundation, construction and drainage detail that does not require encroachment into the protected zone of any oak tree in order to construct the project.
60. Prior to the start of any work or mobilization on the site, each oak tree shall be fenced at the edge of the protected zone in accordance with Article IX, Appendix A, Section V.C.1.1.

The City Oak Tree Consultant shall approve the fencing locations and installation prior to the start of work on the site.

61. No grading, scarifying or other soil disturbance shall be permitted within any portion of the protected zone of any oak tree.
62. No vehicles, equipment, materials, spoil or other items shall be used or placed within the protected zone of any oak tree at any time.
63. Prior to occupancy, each oak tree shall be mulched throughout the dripline with three inches of approved organic mulch.
64. No irrigation or planting shall be installed within the dripline of any oak tree unless specifically approved by the City Oak Tree Consultant and the Planning Director.
65. Within ten calendar days of the completion of work and prior to removal of the protective fencing, the applicant shall contact the City Oak Tree Consultant to perform a final inspection. The applicant shall proceed with any remedial measures the City Oak Tree Consultant deems necessary to protect or preserve the health of the subject oak trees at that time.
66. No pruning of live wood shall be permitted unless specifically authorized by the City Oak Tree Consultant. Any authorized pruning shall be performed by a qualified tree trimmer under the direct observation of an ISA-certified arborist. Pruning operations shall be consistent with ANSI A300 Standards – Part 1 Pruning and the most recent edition of the International Society of Arboriculture Best Management Practices for Tree Pruning.
67. No herbicides shall be used within 100 feet of the dripline of any oak tree unless the program is first reviewed and endorsed by the City Oak Tree Consultant.
68. The applicant shall also comply with all recommendations contained in the Oak Tree Report prepared by James Dean, ASLA, as revised April 22, 2015.
69. The project oak tree consultant shall submit certification letters for all work completed within the protected zone of any oak tree within ten working days of the completion of said work. The letters shall describe all work performed, methods utilized, monitoring performed and shall state whether such work was completed in accordance with the above conditions of approval.

#### LANDSCAPING CONDITIONS

70. The landscape plans shall substantially conform to the Landscape Concept Plan prepared by Olwyn Kingery Landscape Design as approved by the City of Agoura Hills Planning Commission.



71. Any tree of heaven (*Ailanthus altissima*) is to be permanently eradicated. The landscape plans must contain a note to this effect and specify the method of eradication.
72. One copy of each of the following approved plans shall be submitted with the initial landscape plan check:
  - Site Plan
  - Elevations
  - Grading Plan
  - Conditions Of Approval
73. Prior to the approval of grading permits, the applicant shall submit three (3) sets of landscape plans meeting the following requirements, for review by the City Landscape Consultant and approval by the Planning Director.
  - a. A California-licensed landscape architect shall prepare, stamp and sign the plans.
  - b. All plans shall be legible and clearly drawn.
  - c. Plans shall not exceed 30 inches by 42 inches in size. Plans shall be a minimum of 22 inches by 36 inches in size.
  - d. A true north arrow and plan scale shall be noted. The scale shall be no smaller than one inch equals 20 feet, unless approved by the City Landscape Consultant.
  - e. A title block shall be provided, indicating the names, addresses and telephone numbers of the applicant and landscape architect.
  - f. The project identification number shall be shown on each sheet.
  - g. The plans shall accurately and clearly depict the following existing and proposed features:
    - Landscape trees, shrubs, ground cover and any other landscaping materials
    - Property lines
    - Streets, street names, rights-of-way, easements, driveways, walkways, bicycle paths, and any other paved areas
    - Buildings and structures
    - Parking areas, including lighting, striping and wheel stops
    - General contour lines

- Grading areas, including tops and toes of slopes
  - Utilities, including street lighting and fire hydrants
  - Natural features, including watercourses, rock outcroppings
74. The Planting Plan shall indicate the botanical name and size of each plant.
75. Plant symbols shall depict the size of the plants at maturity.
76. Plant container sizes and/or spacing shall be provided. Minimum sizes shall be acceptable to the City Landscape Consultant and the Planning Director.
77. The landscape plans shall prominently display the following notes:
- a. All plant material shall conform to the most recent edition of ANSI Z60.1 - American Standard for Nursery Stock.
  - b. All trees shall also conform to the California Department of Forestry and Fire Protection "Standards for Purchasing Container-Grown Landscape Trees".
  - c. Prior to scheduling an inspection of the landscape installation with the City, the applicant's landscape architect shall certify in writing that the installation is in conformance with the approved landscape plans.
78. The Irrigation Plan shall be provided separate from but utilizing the same format as the Planting Plan.
79. The irrigation design shall provide adequate coverage and sufficient water for the continued healthy growth of all proposed plantings with a minimum of waste and over spray on adjoining areas.
80. The Irrigation Plan shall be concise and accurate and shall include the manufacturer, model, size, demand, radius, and location of the following, as appropriate:
- a. Design and static pressures
  - b. Point of connection
  - c. Backflow protection
  - d. Valves, piping, controllers, heads, quick couplers
  - e. Gallon requirements for each valve
81. Three copies of details and specifications shall be provided, addressing but not limited to, planting, soil preparation, tree staking, guying, installation details, and post installation maintenance.

82. Native, drought resistant plants shall be utilized on any slopes in accordance with the Old Agoura Design Overlay District requirements.
83. All landscaping shall be irrigated and maintained in perpetuity in accordance with the approved Landscape Plan.
84. Proposed plant material may not be considered invasive in the Santa Monica Mountains, as it could negatively impact the adjacent natural area. Lists of exotic material can be obtained from the California Native Plant Society and/or the California Exotic Pest Plant Council.
85. All plant material shall be considered compatible with Sunset Zone 18.
86. The final plans shall not include any palm species.
87. The Landscape Plan shall be approved by the Fuel Modification Unit at the County of Los Angeles Fire Department prior to the issuance of building permits.
88. A complete Landscape Documentation package shall be provided at the time of initial plan check submittal, prepared in accordance with Article IX, Section 9658.6 – Water Efficient Landscaping, contained in the Zoning Code.

#### FIRE DEPARTMENT CONDITIONS

89. The applicant shall comply with all conditions of the Los Angeles County Fire District prior to the issuance of a building permit.

#### SOLID WASTE MANAGEMENT STANDARD CONDITIONS

90. To ensure that solid waste generated by the project is diverted from the landfill and reduced, reused, or recycled, the applicant shall submit a “Waste Reduction & Recycling Plan” to the City for review and approval. The plan shall provide for at least 50% of the waste generated on the project to be diverted from the landfill. Plans shall include the entire project area, even if tenants are pursuing or will pursue independent programs. The plan shall be submitted to and approved by the Department of Planning and Community Development prior to issuance of a building permit. The plan shall include the following information: material type to be recycled, reused, salvaged, or disposed; estimated quantities to be processed, management method used, and destination of material including the hauler name and facility location. The City’s Waste Reduction & Recycling Plan form or a similar format shall be used.
91. The project shall comply with the plan and provide for the collection, recycling, and/or reuse of materials (i.e. concrete, wood, metal, cardboard, green waste, etc.) and document results during demolition and/or construction of the proposed project. After completion of demolition and/or construction, the applicant shall complete a Waste Reduction & Recycling Summary Report and provide legible copies of weight tickets, receipts, invoices or letters of verification for materials sent to disposal or reuse/recycling facilities. For other discarded or salvaged materials, the applicant shall provide documentation, on the disposal facility’s letterhead, identifying where the materials were taken, type of materials, and tons or cubic

yards disposed, recycled or reused and the project generating the discarded materials. The Waste Reduction & Recycling Summary Report shall be submitted and approved prior to issuance of a certificate of occupancy, or final inspection if issuance of a certificate of occupancy is not applicable.

92. The applicant shall arrange for materials collection during construction, demolition, and occupancy with a City permitted hauling company, or shall arrange for self-hauling to an authorized facility.

#### SPECIAL CONDITIONS

93. A pre-construction conference shall be held prior to the issuance of a grading permit, with all construction personnel involved with the grading operations.

END



## **Old Agoura Home Owners Association Planning and Zoning Committee**

October 15, 2014

Attn: City of Agoura Hills Planning Dept.

Re: 5952 Lapworth Drive

The Planning and zoning committee, from the Old Agoura Home Owners Association has visited the subject site, and reviewed the plans dated 08/19/2014 by Ignacio Roderiguez Design Consultants.

The proposed project consist of a new house, which stated, will be under the maximum square footage, and lot coverage allowed. The house, has been located to minimize grading, and tall retaining walls. The maximum height appears to comply with the Old Agoura Design requirements.

The plans show, a proposed pool being located at the north most part of the property. Also shown, is a future horse keeping facility at the south most part of the property. This future horse facility location, is fairly flat and will provide good vehicle access for feed and other horse activities.

The Project has nice design elements, and articulation. The rafter beams and railings, along with the Spanish style architecture, work well with the neighborhood. Overall, the proposed residence is consistent, with the Old Agoura design overlay.

We recommend approval of the project, and would like to see the following:

- 1- Smooth or steel trowel texture stucco.
- 2- Warm earth tone colors with accent colors on the wood work and railings.
- 3- Colored, stamped concrete to soften the impact of the large motor court, needed to comply with the fire department.
- 4- Opportunity to review proposed fencing and gates they are planning on using in the front of the property.

Thank you for the opportunity to comment on this project. Please feel free to call if the Planning commission or the applicant has any questions. We can be reached at 818-599-6842.

Thank you.  
DANIEL FARKASH

Phil Ramuno  
Daniel Farkash  
Mike Colabella











**Roof - Rafters & Exposed Beams**

Saddle Brown transparent



**Roof - US Tile**

1-Piece 'S' Clay Tile  
Tusino Blend



**Sharma Residence**  
5952 Lapworth Dr. Agoura Hills CA 91301



**Arches and Chimney Stone**

Santa Barbara Sandstone Mix



**Stucco**

La Habra Standard - 'Egg Shell' 73 (76) Base 100  
Smooth 'Santa Barbara Mission' Finish



**Wood Stain for Garage Doors**

'dark brown transparent'



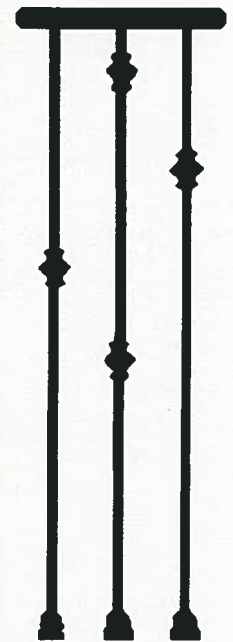
**Driveway & Backyard Pavers**

Angules - Antique Cobble (TUSCAN)



**Motorcourt & Driveway**

Baige Color 'saw-cut' concrete with decorative 'bands'  
of matching 'Angelus Antique Cobble' Pavers



**Backyard Staircase**

Wrought Iron Railing with tuscan  
style decorative beading

the 1990s, the number of people with a mental health problem has increased in the UK (Mental Health Act 1983, 1990).

There is a growing awareness of the need to improve the lives of people with mental health problems. The Department of Health (1999) has set out a vision of a new mental health system, which will be based on the following principles:

- People with mental health problems should be treated as individuals, with their own needs and wishes.
- People with mental health problems should be given the opportunity to participate in decisions about their care.
- People with mental health problems should be given the opportunity to live in their own homes and communities.

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Conditional Use Permit Case No. CUP-01014-2014 and  
Oak Tree Permit Case No. OAK-01015-2014 (Applicant: Sharma)





# NEW 2-STORY RESIDENCE

## 5952 LAPWORTH DRIVE AGOURA HILLS, CA 91301

**SCOPE OF WORK:**  
NEW 2-STORY RESIDENCE WITH 3 CAR PARKING, 1 RETAINING WALL AND A NEW POOL.

ABBREVIATIONS		GENERAL NOTES	
ABBREVIATION	DESCRIPTION	ABBREVIATION	DESCRIPTION
A.F.F.	ABOVE FIN. FLOOR	MAX.	MAXIMUM
ALUM.	ALUMINUM	MECH.	MECHANICAL
M.	METAL	MET.	METAL
BATH	BATHROOM	MFR.	MANUFACTURER
BLDG	BUILDING	MFR.	MINIMUM
BLK'G	BLOCKING	MISC.	MISCELLANEOUS
BOT.	BOTTOM	MTD.	MOUNTED
B.R.	BEDROOM	MUL.	MULLION
CAB.	CABINET	NO.	NUMBER
C.G.	CEILING	N.C.	NOT IN CONTRACT
C.	CENTERLINE	N.T.S.	NOT TO SCALE
CLR.	CLEAR	O/	OVER
COL.	COLUMN	O.C.	ON CENTER
CONC.	CONCRETE	PLUMB.	PLUMBING
CONT.	CONTINUOUS	PLY.	PLYWOOD
DET.	DETAIL	PTH.	PARTITION
DIA.	DIAMETER	RAD.	RADIUS
DIAG.	DIAGONAL	REF.	REFERENCE
DN.	DIMENSION	REFRG.	REFRIGERATOR
DN.	DOWN	REQD.	REQUIRED
DRG.	DRAWING	RM.	ROOM
EA.	EACH	R.O.	ROUGH OPENING
ELECT.	ELECTRICAL	SCHED.	SCHEDULE
ELEV.	ELEVATION	SECT.	SECTION
EQ.	EQUAL	S.F.	SQUARE FEET
EXT.	EXTERIOR	SH.	SHEET
EXST.	EXISTING	SM.	SIMILAR
F.D.	FLOOR DRAIN	SPEC.	SPECIFICATION
FIN.	FINISH	STL.	STEEL
FLT.	FLUTE	STOR.	STORAGE
FLUOR.	FLUORESCENT	STRUC.	STRUCTURAL
F.O.C.	FACE OF COLUMN	SUSP.	SUSPENDED
F.O.S.	FACE OF STUD	SYMM.	SYMMETRICAL
F.O.W.	FACE OF WALL	TEL.	TELEPHONE
GA.	GAUGE	TEMP.	TEMPERED
GL.	GLASS	THK.	THICKNESS
GYP.	GYPSON BOARD	T.O.W.	TOP OF WALL
H.C.	HOLLOW CORE	T.O.P.	TOP OF PLATE
HDR.	HARDWARE	TYP.	TYPICAL
HOR.	HORIZONTAL	U.L.	UNDERWRITERS LABORATORY
HR.	HOUR	UN.O.	UNLESS NOTED OTHERWISE
HT.	HEADHT		
H.V.A.C.	HEATING VENTILATION AIR CONDITIONING		
INSUL.	INSULATION	VERT.	VERTICAL
J-BOX	JUNCTION BOX	V.I.F.	VERIFY IN FIELD
LAM.	LAMINATE	W/	WITH
LAV.	LAVATORY	W/O	WITHOUT
LT.	LIGHT	W/C	WATER CLOSET
MAINT.	MAINTENANCE	W.H.	WATER HEATER
MAT.	MATERIAL	W.P.	WATER PROOF
		W.R.	WATER RESISTANT

- CONTRACTOR SHALL BE RESPONSIBLE FOR PROVIDING ALL LABOR AND MATERIALS IN ACCORDANCE WITH ALL APPLICABLE CODES, ORDINANCES AND REQUIREMENTS.
- CONTRACTOR SHALL VERIFY ALL FIELD DIMENSIONS AND CONDITIONS PRIOR TO PROCEEDING WITH WORK.
- DO NOT SCALE DRAWINGS. NOTED DIMENSIONS TAKE PRECEDENCE OVER SCALED DIMENSIONS. DIMENSIONS ARE SHOWN FROM FACE OF STUD OF EXISTING WALL UNLESS OTHERWISE NOTED.
- ALL SYMBOLS AND ABBREVIATIONS USED ON THE DRAWINGS ARE CONSIDERED TO BE CONSTRUCTION STANDARDS.
- CONTRACTOR SHALL BE RESPONSIBLE FOR VERIFICATION AND COORDINATION WITH OTHER TRADES OR SUBCONTRACTORS AND THEIR WORK TO ENSURE COMPLIANCE WITH THE DRAWINGS AND SPECIFICATIONS.
- CONTRACTOR SHALL PROVIDE ALL NECESSARY SAFETY DEVICES, TEMPORARY BARRICADES, SCAFFOLDING, LIGHTING, COVERINGS, FIRE PREVENTION AND OTHER EQUIPMENT TO PROTECT THE SAFETY OF ALL PERSONS ON THE PROPERTY THROUGHOUT THE ENTIRE PERIOD OF CONSTRUCTION.
- CONTRACTOR SHALL BE RESPONSIBLE FOR CONTINUOUS CLEANUP OF THE SITE OF ALL DEBRIS WHETHER CREATED BY HIS WORK OR THE FAILURE OF HIS SUBCONTRACTORS TO CLEAN UP AFTER THEIR WORK.
- INSTALL APPROVED FIRE-RATED DAMPERS WHERE DUCTS PENETRATE FIRE RATED PARTITIONS, CEILING AND FLOOR ASSEMBLIES.
- GENERAL CONTRACTOR TO ENSURE THAT ALL PARTITIONS ARE ATTACHED OR BRACED TO STRUCTURAL MEMBERS AND/OR SLAB ABOVE AS REQUIRED TO BE SAFE AND SECURE. SUPPORT LATERALLY AND SEISMICALLY AS REQUIRED BY APPLICABLE CODES.
- ALL DRYWALL PARTITIONS TO BE STRAIGHT, TRUE, AND PLUMB IN FLAT EVEN PLANES, WITHOUT WARPAGE OR CRACKS. USE SPECIAL CARE IN PROVIDING TRUE AND FLAT SURFACES FOR FINAL FINISH BY OTHER BUILDING TRADES INCLUDING PAINTING, WALL COVERING, RESIDENT BASE, MILL WORK, AND TRIM.
- ALL WORK SHALL COMPLY WITH APPLICABLE FEDERAL LAWS, STATE STATUTES, LOCAL ORDINANCES AND REGULATIONS OF AGENCIES HAVING JURISDICTION.
- CONTRACTOR SHALL ASSUME FULL RESPONSIBILITY FOR COMPLYING WITH THE CONSTRUCTION SAFETY ORDERS AND THE GENERAL INDUSTRIAL SAFETY ORDERS OF THE STATE DIVISION OF INDUSTRIAL SAFETY, HEALTH ADMINISTRATIONS AND SUCH OTHER AGENCIES GOVERNING THE CONTRACTORS ACTS.
- THE CONTRACTOR SHALL BE RESPONSIBLE FOR AND HOLD HARMLESS THE DESIGNER FOR ANY DAMAGES AND / OR PENALTY RESULTING FROM HIS FAILURE TO COMPLY WITH SAID LAWS, STATUTES, ORDINANCES AND REGULATIONS.
- THE DESIGN ADEQUACY AND SAFETY OF ERECTION BRACING, SHORING, TEMPORARY SUPPORTS, ETC. IS THE SOLE RESPONSIBILITY OF THE GENERAL CONTRACTOR.
- OBSERVATION VISITS TO THE SITE BY THE DESIGNER SHALL NOT INCLUDE THE INSPECTION OF THE ABOVE LISTED ITEMS.
- SHOT PINS: CLARK INDUSTRIES - PORTLAND, OREGON-CBO #1280 OR #2415 OR APPROVED EQUAL 3/16" DIAMETER @ 24" O.C. MAX UNLESS NOTED OTHERWISE.
- PROVIDE MUD-IN TYPE L-METAL (USO METAL TRIM 200A OR APPROVED EQUAL) FOR ALL EXPOSED EDGES OF GYPSUM WALLBOARD SURFACES AND WHERE WALLBOARD ADJUTS OTHER MATERIALS.
- ALL CONSTRUCTION SHALL COMPLY WITH THE 2013 EDITION OF THE CBC, CBC, OPC, AND CEC AS ADOPTED AND AMENDED BY THE STATE OF CALIFORNIA IN TITLE 24 COR AND THIS JURISDICTION.
- SEPARATE PERMITS ARE REQUIRED FOR MECHANICAL, ELECTRICAL, AND PLUMBING.
- A SECURITY FENCE SHALL BE PROVIDED AROUND THE CONSTRUCTION AREA AND SHALL BE INSTALLED PRIOR TO EXCAVATION AND/OR FOUNDATION TRENCHING.
- WATER SHALL BE PROVIDED ON THE SITE AND USED TO CONTROL DUST.
- TEMPORARY TOILET FACILITIES SHALL BE PROVIDED ON SITE.
- WHEN REQUIRED BY THE BUILDING OFFICIAL, PROPERTY LINES SHALL BE ESTABLISHED IN THE FIELD BY A LICENSED SURVEYOR.

PROJECT INFORMATION	
<b>CONSULTANT LIST</b>	
<b>DESIGNER:</b>	IGNACIO RODRIGUEZ 1327 S. WESTGATE AVE #201 LOS ANGELES, CA 90025 PHONE: 424.271.4850 EMAIL: ignacio@ignacioproducts.com
<b>CONTACT:</b>	IGNACIO RODRIGUEZ
<b>CIVIL ENGINEER:</b>	LC ENGINEERING GROUP 889 PERDUE CT. STE 101 THOUSAND OAKS, CA 91320 PHONE: 818.981.7148 EMAIL: info@lcegroup.com
<b>CONTACT:</b>	MICHELLE MEDMAN
<b>SEPTIC ENGINEER:</b>	BARTON BLUTSKE 630 ROOSEVELT CT SUN VALLEY, CA 94085 805.581.2931 EMAIL: jacob@bartonblutskes.com
<b>CONTACT:</b>	BARTON
<b>ARBORIST:</b>	JAMES DEAN AS LA 222 E. THOUSAND OAKS BLVD STE 101 THOUSAND OAKS, CA 91320 800.484.0623 EMAIL: james@jamesdeanarb.com
<b>CONTACT:</b>	JAMES
<b>LANDSCAPE ARCHITECT:</b>	OLYVYN KINDERY P.O. BOX 780 HENSBURY PARK, CA 91320 805.279-323-358-8279 EMAIL: olivyn@olivynkindery.com
<b>CONTACT:</b>	OLYVYN
<b>SOILS ENGINEER:</b>	CALWEST GEOTECHNICAL 889 PERDUE CT. STE 101 THOUSAND OAKS, CA 91320 PHONE: 818.981.7148 EMAIL: calwest@calwest.com
<b>CONTACT:</b>	ELI
<b>GEOLGIST:</b>	LAND PHASES INC. 5158 COCHRAN ST. SUN VALLEY, CA 94085 PHONE: 805.522.5114 EMAIL: jacob@landphases.com
<b>CONTACT:</b>	JAKE HOLY

SHEET INDEX	
<b>ARCHITECTURAL</b>	
AD 0	COVER SHEET NOTES
AM.1	NOTES
A1.1	SITE PLAN
A2.0	LOWER LEVEL
A2.1	MARK LEVEL
A3.1	ROOF PLAN
AA.1	EXTERIOR ELEVATIONS
AA.2	EXTERIOR ELEVATIONS
AA.3	SECTIONS
AA.4	SECTIONS
AA.5	WINDOW AND DOOR SCHEDULE
A7.1	DETAILS
A7.2	DETAILS
AA.1	COLOR BOARD
AA.2	RENDERINGS
AA.3	
AA.4	
<b>CIVIL</b>	
1	COVER SHEET
2	SLOPE ANALYSIS AND TOPO
3	GRADING AND DRAINAGE PLAN
4	SECTIONS AND DETAILS
5	EROSION CONTROL PLAN COVER SHEET
6	EROSION CONTROL PLAN
7	EROSION CONTROL ATTACHMENTS
<b>LANDSCAPE</b>	
L1	SITE PLAN
L2	LANDSCAPE PLAN
L3	LIGHTING PLAN

PROJECT DATA / CODE COMPLIANCE	
<b>PROPERTY SQUARE FOOTAGE CALCULATIONS</b>	
<b>PROPOSED</b>	<b>ALLOWED / REQUIRED</b>
LOT AREA: 1.38 ACRES (59,983 SQ. FT.)	1 ACRE MIN (43,560 SQ. FT.)
BUILDING HEIGHT: 29'-5 1/2"	BUILDING HEIGHT: 35'-0"
SQUARE FOOTAGE	FLOOR AREA RATIO BASED ON LOT SIZE
• LOWER FLOOR = 1,043 SQ. FT.	• 5,200 SQ. FT. PLUS
• UPPER FLOOR = 3,669 SQ. FT.	• .02 X 19,982 = 399 SQ. FT.
TOTAL	MAX FAR BASED ON LOT 5,599 SQ. FT.
• GARAGE = 892 SQ. FT.	MINUS SLOPE FACTOR: AVERAGE SLOPE IS 20%
• COVERED LOGGIA = 804 SQ. FT.	• 5,599 X .95 =
TOTAL	1,296 SQ. FT.
MAX FAR	4,712+604+2= 5,318 SQ. FT. OK
	MAX FAR ALLOWED 5,319 SQ. FT.
<b>CREDITS</b>	
• GARAGE = 690 SQ. FT.	
<b>LOT COVERAGE</b>	
MAX ALLOWED IS 25% OF LOT	
59,983 X .25 = 14,990 SQ. FT.	
UPPER FLOOR = 3,669 SQ. FT.	
GARAGE = 892 SQ. FT.	
LOGGIA = 302 SQ. FT.	
POOL = 748 SQ. FT.	
POOL DECK = 1,838 SQ. FT.	
DRIVEWAY & MOTORCOURT = 3,653 SQ. FT.	
HARDSCAPE/ WALKWAYS = 968 SQ. FT.	
TOTAL = 11,868 SQ. FT. OK 18.8%	

SYMBOL LEGEND		
(A)	DOOR REFERENCE	2X FRAMING
(A)	WINDOW REFERENCE	STEEL
(B)	KEYNOTE	BATT INSULATION
(B)	REVISION NUMBER	ROD INSULATION
(B)	REVISION CLOUD	STONE
(B)	FIN. FLR.	FINISHED WOOD
(B)	ELEVATION HEIGHT REFERENCE	ROUGH LUMBER CONTINUOUS MEMBER
(B)	DETAIL NUMBER	ROUGH LUMBER/ROOFING
(B)	SECTION CUT NUMBER	CONCRETE
(B)	ELEVATION NUMBER	PLYWOOD
(B)		CHAIRST FAN
(B)		INTERIOR ELEVATION REFERENCE



SUBMITTAL DATES	OWNER	PLAN CHECK	DATE	NO.
1				
2				
3				
4				
5				
6				
7				
8				
9				
10				

DESIGN: **IGNACIO RODRIGUEZ**  
 DESIGN CONSULTANTS  
 5952 LAPWORTH DRIVE  
 AGOURA, CA 91301  
 P.O. BOX 288  
 F: 818.981.2888  
 EMAIL: ignacio@ignacioproducts.com

JOB NO: 2014.41.01  
 DATE: 03/18/2015  
 DRAWN BY: L.R.  
 APPROVED BY: L.R.

SHEET NO: **A0.0**





**PROPERTY SQUARE FOOTAGE CALCULATIONS**

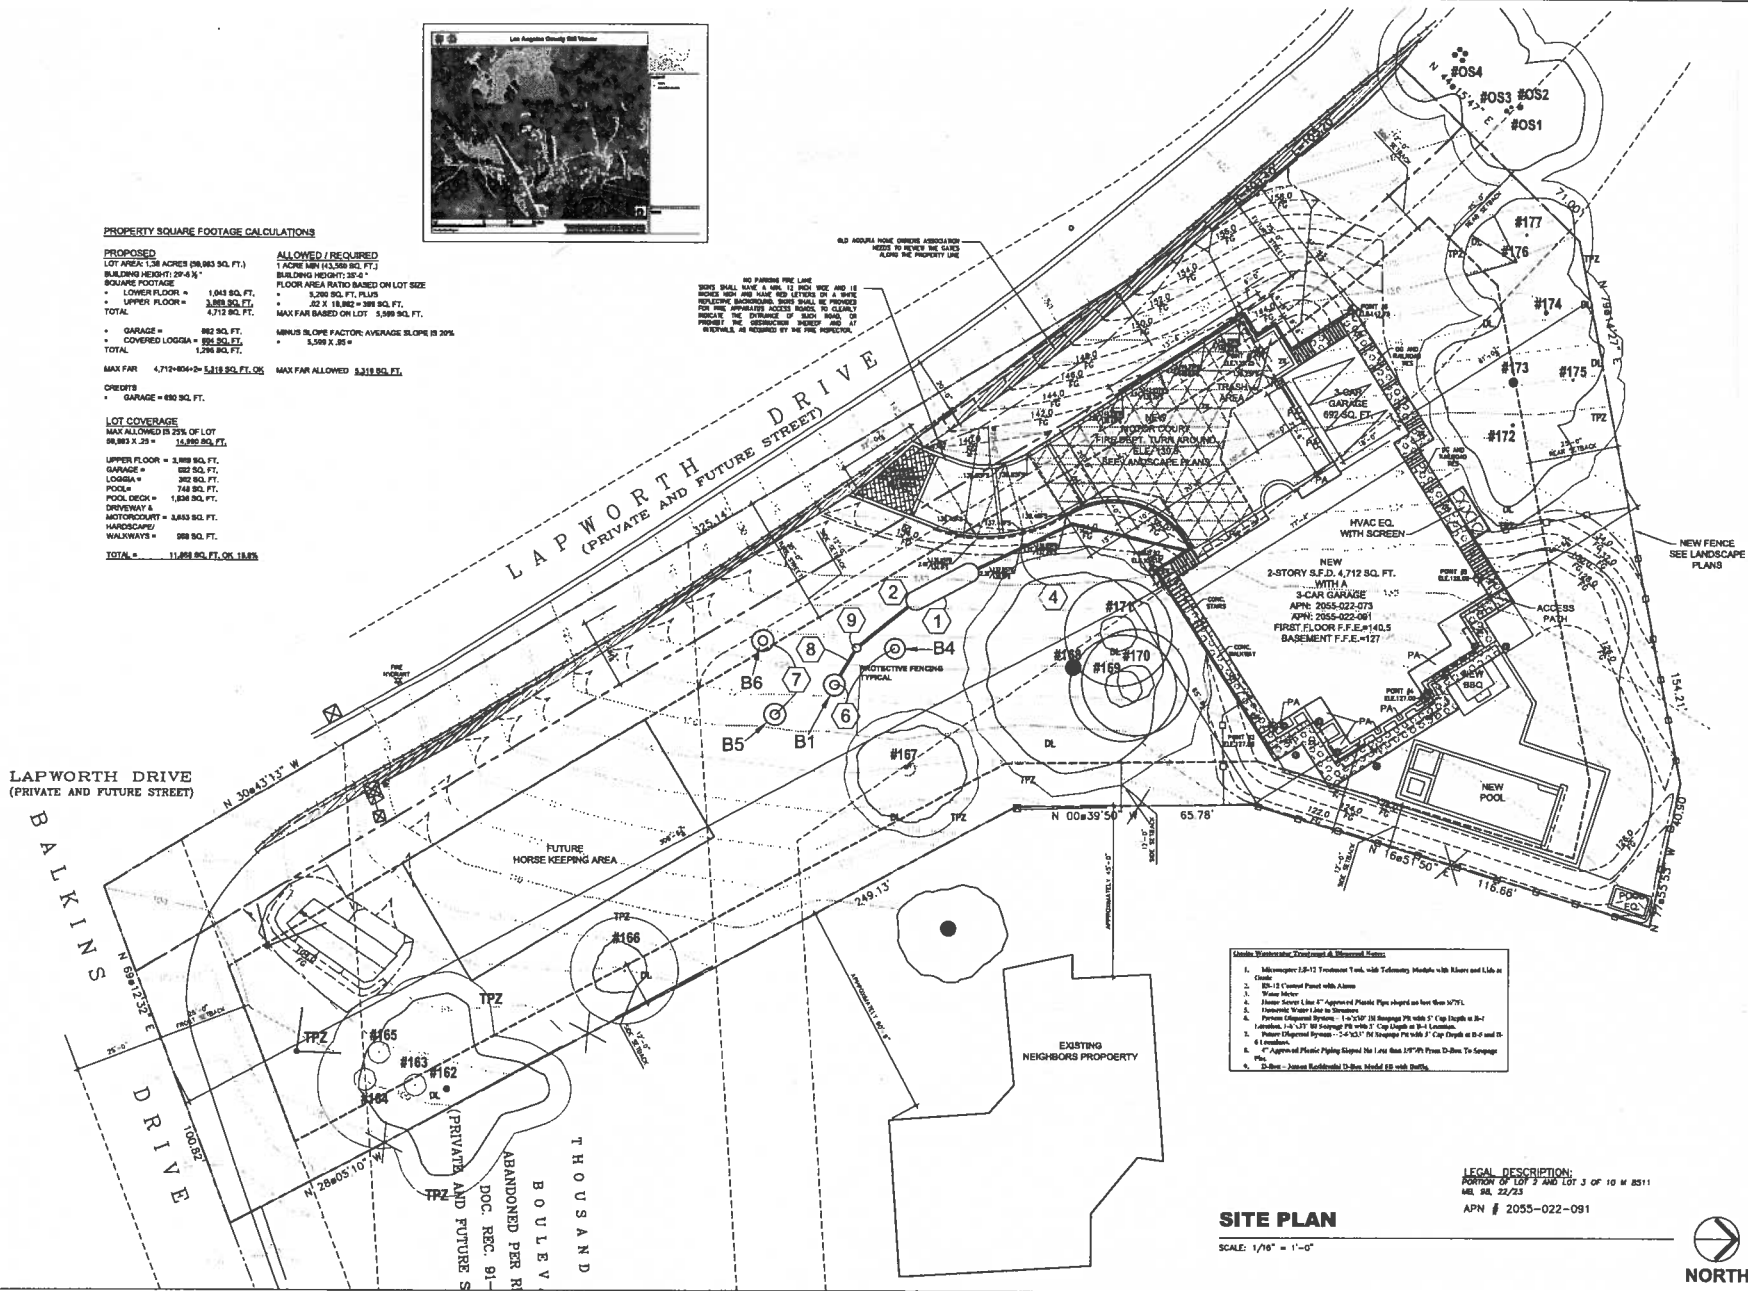
PROPOSED	ALLOWED / REQUIRED
LOT AREA: 1.38 ACRES (58,963 SQ. FT.)	1 ACRE MIN (43,560 SQ. FT.)
BUILDING HEIGHT: 29'-8 1/2"	BUILDING HEIGHT: 35'-0"
SQUARE FOOTAGE:	FLOOR AREA RATIO BASED ON LOT SIZE
• LOWER FLOOR = 1,043 SQ. FT.	• 3,200 SQ. FT. PLUS
• UPPER FLOOR = 3,889 SQ. FT.	• 22 X 18,982 = 399 SQ. FT.
TOTAL = 4,932 SQ. FT.	MAX FAR BASED ON LOT: 3,389 SQ. FT.
• GARAGE = 892 SQ. FT.	MINUS SLOPE FACTOR: AVERAGE SLOPE IS 20%
• COVERED LOGGIA = 892 SQ. FT.	• 3,589 X .80 =
TOTAL = 1,784 SQ. FT.	
MAX FAR: 4.712 x 0.84 = 3.958 SQ. FT. OR	MAX FAR ALLOWED: 3.218 SQ. FT.

**CREDITS**  
 • GARAGE = 892 SQ. FT.

**LOT COVERAGE**  
 MAX ALLOWED IS 25% OF LOT  
 98,963 X .25 = 14,890 SQ. FT.  
 UPPER FLOOR = 3,889 SQ. FT.  
 GARAGE = 892 SQ. FT.  
 LOGGIA = 892 SQ. FT.  
 POOL = 748 SQ. FT.  
 POOL DECK = 1,838 SQ. FT.  
 DRIVEWAY & MOTORCOURT = 3,843 SQ. FT.  
 HARDSHIP = 588 SQ. FT.  
 WALKWAYS = 588 SQ. FT.  
 TOTAL = 11,896 SQ. FT. OR 12.8%

NO PARKING FIRE LANE  
 SIGNS SHALL HAVE A MIN. 12" SIGN SIZE AND 18" SIGNS HIGH AND HAVE RED LETTERS ON A WHITE REFLECTIVE BACKGROUND. SIGN SHALL BE PROMINENT FOR THE APPROPRIATE ACCESS ROAD TO CLEARLY INDICATE THE DIRECTION OF SUCH ROAD TO PROMPT THE OCCUPATION STOP AND 7' MINIMUM, AS REQUIRED BY THE MUNICIPAL.

OLD HOVULE HOME OWNER ASSOCIATION NEEDS TO REVIEW THE SIGNED ALONG THE PROPERTY LINE



- Grading, Retention, Treatment & Stormwater**
1. 15-gal/yr 1.5-1.7 Treatment Tank, with Telemetry, with 1500 and 1.5 in. Dia.
  2. 15-12' Cased Pile with Alarm
  3. Waste Meter
  4. House Sewer Line 4" Approved Plastic Pipe along on lot line 1/2" TL
  5. Permanent Water Line to Structure
  6. Pressure Regulated System - 1/2" x 1/2" JIS Scheduling PE with 5' Cap Depth in 30-4' Trenches - 1/2" x 1/2" JIS Scheduling PE with 5' Cap Depth in 30-4' Trenches
  7. Water Regulated System - 1/2" x 1/2" JIS Scheduling PE with 5' Cap Depth in 30-4' Trenches
  8. 4" Approved Plastic Piping Sloped for 1/4" per 100' from 12-Box To Sump
  9. 12-Box - Jones Residential 12-Box Model 88 with Shutts

**LEGAL DESCRIPTION:**  
 PORTION OF LOT 3 AND LOT 5 OF 10 W 8511  
 MBL SH. 22/23  
 APN # 2055-022-091

**SITE PLAN**

SCALE: 1/8" = 1'-0"



NO.	DATE	NO.	DATE
1		2	
3		4	
5		6	

SUBMITTAL DATES:	
OWNER:	PLAN CHECK:
O.T.R.:	O.T.R.:

**DESIGN:**  
**IGNACIO RODRIGUEZ**  
 DESIGN CONSULTANTS  
 5800 ALDEA AVE.  
 SUITE 110  
 FOLSOM, CA 95630  
 PHONE: 916.450.1333  
 FAX: 916.450.1338  
 Email: ignacio@ignaciodesign.com

**SITE PLAN**  
 NEW RESIDENCE FOR:  
**VINEET AND ANNETTE SHARMA**  
 5952 LAPWORTH DRIVE  
 AGOURA, CA

JOB NO: 2014.41.01  
 DATE: 03/18/2015  
 DRAWN BY: I.R.  
 APPROVED BY: I.R.

SHEET NO:  
**A1.1**

# LOWER FLOOR PLAN

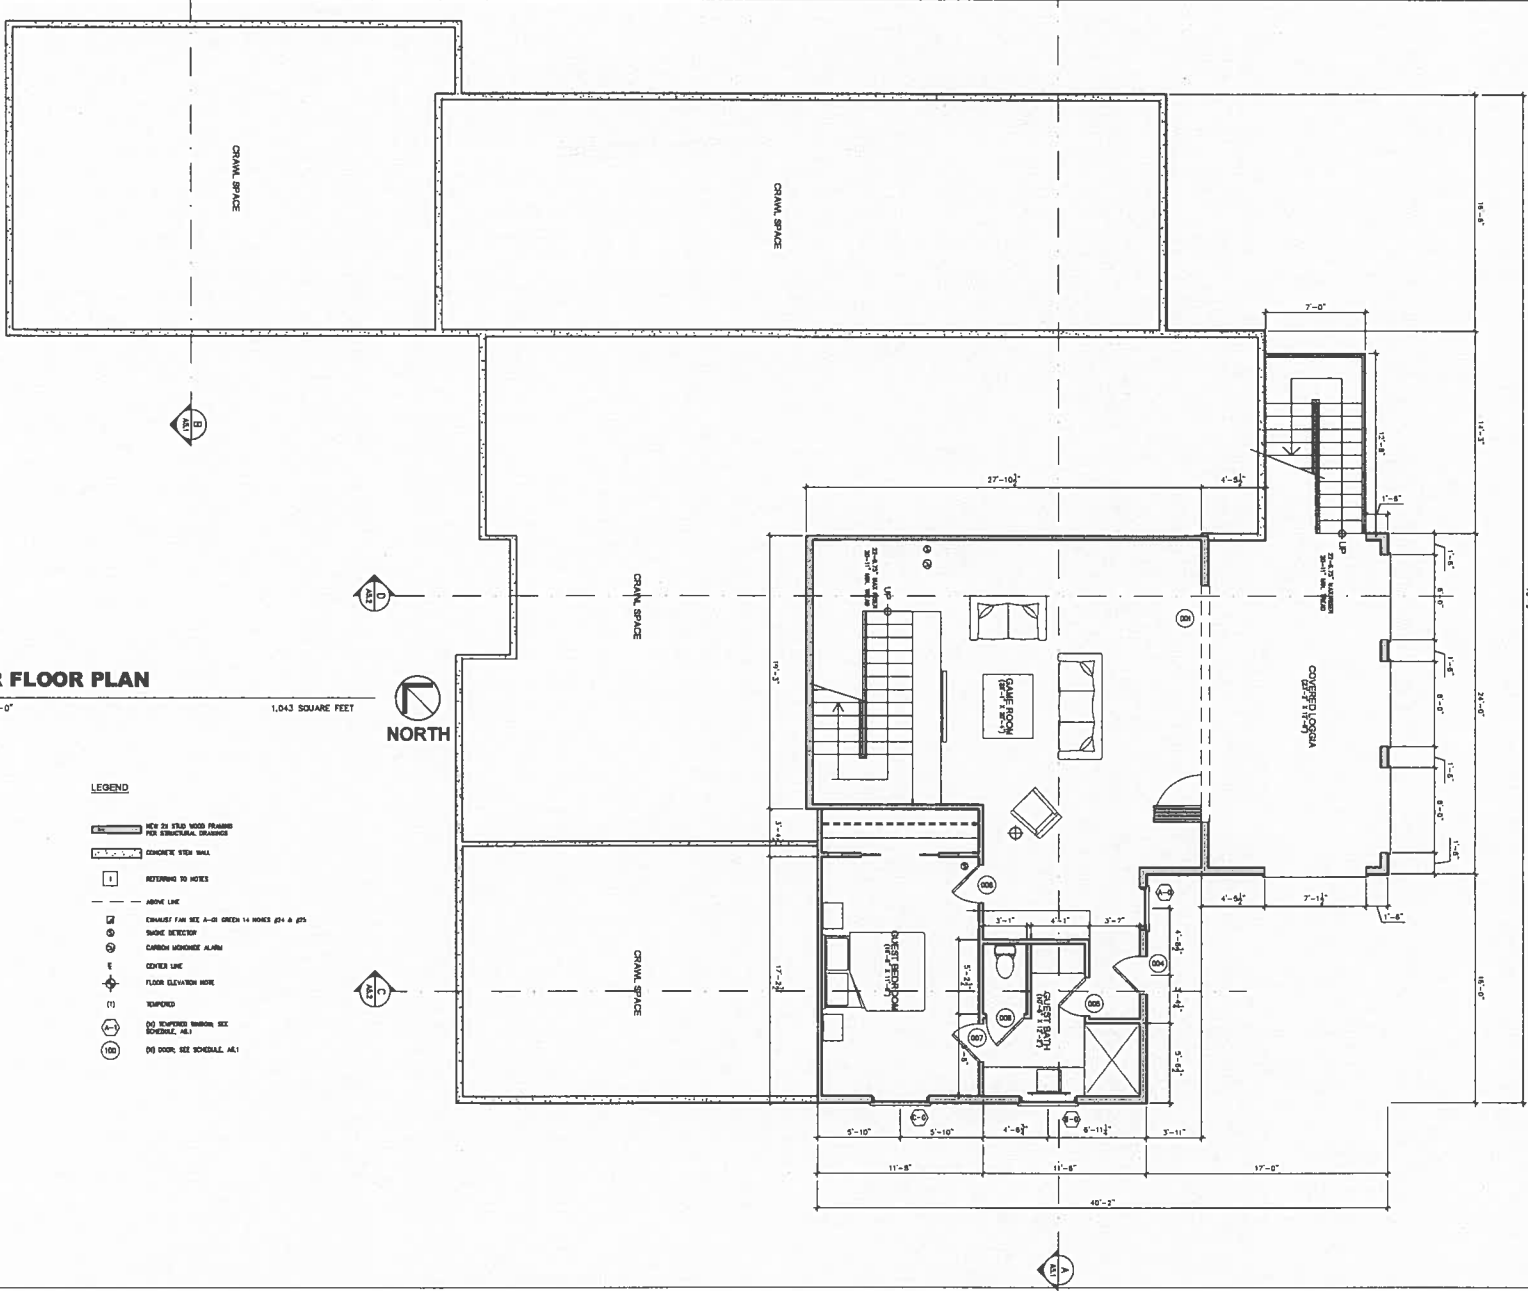
SCALE: 1/4" = 1'-0"

1,043 SQUARE FEET



### LEGEND

- NEW TO STEEL WOOD FRAMING FOR STRUCTURAL DRAINAGE
- CONCRETE STEM WALL
- RETAINING TO NOTES
- ABOVE LINE
- CHANGE FAN SEE A-10 GREEN 14 NOTES PER A 10
- SMOKE DETECTOR
- CARBON MONOXIDE ALARM
- COVER LINE
- FLOOR ELEVATION MARK
- REVISED
- 00 EQUIPPED TIMBER SEX SCHEDULE, ETC.
- 00 DOOR SEE SCHEDULE, ETC.



## LOWER FLOOR PLAN

DESIGN:  
**IGNACIO RODRIGUEZ**  
 DESIGN CONSULTANTS  
 5952 LAFWORTH DRIVE  
 AGGOURA, CA 91316  
 Email: ignacio@ignaciordesign.com

BHEET TITLE:  
 NEW RESIDENCE FOR:  
**VINEET AND ANNETTE SHARMA**  
 5952 LAFWORTH DRIVE  
 AGGOURA, CA

JOB NO: 2014.41.01  
 DATE: 03/18/2018  
 DRAWN BY: I.R.  
 APPROVED BY: L.R.

OWNER:	NO.	DATE
PLAN CHECK:	NO.	DATE
O.I.R.:	NO.	DATE

REVISIONS:	NO.	DATE
1		
2		
3		
4		

DATE:	NO.	DATE
1		
2		
3		
4		

DATE:	NO.	DATE
1		
2		
3		
4		

BHEET NO:  
**A2.0**

# UPPER FLOOR PLAN

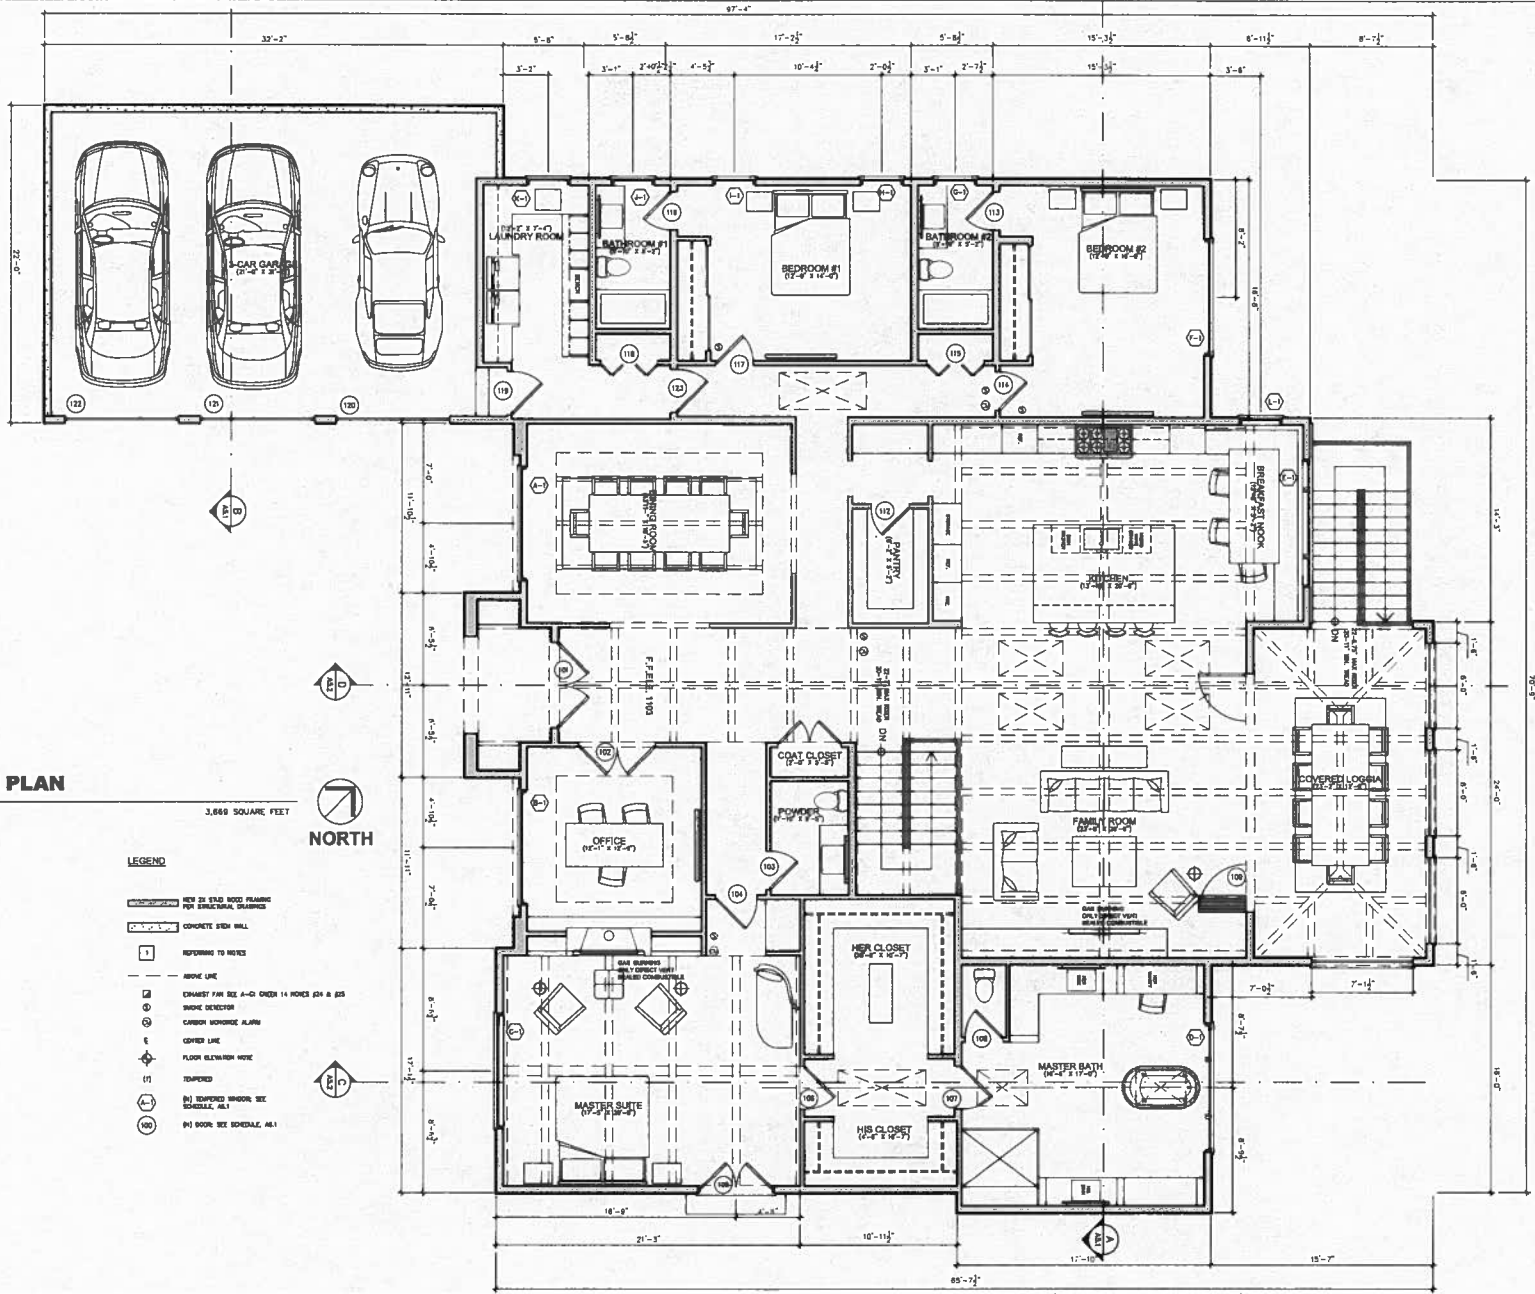
SCALE: 1/4" = 1'-0"

3,669 SQUARE FEET



### LEGEND

- NEW 2x STUD WOOD FRAMING PER STRUCTURAL DRAWINGS
- CONCRETE STEM WALL
- REFERRING TO NOTES
- ABOVE LINE
- EXHAUST FAN SEE SCHEDULE 14 NOTES 204 & 205
- SMOKE DETECTOR
- CARBON MONOXIDE ALARM
- CEILING LINE
- FLOOR ELEVATION NOTE
- TAPERED
- EQUIPPED WINDOW SEE SCHEDULE 14.1
- DOOR SEE SCHEDULE 14.1



DATE	NO.	NO.
DATE	NO.	NO.
DATE	NO.	NO.


OWNER:	PLAN CHECK:	O.T.A.
DATE:	DATE:	DATE:

DESIGNER:  
**IGNACIO RODRIGUEZ**  
 DESIGN CONSULTANTS  
 10000 S. LAKE AVENUE  
 ENCLINO, CA 94116  
 PH: 415.438.3338 Fax: 855.374.6718  
 Email: ignacio@designerignacio.com

SHEET TITLE: **UPPER FLOOR PLAN**  
 NEW RESIDENCE FOR:  
**VINEET AND ANNETTE SHARMA**  
 5852 LAPWORTH DRIVE  
 AIGORA, CA

JOB NO:	2014.41.01
DATE:	03/16/2015
DRAWN BY:	L.R.
APPROVED BY:	L.R.

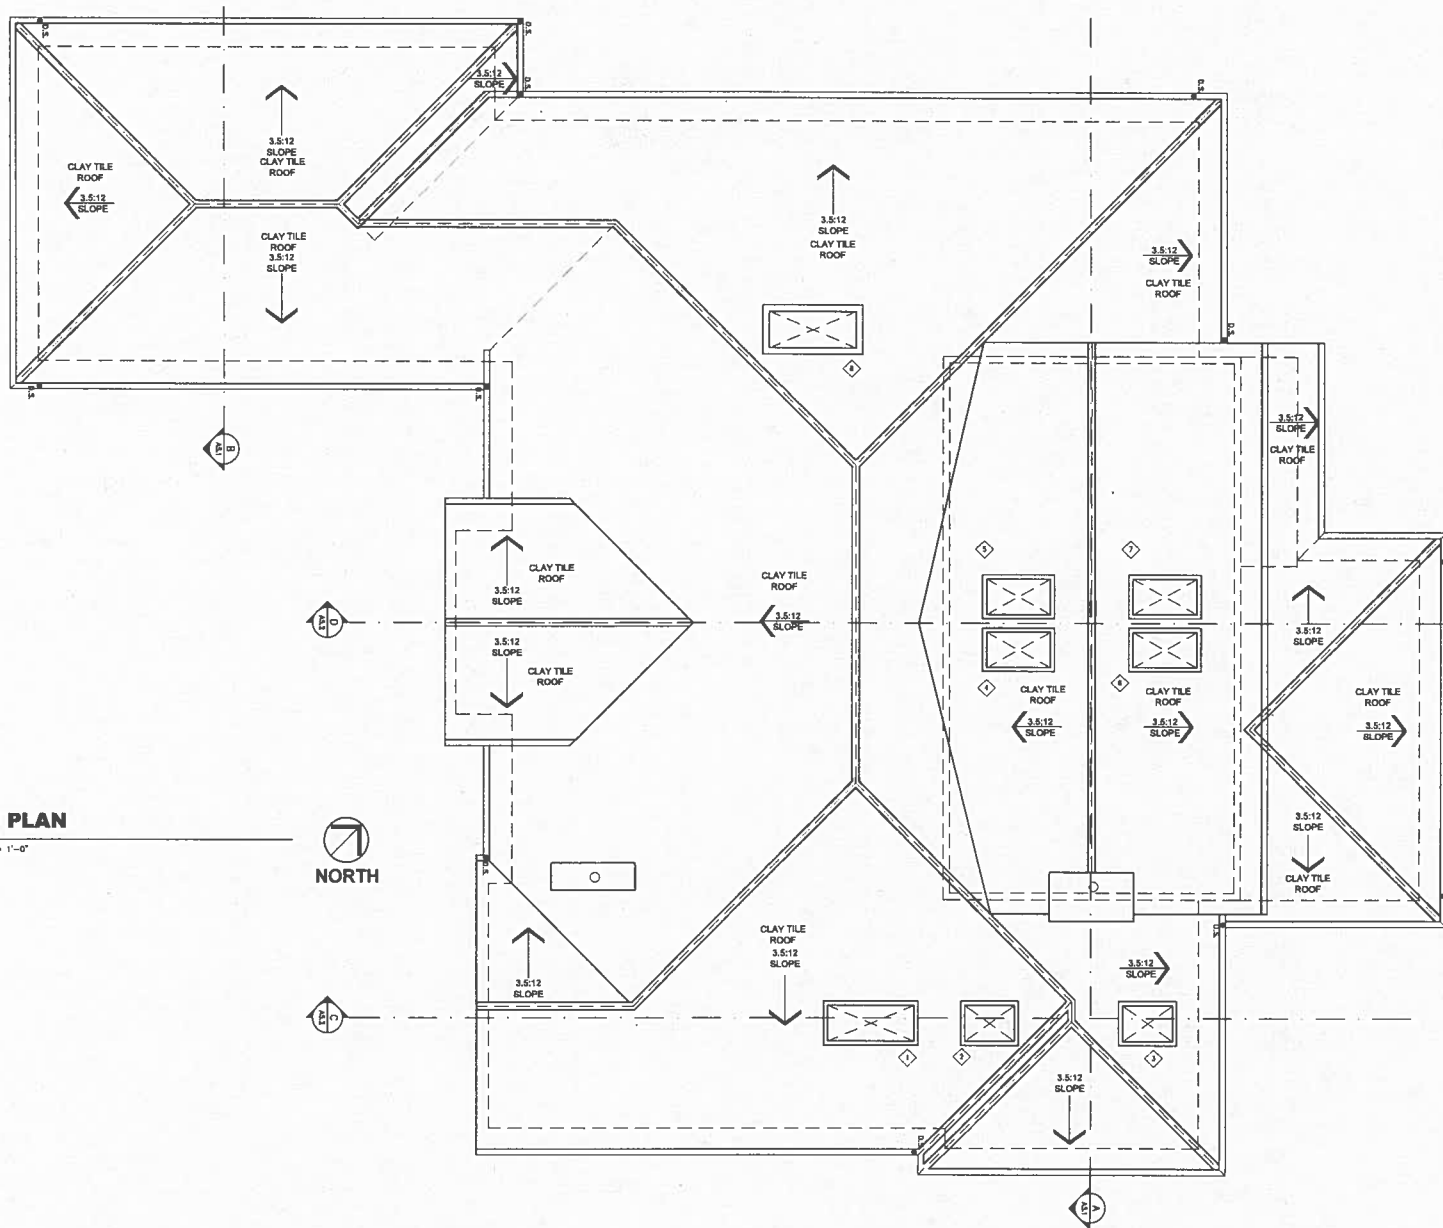SHEET NO:  
**A2.1**




**ROOF PLAN**

SCALE: 1/4" = 1'-0"



NORTH

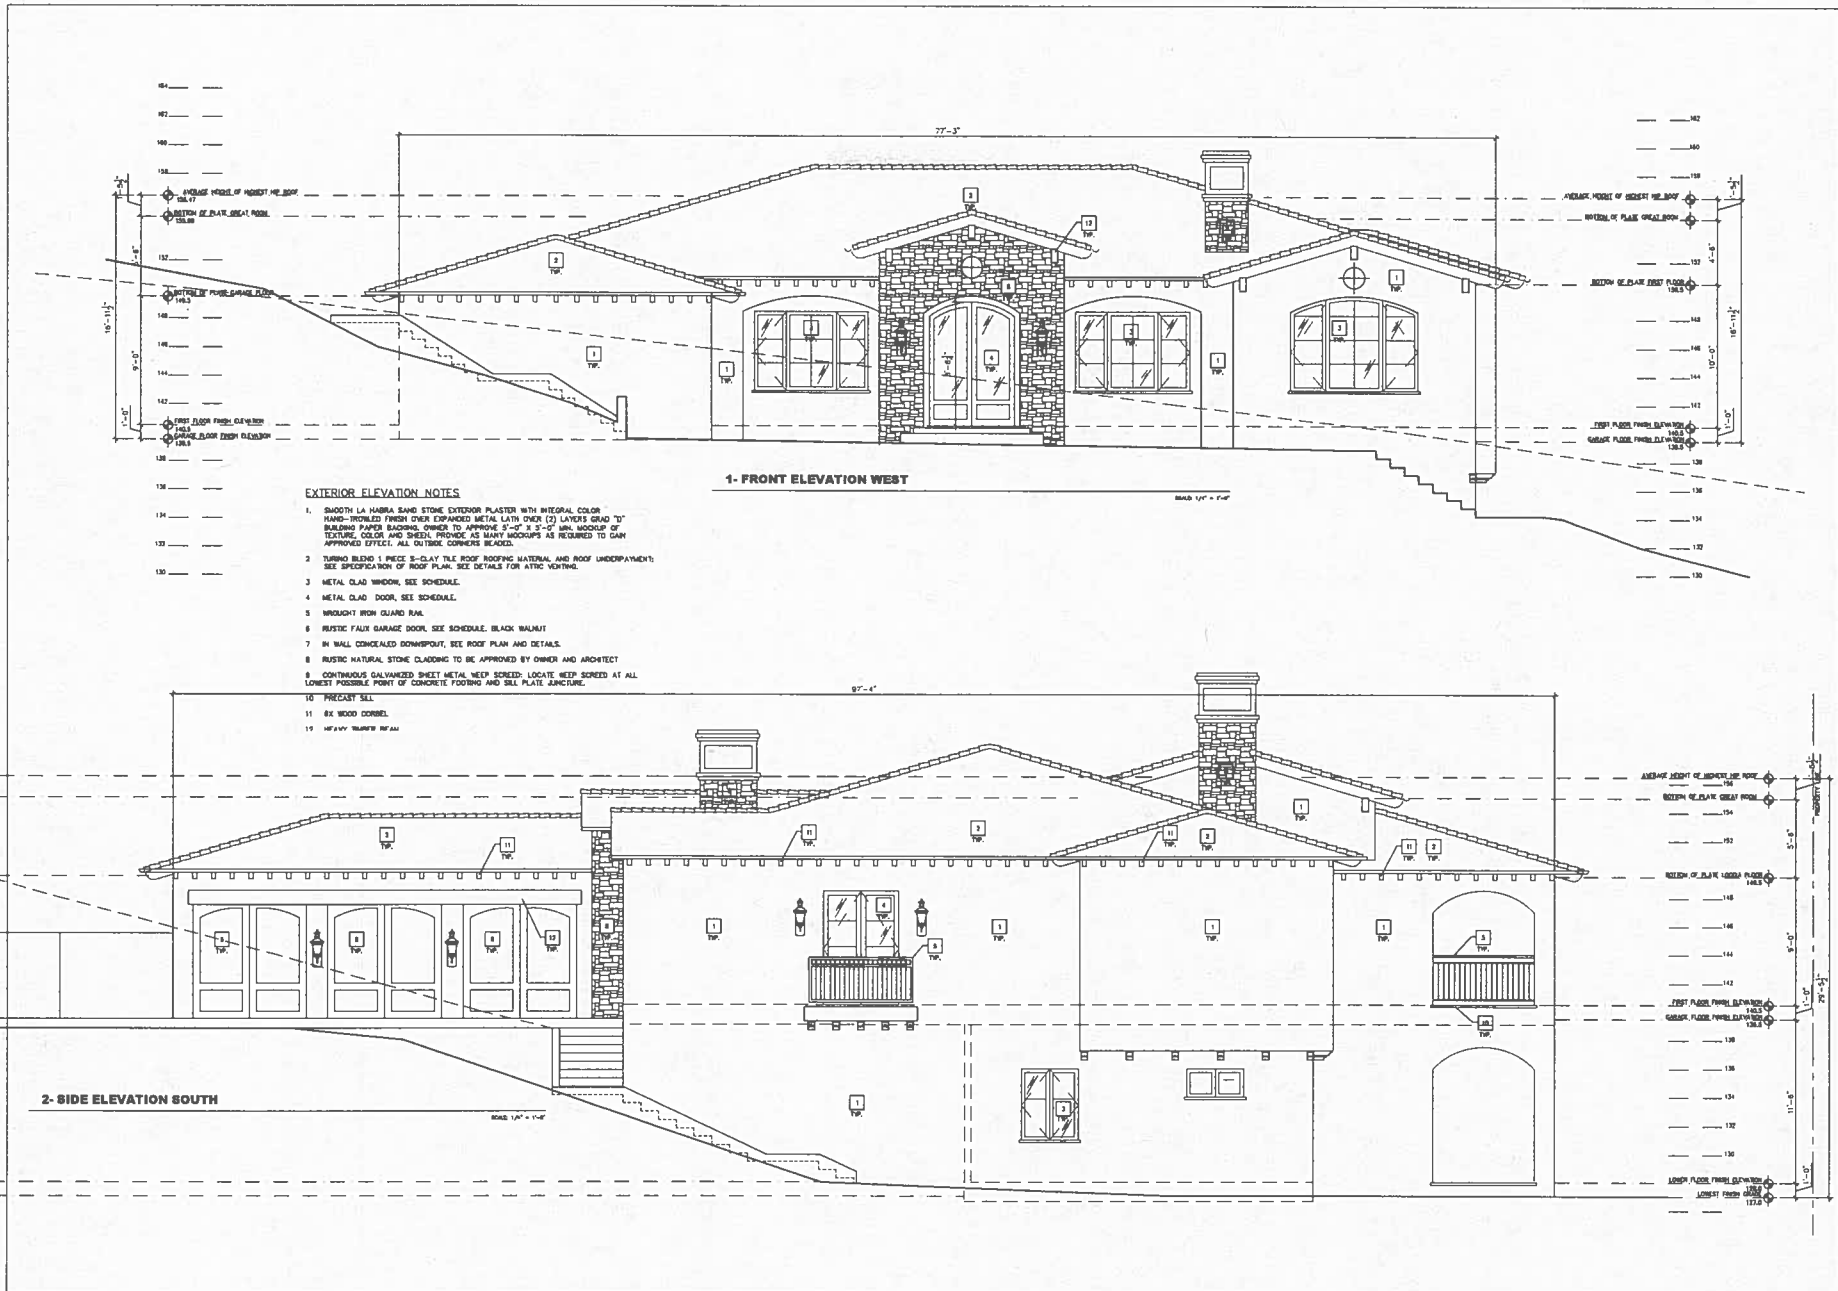SUBMITTAL DATES:		NO.	DATE
1	2	3	4
5	6	7	8
9	10	11	12
OWNER:		DATE	
PLAN CHECK:		NO.	
C.T.A.:		DATE	
SHEET TITLE: <b>ROOF PLAN</b> NEW RESUBMISSION FOR: <b>VINEET AND ANNETTE SHARMA</b> 9902 LAPPWORTH DRIVE AGOURA, CA			
DESIGNED BY: <b>IGNACIO RODRIGUEZ</b> DESIGN CONSULTANTS 10000 WILSON AVENUE SUITE 100 BAYVIEW, CA 94026 PH: 818.200.8888 FAX: 888.276.8218 Email: ignacio@ignaciodesign.com			
JOB NO:	2014.41.01		
DATE:	03/18/2016		
DRAWN BY:	L.R.		
APPROVED BY:	L.R.		
SHEET NO:			
<b>A3.1</b>			



- EXTERIOR ELEVATION NOTES**
- SMOOTH LA HABRA SAND STONE EXTERIOR PLASTER WITH INTEGRAL COLOR. HAND-PROFFED FINISH OVER EXPANDED METAL LATH OVER (3) LAYERS GRAB "B" BUILDING PAPER BACKING. OWNER TO APPROVE 5'-0" X 3'-0" MIN. MOCKUP OF TEXTURE, COLOR AND SHEEN. PROVIDE AS MANY MOCKUPS AS REQUIRED TO OBTAIN APPROVED EFFECT. ALL OUTSIDE CORNERS BEADED.
  - TURNO BLEND 3 PIECE 3-CLAY TILE ROOF ROOFING MATERIAL AND ROOF UNDERPAMENT. SEE SPECIFICATION OF ROOF PLAN. SEE DETAILS FOR ATRIC VENTING.
  - METAL CLAD WOOD. SEE SCHEDULE.
  - METAL CLAD DOOR. SEE SCHEDULE.
  - WROUGHT IRON GILDED RAIL.
  - RUSTIC FAUX GARAGE DOOR. SEE SCHEDULE. BLACK WALNUT.
  - IN WALL CONCEALED DOWNSPOUT. SEE ROOF PLAN AND DETAILS.
  - RUSTIC NATURAL STONE CLADDING TO BE APPROVED BY OWNER AND ARCHITECT.
  - CONTINUOUS GALVANIZED SHEET METAL. KEEP SKEED. LOCATE KEEP SKEED AT ALL LOWEST POSSIBLE POINT OF CONCRETE FOOTING AND SILL PLATE JUNCTURE.
  - PRECAST SILL.
  - 6X WOOD CORBEL.
  - HEAVY WROUGHT IRON.

4	5	6	NO.	DATE
1	2	3	NO.	DATE
SUBMITTAL DATES:				
OWNER:		PLAN CHECK:		
O.T.B.		O.T.B.		

**EXTERIOR ELEVATIONS**

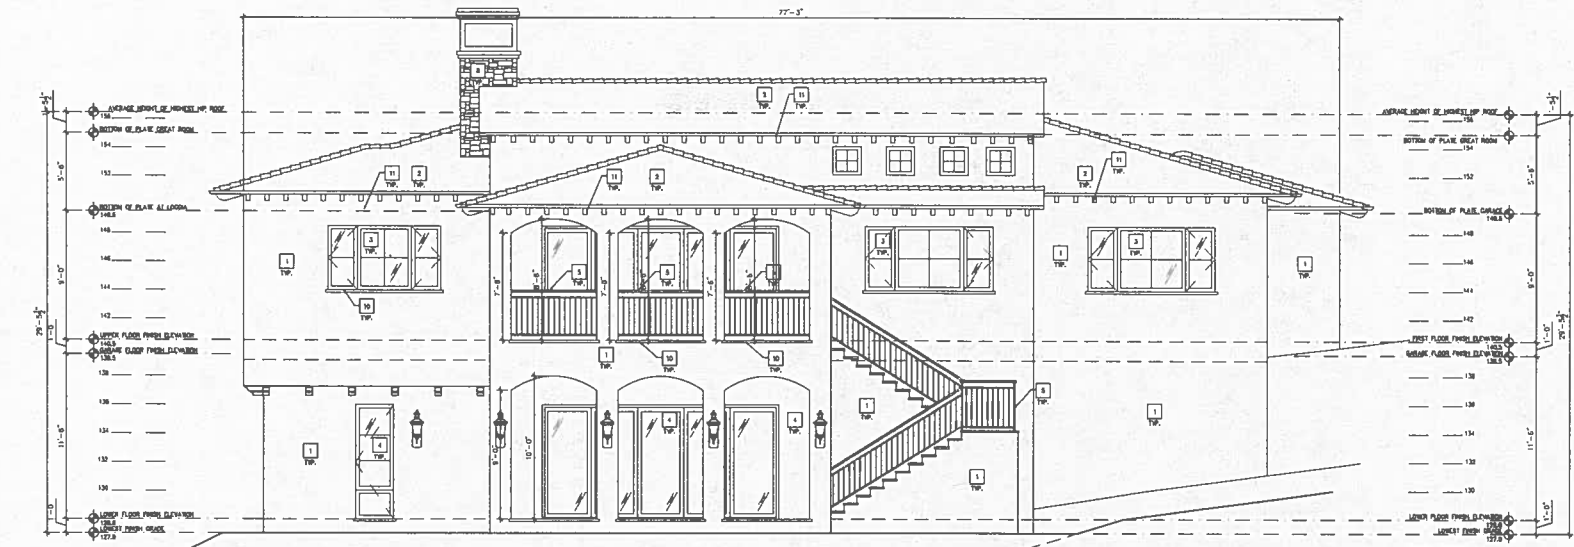
DESIGNER:  
**IGNACIO RODRIGUEZ**  
 DESIGN CONSULTANTS  
 5952 LAPWORTH DRIVE  
 AGGORA, CA 94503  
 PH: 925.278.8288  
 Email: ignacio@ignaciordesign.com

NEW RESIDENCE FOR:  
**VINEET AND ANNETTE SHARMA**  
 5952 LAPWORTH DRIVE  
 AGGORA, CA


SHEET TITLE: EXTERIOR ELEVATIONS

JOB NO: 2014.41.01  
 DATE: 03/18/2018  
 DRAWN BY: L.R.  
 APPROVED BY: L.R.

SHEET NO: **A4.1**



3- REAR ELEVATION EAST

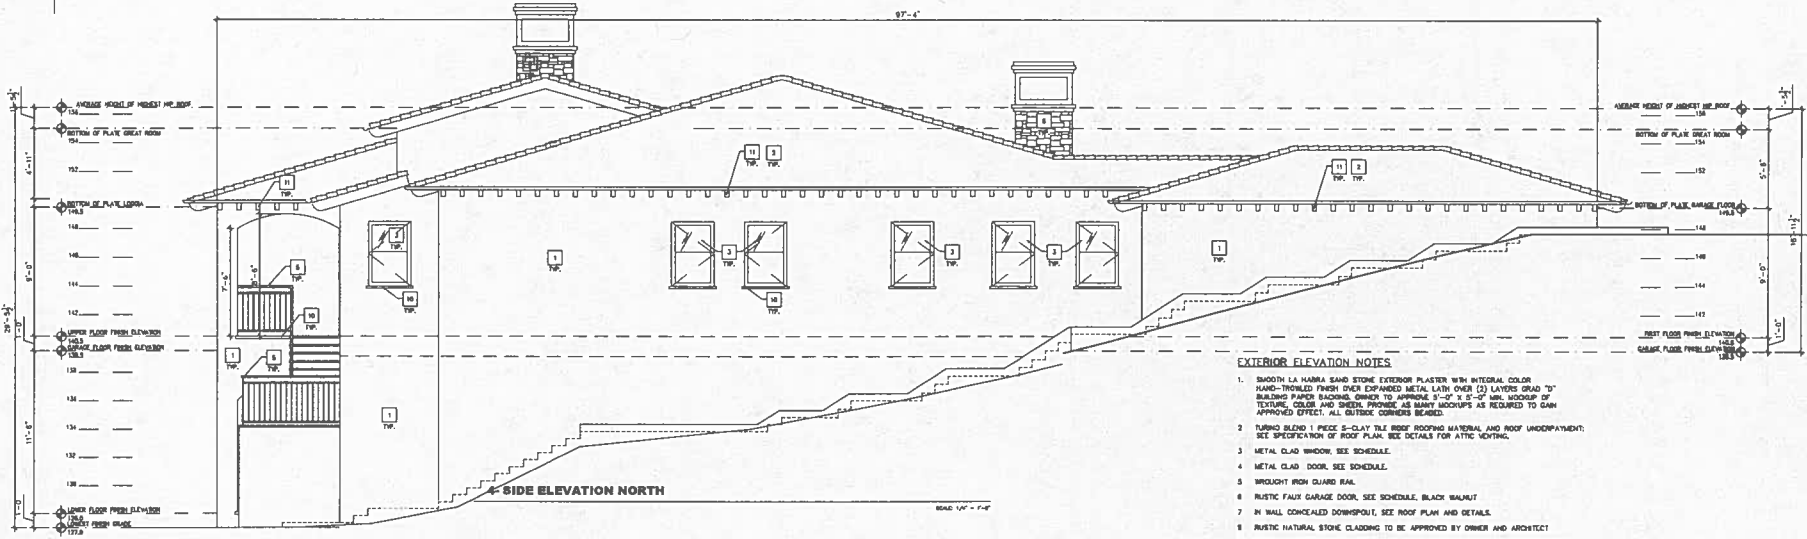

4- SIDE ELEVATION NORTH

**EXTERIOR ELEVATION NOTES**

1. SMOOTH LA HABRA SAND STONE EXTERIOR PLASTER WITH INTERNAL COLOR SAND-TROWLED FINISH OVER EXPANDED METAL LATH OVER (3) LAYERS GRAF "D" BUILDING PAPER BARRING. OWNER TO APPROVE 1/2" x 5/8" x 5/8" MFL WOODWORK OF TEXTURE, COLOR AND SHEET FINISH AS MANY SAMPLES AS REQUIRED TO OBTAIN APPROVED EFFECT. ALL OUTSIDE CORNERS BEADED.
2. TURBO BLEND 1 PIECE 2-CLAY TILE ROOFING MATERIAL AND ROOF UNDERPAYMENT: SEE SPECIFICATION OF ROOF PLAN. SEE DETAILS FOR ATTIC VENTING.
3. METAL CLAD WINDOW, SEE SCHEDULE.
4. METAL CLAD DOOR, SEE SCHEDULE.
5. BROUGHT IRON GUARD RAIL.
6. RUSTIC FAUX GARAGE DOOR, SEE SCHEDULE, BLACK WALNUT.
7. IN WALL CONCEALED DOWNSPOUT, SEE ROOF PLAN AND DETAILS.
8. RUSTIC NATURAL STONE CLADDING TO BE APPROVED BY OWNER AND ARCHITECT.
9. CONTINUOUS GALVANIZED SHEET METAL WEAP SCREENS LOCATE WEAP SCREEN AT ALL LOWEST POSSIBLE POINT OF CONCRETE FOOTING AND SILL PLATE JUNCTURE.
10. PRECAST SILL.
11. 6X WOOD CORNICE.
12. HEAVY RUBBER SEAL.

**EXTERIOR ELEVATIONS**

DESIGNER:  
**IGNACIO RODRIGUEZ**  
 DESIGN CONSULTANTS  
 9022 LAPPWORTH DRIVE  
 SAN ANTONIO, CA 78258  
 PH: 214.246.2288  
 Email: ignacio@ignaciodesign.com

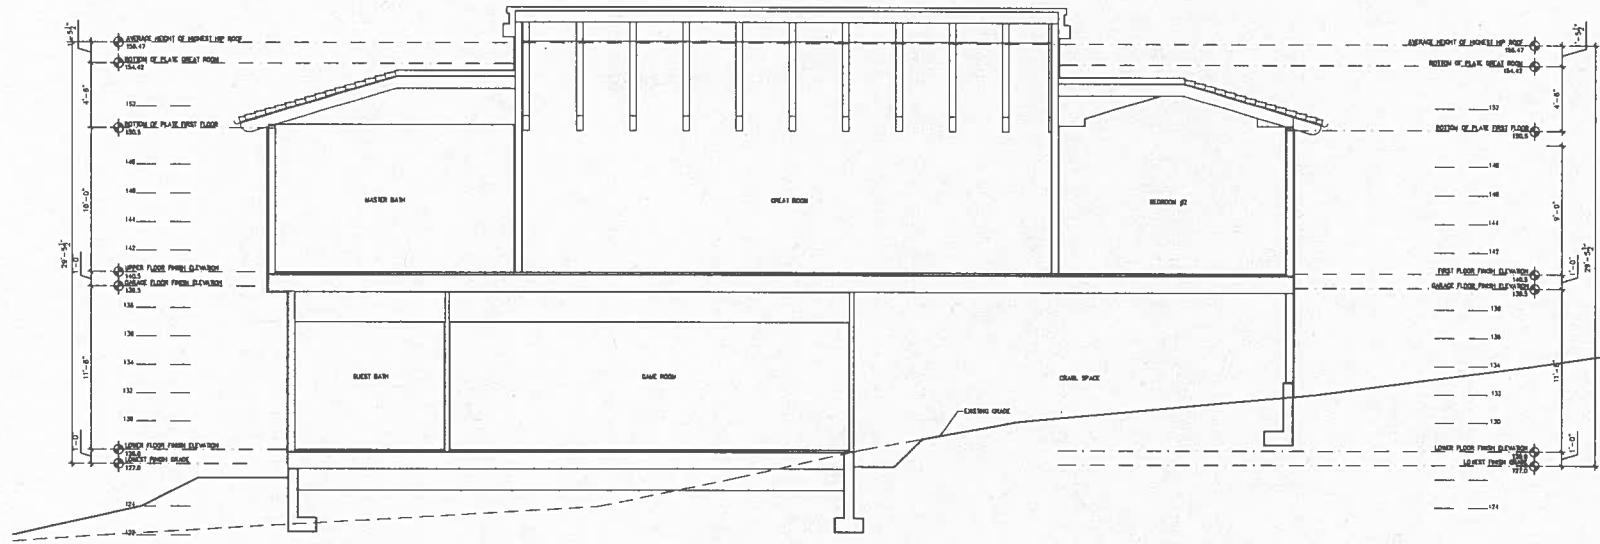
NEW RESIDENCE FOR:  
**VINEET AND ANNETTE SHARMA**  
 9022 LAPPWORTH DRIVE  
 AGOURA, CA

JOB NO: 2014.41.01  
 DATE: 03/18/2018  
 DRAWN BY: LR  
 APPROVED BY: I.R.

SHEET NO:  
**A4.2**


4	5	6	NO.	DATE
1	2	3	NO.	DATE

SUBMITTAL DATES:  
 OWNER:  
 PLAN CHECK:  
 C.T.A.



A-SECTION

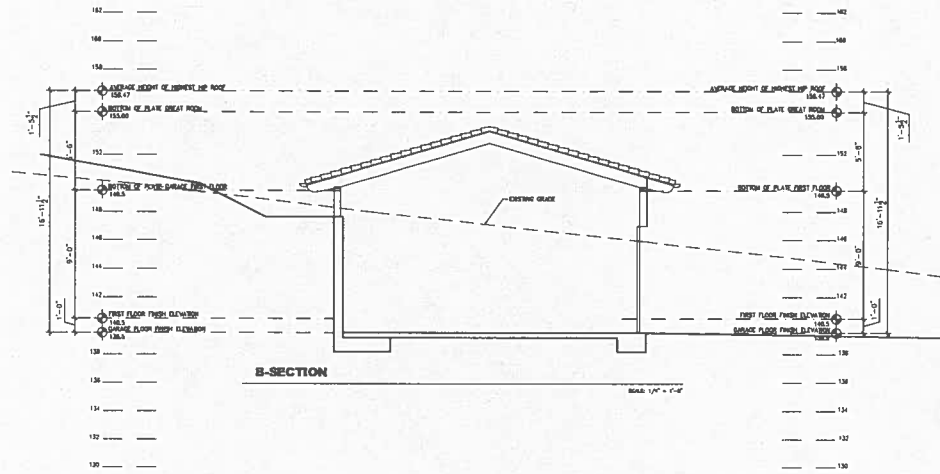Scale 1/4" = 1'-0"



B-SECTION

Scale 1/4" = 1'-0"

4	5	NO.	DATE
1	2	NO.	DATE


OWNER:	PLAN CHECK:	D.T.R.
--------	-------------	--------

DESIGNER:  
**IGNACIO RODRIGUEZ**  
 ARCHITECTS  
 8808 ALDEN AVE  
 ENGINO, CA 91316  
 P: 818.700.3333  
 F: 818.700.3334  
 www.ignacioproductions.com

NEW RESIDENCE FOR:  
**VINEET AND ANNETTE SHARMA**  
 8652 EL WORTH DRIVE  
 AGOURA, CA

JOB NO:	2014.41.01
DATE:	03/16/2016
DRAWN BY:	LR.
APPROVED BY:	I. R.

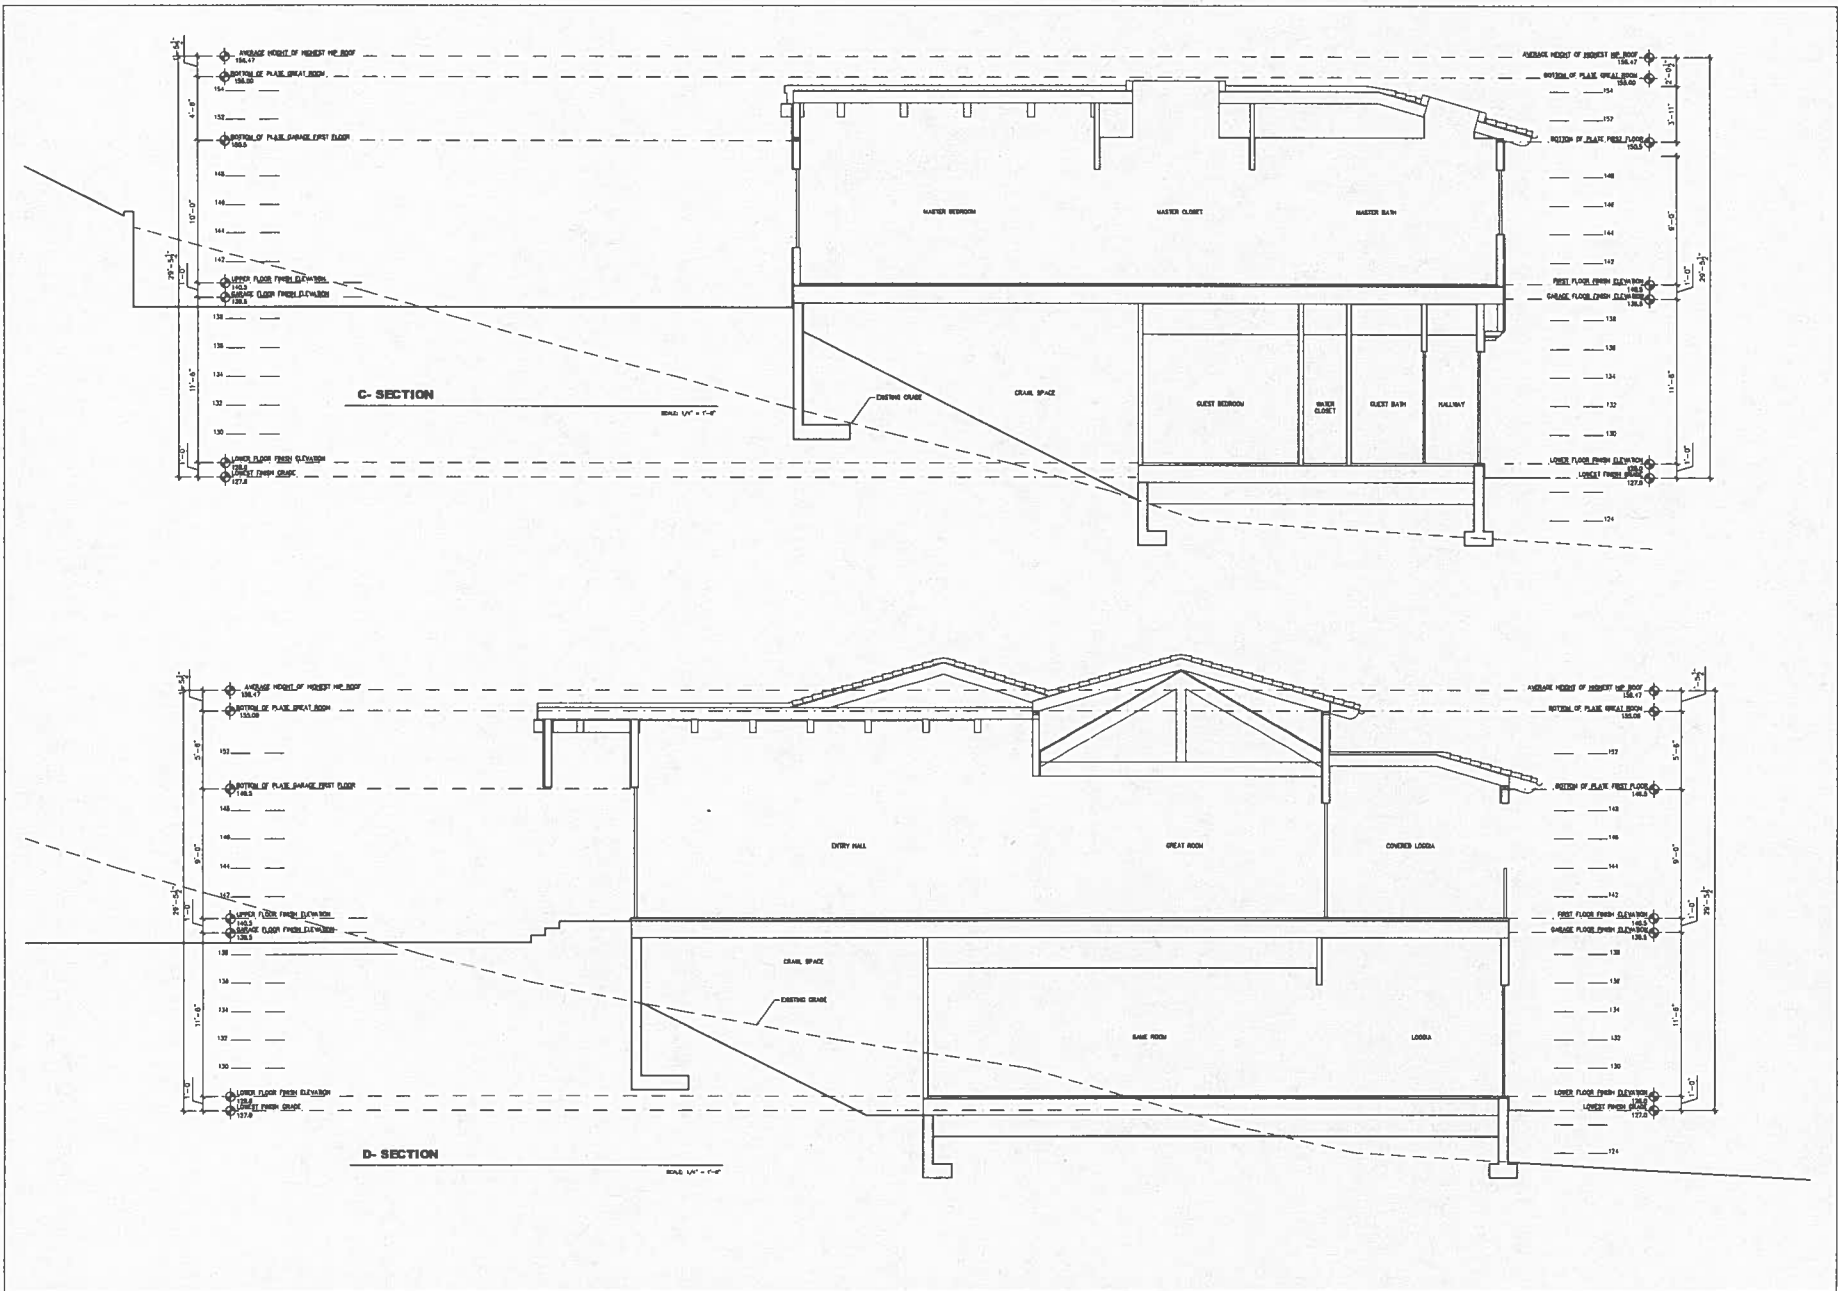SHEET TITLE: **SECTIONS**  
 SHEET NO: **A5.1**



REVISIONS	NO.	DATE
1	1	
2	2	
3	3	

OWNER:	PLANNER/CHECK:	C.I.T.L.

DESIGNER:  
**IGNACIO RODRIGUEZ**  
 ARCHITECTS  
 8880 ALDENA AVE.  
 ENGINO, CA 91316  
 PH: 626.440.8888  
 WWW.IGNACIOARCHITECTS.COM

**SECTIONS**

NEW RESIDENCE FOR:  
**VINEET AND ANNETTE SHARMA**  
 8025 ELK WORTH DRIVE  
 AGOURA, CA

JOB NO.:	2014.41.01
DATE:	03/16/2016
DRAWN BY:	LR.
APPROVED BY:	I.R.

SHEET NO.  
**A5.2**



**GRADING NOTES**

- ALL GRADING SHALL BE IN ACCORDANCE WITH ARTICLE 6 OF THE AGOURA HILLS MUNICIPAL CODE.
- A PRE-CONSTRUCTION CONFERENCE OF ALL INTERESTED PARTIES SHALL BE HELD PRIOR TO ANY CONSTRUCTION. THIS SHALL INCLUDE ALL APPROPRIATE CITY STAFF.
- ALL EXPORT MATERIAL SHALL BE DELIVERED TO A SITE APPROVED BY THE CITY.
- ALL GEOTECHNICAL AND SOIL RECOMMENDATIONS IMPOSED BY THE CONSULTANT OR CONTAINED IN THE CONSULTANT SOILS AND GEOLOGUE REPORT ARE TO BE COMPLETED WITH AND ARE HEREBY MADE AN INTEGRAL PART OF THE GRADING SPECIFICATIONS AND NOTES.
- ANY CHANGES IN THE WORK HEREON SHALL BE SUBJECT TO THE APPROVAL OF THE CITY ENGINEER.
- THE PERMITTEE SHALL EMPLOY A REGISTERED CIVIL ENGINEER TO PROVIDE CONSTANT ON-SITE GRADING SUPERVISION TO ASSURE COMPLIANCE WITH THE APPROVED PLANS AND A SOILS ENGINEER TO PROVIDE CONSTANT SOILS INSPECTION IN ACCORDANCE WITH THE AGOURA HILLS MUNICIPAL CODE.
- REPORTS REQUIRED:
  - ROUGH GRADING REPORT. PRIOR TO THE CONSTRUCTION OF ANY STRUCTURE, A ROUGH GRADING REPORT MUST BE SUBMITTED TO THE BUILDING OFFICE, STATING THAT ALL ROUGH GRADING HAS BEEN COMPLETED PER THE APPROVED GRADING PLANS.
  - FINAL GRADING REPORT. PRIOR TO THE FINALIZATION OF ANY GRADING PROJECT, A FINAL GRADING REPORT MUST BE SUBMITTED TO THE BUILDING OFFICE FOR APPROVAL. THE REPORT SHALL BE BY THE ENGINEER OF RECORD, STATING THAT ALL GRADING, LOT DRAINAGE AND DRAINAGE FACILITIES HAVE BEEN COMPLETED, AND THE DRAINAGE PLANS AND DRAINAGE SYSTEMS HAVE BEEN INSTALLED IN CONFORMANCE WITH THE APPROVED PLANS AND REQUIREMENTS OF THE CITY OF AGOURA HILLS.
  - AN AS-BUILT SOILS REPORT SHALL BE SUBMITTED TO THE CITY FOR REVIEW. THIS REPORT, PREPARED BY THE GEOTECHNICAL CONSULTANT, MUST INCLUDE DOCUMENTATION OF ANY FOUNDATION INSPECTIONS, THE RESULTS OF ALL COMPACTION TESTS, AS WELL AS A MAP DEPICTING THE LIMITS OF FILL, LOCATIONS OF ALL DENSITY TESTS, OUTLINE AND ELEVATIONS OF ALL RESUBSOIL BOTTOMS, KEYWAY LOCATIONS AND BOTTOM ELEVATIONS, LOCATIONS OF ALL SURBERMS AND FLOWING ELEVATIONS, AND LOCATION AND ELEVATION OF ALL RETAINING WALL BACKCOURSING AND OUTLETS. SOILS LOGS CONDITIONS EXPOSED DURING GRADING MUST BE DEPICTED ON AN AS-BUILT GEOLOGIC MAP.

**PUBLIC UTILITIES / SERVICES**

**WATER:** LAS VIRGENES MUNICIPAL WATER DISTRICT  
4222 LAS VIRGENES ROAD  
CALABASAS, CA 91302  
(818) 888-4111

**ELECTRICAL:** SOUTHERN CALIFORNIA Edison  
388 FOOTBALL DRIVE  
THOUSAND OAKS, CA 91321  
(805) 484-7616

**TELEPHONE:** BSC (PAC BELL)  
1225 RAYNER STREET, #115  
VAN NUYS, CA 91408  
(818) 373-8888

**Gas:** SOUTHERN CALIFORNIA GAS  
946 CANADALE AVENUE  
CHATEAUVORTH, CA 91313  
(818) 791-3324

**SEWER:** LA COUNTY, DEPT. OF PUBLIC WORKS  
SEWER MAINTENANCE DIVISION  
1685 S. FREEMONT AVENUE, BLDG 48 EAST  
ALHAMBRA, CA 91803  
(626) 388-3335

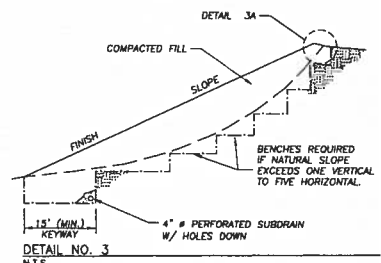
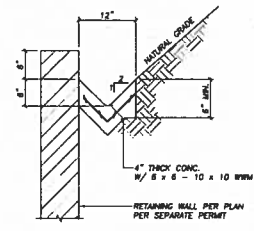
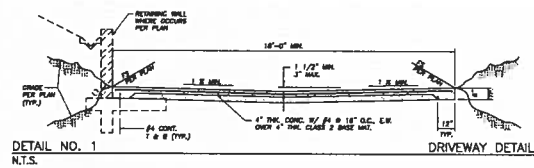
**CABLE:** ADOLPHUS  
3325 TELLER ROAD  
NEWBURY PARK, CA 91328  
(805) 484-7616

**CABLE:** CHARTER COMMUNICATIONS  
3888 CROSSCREEK ROAD  
MALIBU, CA 90255  
(310) 458-9111

**CALTRANS:** CALTRANS  
800 REDEDA BOULEVARD  
TARZANA, CA 91384  
(805) 388-1428

**STORMWATER POLLUTION NOTES**

- APPLICANT IS RESPONSIBLE FOR SUBMITTING A SITE-SPECIFIC, "STORM WATER POLLUTION PREVENTION PLAN" (SWPPP) AS OUTLINED IN THE MODEL PROGRAM FOR STORMWATER MANAGEMENT WITHIN THE COUNTY OF LOS ANGELES. THE SWPPP SHALL BE SIGNED AND STAMPED BY A STATE-LICENSED CIVIL ENGINEER. THE SWPPP SHALL OUTLINE "BEST MANAGEMENT PRACTICES" (BMP) PROCEDURES TO BE USED IN ORDER TO PREVENT THE TRANSPORT OF CRITICALLY POLLUTANTS TO OFF-SITE LOCATIONS DURING AND AFTER CONSTRUCTION.
- A SITE-SPECIFIC "WET-WEATHER EROSION-CONTROL PLAN" SHALL BE PREPARED IN CONJUNCTION WITH THE SWPPP, AND SHALL DESCRIBE BMPs TO BE USED DURING CONSTRUCTION IN THE RAINY SEASON AND DEPOT THEIR LOCATIONS RELATIVE TO THE SITE. THE PLAN MUST BE AVAILABLE ON-SITE BY OCTOBER 1ST, AND IMPLEMENTED FROM NOVEMBER 1ST THROUGH APRIL 15TH.
- IF IT IS THE PROPERTY OWNERS RESPONSIBILITY TO MAINTAIN ALL ON-SITE DRAINAGE STRUCTURES UNLESS OTHERWISE APPROVED BY THE CITY, CATCH BASIN FILTER INSERTS SHALL BE CLEANED OUT A MINIMUM OF TWICE PER YEAR, ONCE BEFORE THE RAINY SEASON, AND AGAIN AFTER THE RAINY SEASON, UNLESS OTHERWISE DIRECTED BY THE CITY ENGINEER.
- ERODED SEDIMENTS AND OTHER POLLUTANTS MUST BE RETAINED ON-SITE AND MAY NOT BE TRANSPORTED FROM THE SITE VIA SHEET FLOW, SWALES, AREA DRAINAGE, NATURAL DRAINAGE COURSE, OR RIVERS.
- STOCKPILES ON EARTH AND OTHER CONSTRUCTION-RELATED MATERIALS MUST BE PROTECTED FROM BEING TRANSPORTED FROM THE SITE BY THE FORCES OF WIND OR WATER.
- FUELS, OILS, SOLVENTS, AND OTHER TOXIC MATERIALS MUST BE STORED IN ACCORDANCE WITH THEIR LABELING AND ARE NOT TO CONTAMINATE THE SOIL AND SURFACE WATERS. ALL APPROVED STORAGE CONTAINERS ARE TO BE PROTECTED FROM THE WEATHER. SPILLS MUST BE CLEANED UP IMMEDIATELY AND DISPOSED OF IN A PROPER MANNER. SPILLS MAY NOT BE WASHED INTO THE DRAINAGE SYSTEM.
- EXCESS OR WASTE CONCRETE MAY NOT BE WASHED INTO THE PUBLIC RIGHT-OF-WAY OR ANY OTHER DRAINAGE SYSTEM. PROVIDERS SHALL BE MADE TO RETAIN CONCRETE WASTES ON-SITE UNTIL THEY CAN BE DISPOSED OF AS SOLID WASTE.
- TRASH AND CONSTRUCTION-RELATED SOLID WASTES MUST BE DEPOSITED INTO A COVERED RECEPTACLE TO PREVENT CONTAMINATION OF RAINWATER AND DISPERAL BY WIND.
- SEDIMENTS AND OTHER MATERIALS MAY NOT BE TRACKED FROM THE SITE BY VEHICLE TRAFFIC. THE CONSTRUCTION ENTRANCE ROADWAYS MUST BE STABILIZED SO AS TO INHIBIT SEDIMENTS FROM BEING DEPOSITED INTO THE PUBLIC RIGHT-OF-WAY. ACCIDENTAL DEPOSITIONS MUST BE SWEEP IMMEDIATELY AND MAY NOT BE WASHED DOWN BY RAIN OR OTHER MEANS.
- ANY SLOPES WITH DISTURBED SOILS OR DENUDING VEGETATION MUST BE STABILIZED AS TO INHIBIT EROSION BY WIND AND WATER.
- EXCEPT AS OTHERWISE DIRECTED BY THE CITY INSPECTOR, ALL DRAINAGE DEVICES SHOWN SHALL BE IN PLACE AT THE END OF EACH WORKING DAY WHEN THE FORECAST OF RAIN PROBABILITY IS 40% AND MAINTAINED DURING THE RAINY SEASON (NOVEMBER 1ST THROUGH APRIL 15TH OF THE SUCCEEDING YEAR) FOR EACH YEAR THE GRADING REMAINS INCOMPLETE. REFER TO SITE-SPECIFIC WET-WEATHER EROSION-CONTROL PLAN.
- CATCH BASIN FILTER INSERTS SHALL BE CLEANED OUT A MINIMUM OF TWICE PER YEAR, ONCE BEFORE THE RAINY SEASON, AND AGAIN AFTER THE RAINY SEASON, UNLESS OTHERWISE DIRECTED BY THE CITY ENGINEER.



**PUBLIC IMPROVEMENT NOTES**

- AN ENCROACHMENT PERMIT IS REQUIRED OF ALL WORK DONE IN THE PUBLIC RIGHT-OF-WAY ROW. ALL APPLICABLE FEES MUST BE PAID AND SECURITIES POSTED PRIOR TO ISSUANCE OF PERMIT. ALL WORK INVOLVING STREET IMPROVEMENTS REQUIRE APPROVAL FROM THE PUBLIC WORKS INSPECTOR. APPLICANTS SHALL ALLOW 48 HOURS ADVANCE NOTICE TO THE DEPARTMENT OF PUBLIC WORKS TO SCHEDULE ALL INSPECTIONS.
- A CONTRACTOR SHALL TELEPHONE UNDERGROUND SERVICE ALERT (USA) 1-800-422-4133 A MINIMUM OF 48 HOURS PRIOR TO START OF CONSTRUCTION.
- REQUIREMENTS FOR STREET STRUCTURE SETBACK TO BE DETERMINED BY SOIL ANALYSIS AND APPROVED BY THE CITY ENGINEER PRIOR TO PLACEMENT OF BASE MATERIALS.
- WATER SYSTEM SHALL BE CONSTRUCTED IN ACCORDANCE WITH LAS VIRGENES MUNICIPAL WATER DISTRICT WORKS MANUAL.
- SEPARATION OF WATER AND WASTEWATER LINES SHALL BE IN ACCORDANCE WITH LAS VIRGENES MUNICIPAL WATER DISTRICT.
- PRIOR TO CONSTRUCTION TO WATER AND SEWER MAINS IN THE PUBLIC RIGHT-OF-WAY, APPLICANT SHALL PROVIDE DOCUMENTATION FROM LAS VIRGENES MUNICIPAL WATER DISTRICT TO THE CITY STATING THAT ALL CONNECTION FEES HAVE BEEN PAID.
- CONTRACTOR IS RESPONSIBLE FOR PROTECTING ALL UTILITY LINES SHOWN ON THESE DRAWINGS. THE CONTRACTOR FURTHER ASSUMES ALL LIABILITY AND RESPONSIBILITY FOR THE UTILITY PIPES, CONDUITS, OR STRUCTURES SHOWN OR NOT SHOWN ON THESE DRAWINGS.

**OAK TREE NOTES**

- APPLICANT MUST CONTACT CITY OAK TREE CONSULTANT, (818) 897-7350, TO OBTAIN PROJECT SPECIFIC "OAK TREE NOTES."
- FOR OAK TREES EXISTING ON OR OFF-SITE OR IMMEDIATELY ADJACENT (WITHIN 100 FEET OF THE PROJECT BOUNDARIES) THE CONTRACTOR SHALL ARRANGE A MEETING WITH THE DEPARTMENT OF PLANNING AND COMMUNITY DEVELOPMENT PRIOR TO ANY WORK THAT FENCING AROUND OAK TREE PROTECTIVE ZONES SHALL BE PROVIDED, AND ALL CLEARING AND GRUBBING OF ORGANIC MATERIALS AND REMOVAL OF DEBRIS AND OTHER UNSUITABLE MATERIAL SHALL BE REMOVED FROM THE SITE AS STIPULATED UNDER THE OAK TREE PERMIT, BEFORE THE APPROVAL TO PROCEED WITH THE GRADING WILL BE ISSUED. AFTER NOTIFICATION THAT THIS STAGE HAS BEEN COMPLETED, THE SITE WILL BE INSPECTED BY THE CITY'S OAK TREE ADMINISTRATOR. WHEN APPROVED, THE APPROVAL TO PROCEED WILL BE ISSUED IN WRITING BY THE DEPARTMENT OF PLANNING AND COMMUNITY DEVELOPMENT.
- ALL OAK TREE WORK SHALL BE DONE IN ACCORDANCE WITH THE CITY OF AGOURA HILLS TREE ORDINANCE AND OAK TREE PRESERVATION AND PROTECTION GUIDELINES.
- UNDER NO CIRCUMSTANCES SHALL ANY WORK BE DONE WITHIN THE PROTECTED ZONE OF ANY OAK TREE, WITHOUT OBTAINING AN OAK TREE ENCROACHMENT PERMIT AND 48 HOURS ADVANCE NOTICE TO THE CITY. FURTHERMORE, PROTECTIVE FENCING SHALL BE RELOCATED OR MOVED WITHOUT CITY APPROVAL.

**SURVEY ABBREVIATIONS APN: 2055 - 022 - 091**

AC - ASPHALTIC CONCRETE  
BF - BOTTOM OF FOOTING  
CB - CATCH BASIN  
CF - CURB FACE  
C - CENTERLINE  
CL - CHAIN LINK FENCE  
CO - CLEAN OUT  
CS - DEBRIS BASIN  
DL - DAYLIGHT  
EG - EDGE OF GUTTER  
EP - EDGE OF PAVEMENT  
FF - FINISHED FLOOR  
FG - FINISHED GRADE  
FH - FIRE HYDRANT  
FL - FLOOR LINE  
FS - FINISH SURFACE  
HC RAMP - HANDICAP RAMP  
HP - HIGH POINT  
INV - INVERT  
NG - NATURAL GROUND  
NTE - NOT TO SCALE  
PL - PROPERTY LINE  
P - POINT OF BEGINNING  
RDWH - STORM DRAIN MANHOLE  
BSW - SEWER MANHOLE  
BS - BENT ANY SEWER  
TB - TOP OF BEAM  
TC - TOP OF CURB  
TF - TOP OF FOOTING  
TO - TOP OF GRADE  
TH - THICKNESS  
TYP - TYPICAL  
W - WATER MASTER  
WV - WATER VALVE

**AVERAGE SLOPE ANALYSIS**

FORMULA:  $\frac{B \times 100}{A}$      $\frac{B=100 \times 1.58}{4341.25}$      $\frac{B=100 \times 1.58}{4341.25}$      $\frac{B=100 \times 1.58}{4341.25}$

INDEX OF DRAWINGS	
SHEET NO.	DESCRIPTION
1	COVER SHEET
2	TOPOGRAPHIC SURVEY
3	GRADING & DRAINAGE PLAN
4	CROSS SECTIONS & DETAILS
5	EROSION CONTROL COVER SHEET
6	EROSION CONTROL PLAN SHEET
7	EROSION CONTROL ATTACHMENTS

**ESTIMATED EARTHWORK QUANTITIES**

ESTIMATED CUT:	808 CY	ESTIMATED EXPORT:	0 CY
ESTIMATED FILL:	1117 CY	ESTIMATED IMPORT:	212 CY
ESTIMATED OVER-EXCAVATION:	0 CY	SHRINKAGE BE 2.5 IN 1 CY	

**BENCHMARK:**  
DESCRIPTION: BM NO. Y-19424    ELEVATION: 841.03    SURVEY DATE: MAY 2013

**RECORD DRAWING STATEMENT**

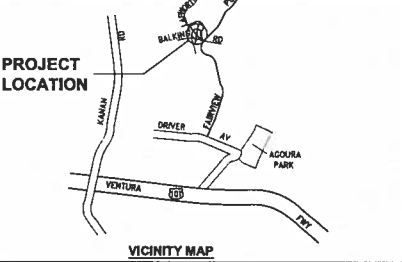
I, LEONARD LITTON, HEREBY CERTIFY, BASED ON MY FIELD OBSERVATION AND INFORMATION PROVIDED BY THE OWNER AND GENERAL CONTRACTOR, THAT THE WORK ON SHEET NOS. 1 THROUGH 7, MARKED AS "RECORD DRAWING" HAS BEEN CONSTRUCTED IN SUBSTANTIAL COMPLIANCE WITH THESE PLANS, SPECIFICATIONS, REVISIONS, CHANGE ORDERS, AND FIELD CHANGES.

REGISTERED CIVIL ENGINEER	DATE	3182	RCE NO.	EXP. DATE
REGISTERED GEOLOGIST <td>DATE</td> <td>SEE REC.</td> <td>EXP. DATE</td> <td></td>	DATE	SEE REC.	EXP. DATE	
REGISTERED GEOTECHNICAL ENGINEER	DATE	SEE REC.	EXP. DATE	

**SOILS APPROVAL**

THIS PLAN HAS BEEN REVIEWED, AND IS IN CONFORMANCE WITH THE RECOMMENDATIONS IN OUR REPORT(S) DATED: \_\_\_\_\_

OWNER	
NAME:	VINEET AND ANNETTE SHARMA
ADDRESS:	29617 CANWOOD STREET, AGOURA HILLS, CA 91301
REPRESENTATIVE:	VINEET SHARMA
TELEPHONE:	(310) 987-1204
CIVIL ENGINEER	
NAME:	LC ENGINEERING GROUP, INC.
ADDRESS:	889 FRENCH COURT, SUITE 101, THOUSAND OAKS, CA 91320
REPRESENTATIVE:	LEONARD LITTON
TELEPHONE:	(805) 487-1464 (310) 895-7148
GEOTECHNICAL ENGINEER	
NAME:	CALWEST GEOTECHNICAL
ADDRESS:	388 FRENCH COURT, SUITE 101, THOUSAND OAKS, CA 91320
REPRESENTATIVE:	LEONARD LITTON
TELEPHONE:	(805) 487-1464 (310) 895-7148




**INSPECTION NOTES**

THE PERMITTEE OR HIS AGENT SHALL NOTIFY THE BUILDING AND SAFETY DEPARTMENT AT LEAST TWO WORKING DAYS IN ADVANCE OF REQUIRED INSPECTIONS AT THE FOLLOWING STAGES OF WORK:

- WHEN THE SITE HAS BEEN CLEARED OF VEGETATION AND UNAPPROVED FILL HAS BEEN SCRAPED, BENCHED, OR OTHERWISE PREPARED FOR FILL. FILL SHALL NOT HAVE BEEN PLACED PRIOR TO THIS INSPECTION.
- ROUGH: WHEN APPROVED FINAL ELEVATIONS HAVE BEEN ESTABLISHED; DRAINAGE TERRACES, SWALES AND BERMS INSTALLED AT THE TOP OF SLOPE; AND THE STAKEMENTS REQUIRED IN THIS SECTION HAVE BEEN RECEIVED.
- FINAL: WHEN GRADING HAS BEEN COMPLETED; ALL DRAINAGE DEVICES INSTALLED; SLOPE BENCHES AND RECORD DRAWINGS (AS-BUILT PLANS), REQUIRED STATEMENTS, AND REPORTS HAVE BEEN SUBMITTED.

ALL REQUIRED REPORTS AND STATEMENTS TO THE BUILDING AND SAFETY DEPARTMENT SHALL BE PREPARED IN ACCORDANCE WITH SECTIONS 7028 AND 7021 OF THE BUILDING CODE.

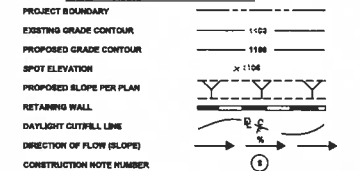**LEGEND AND SYMBOLS**



**BASIS OF BEARING**

THE BASIS OF BEARINGS FOR THIS SURVEY IS THE CENTERLINE BEARING ON REDE DRIVE OF S1+01.00°W AS SHOWN ON THE MAP OF TRACT NO. 8761, S.B. 118-809A.

**LEGAL DESCRIPTION:**

THE LAND REFERRED TO HEREIN IS SITUATED IN THE COUNTY OF LOS ANGELES, STATE OF CALIFORNIA, AND IS DESCRIBED AS FOLLOWS:

**BENCHMARK:**  
E.A. NO. Y-19424    NAVD 1988    COUNTY OF LOS ANGELES DATUM  
POINT ON BM TAG IN 1/8" x 3/8" x 5/8" B.C. OR AGOURA RD & LAMAR LA PLANTE DR.  
ELEVATION = 841.03 FEET    (ADJUSTMENT OF 2008)

**UNDERGROUND SERVICE ALERT**

CALL TOLL FREE  
1-800-227-2800

TWO WORKING DAYS BEFORE YOU DIG

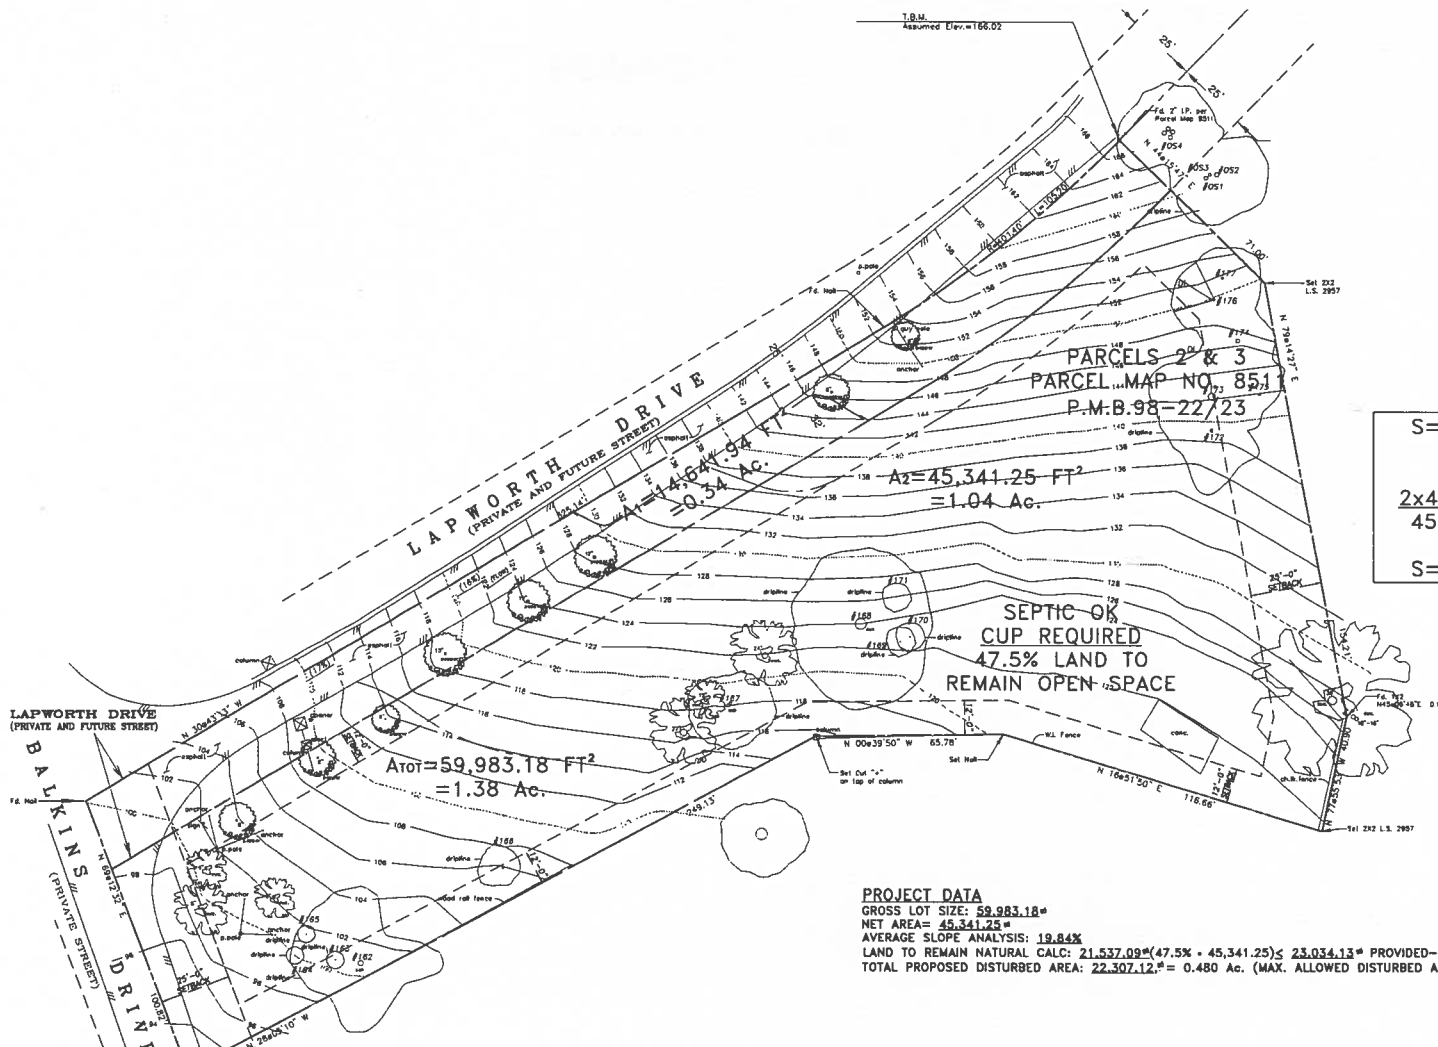
REV	SYMBOL	DESCRIPTION OF CHANGE	RCE	DATE	PROJECT ENGINEER	RCE 52258	DATE

**CITY OF AGOURA HILLS APPROVAL**

REVIEWED BY	DATE	6885	3/30/14	EXP. DATE
REVIEWED BY	DATE	6885	3/30/14	EXP. DATE

**COVER SHEET**  
5952 LAPWORTH DR.  
AGOURA HILLS, CA. 91301

PROJECT NO. \_\_\_\_\_ SHEET \_\_\_\_\_ OF \_\_\_\_\_



S=1Lx100  
A  
2x4499x100  
45,341.25  
S=19.84%

**PROJECT DATA**  
 GROSS LOT SIZE: 59,983.18#  
 NET AREA: 45,341.25#  
 AVERAGE SLOPE ANALYSIS: 19.84%  
 LAND TO REMAIN NATURAL CALC: 21,537.09#(47.5% + 45,341.25) ≤ 23,034.13# PROVIDED-"OK"-50.8%  
 TOTAL PROPOSED DISTURBED AREA: 22,307.12# = 0.480 Ac. (MAX. ALLOWED DISTURBED AREA: 23,804.16#)=49.2% "OK"

A<sub>TOT</sub> = 59,983.18 FT<sup>2</sup>  
= 1.38 Ac.

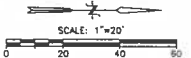
A<sub>Z</sub> = 45,341.25 FT<sup>2</sup>  
= 1.04 Ac.

A<sub>1</sub> = 14,574.94 FT<sup>2</sup>  
= 0.34 Ac.

PARCELS 2 & 3  
 PARCEL MAP NO. 851  
 P.M.B. 98-22723

SEPTIC OK  
 CUP REQUIRED  
 47.5% LAND TO  
 REMAIN OPEN SPACE


**UNDERGROUND SERVICE ALERT**  
 CALL TOLL FREE  
 1-800-227-2600  
 TWO WORKING DAYS BEFORE YOU DIG




				PREPARED BY: <b>LC ENGINEERING GROUP, INC.</b> <small>REGISTERED PROFESSIONAL ENGINEERS          CIVIL ENGINEERS</small>		CITY OF AGOURA HILLS APPROVAL		<b>AGOURA HILLS</b>		<b>SLOPE ANALYSIS AND TOPOGRAPHIC SURVEY</b> 5952 LAPWORTH DR. AGOURA HILLS, CA. 91301	
REV	SYMBOL	DESCRIPTION OF CHANGE	RCE	DATE	PROJECT ENGINEER	DATE	PROJECT NO.	SHEET 2 OF 7			

**ADDITIONAL NOTES:**

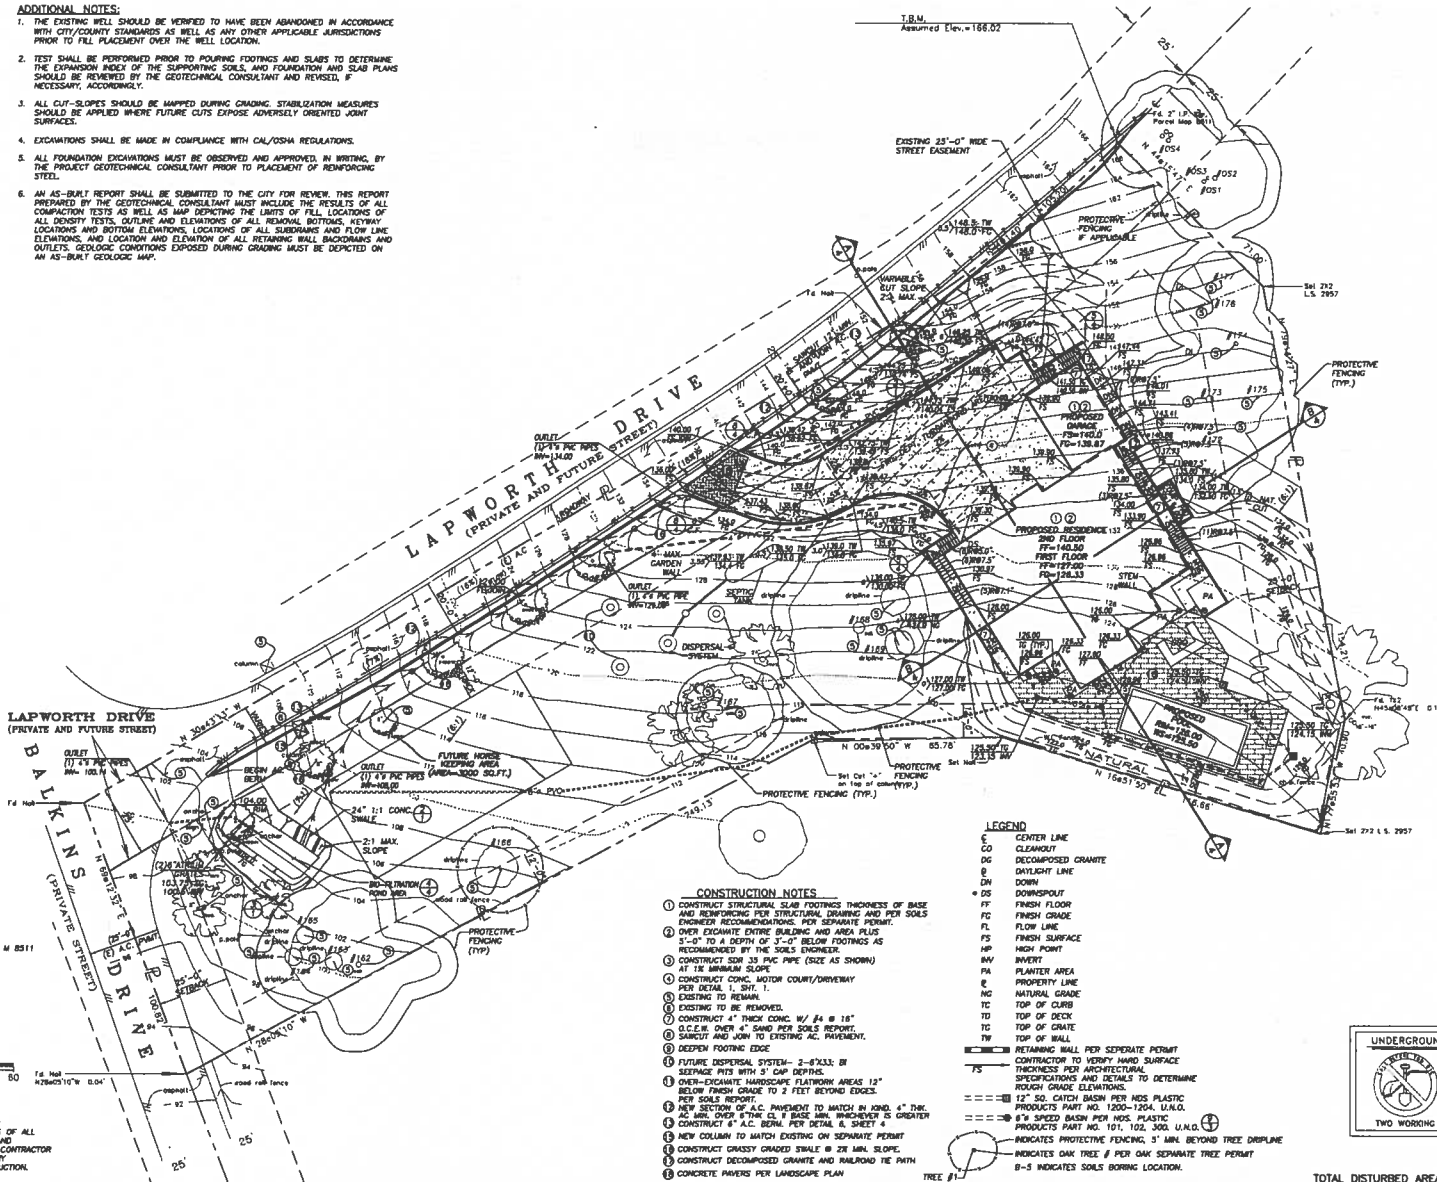1. THE EXISTING WELL SHOULD BE VERIFIED TO HAVE BEEN ABANDONED IN ACCORDANCE WITH CITY/COUNTY STANDARDS AS WELL AS ANY OTHER APPLICABLE JURISDICTIONS PRIOR TO FILL PLACEMENT OVER THE WELL LOCATION.
2. TEST SHALL BE PERFORMED PRIOR TO POURING FOOTINGS AND SLABS TO DETERMINE THE EXPANSION INDEX OF THE SUPPORTING SOILS. FOUNDATION AND SLAB PLANS SHOULD BE REVIEWED BY THE GEOTECHNICAL CONSULTANT AND REVISOR, IF NECESSARY, ACCORDINGLY.
3. ALL CUT-SLOPES SHOULD BE MAPPED DURING GRADING. STABILIZATION MEASURES SHOULD BE APPLIED WHERE FUTURE CUTS EXPOSE ADVERSELY ORIENTED JOINT SURFACES.
4. EXCAVATIONS SHALL BE MADE IN COMPLIANCE WITH CAL/OSHA REGULATIONS.
5. ALL FOUNDATION EXCAVATIONS MUST BE OBSERVED AND APPROVED, IN WRITING, BY THE PROJECT GEOTECHNICAL CONSULTANT PRIOR TO PLACEMENT OF REINFORCING STEEL.
6. AN AS-BUILT REPORT SHALL BE SUBMITTED TO THE CITY FOR REVIEW. THIS REPORT PREPARED BY THE GEOTECHNICAL CONSULTANT MUST INCLUDE THE RESULTS OF ALL COMPACTION TESTS AS WELL AS MAP DEPICTING THE LIMITS OF FILL, LOCATIONS OF ALL DENSITY TESTS, OUTLINE AND ELEVATIONS OF ALL REMOVAL BOTTOMS, KEYWAY LOCATIONS AND BOTTOM ELEVATIONS, LOCATIONS OF ALL SUBDRAINS AND FLOW LINE ELEVATIONS, AND LOCATION AND ELEVATION OF ALL RETAINING WALL BACKINGS AND OUTLETS. GEOLOGIC CONDITIONS EXPOSED DURING GRADING MUST BE DEPICTED ON AN AS-BUILT GEOLOGIC MAP.



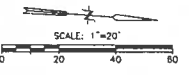**LEGAL DESCRIPTION:**  
 PORTION OF LOT 2 AND LOT 3 OF 10 W 8511  
 NO. 86, 22/23  
 APN # 2055-022-091



**NOTE TO CONTRACTOR**  
 CONTRACTOR TO VERIFY THE LOCATIONS OF ALL PROPOSED STRUCTURES, ELEVATIONS, AND DIMENSIONS PRIOR TO CONSTRUCTION. CONTRACTOR TO CONTACT PROJECT ENGINEER OF ANY DISCREPANCIES PRIOR TO ANY CONSTRUCTION.

- CONSTRUCTION NOTES**
1. CONSTRUCT STRUCTURAL SLAB FOOTINGS THICKNESS OF BASE AND REINFORCING PER STRUCTURAL DRAWING AND PER SOILS ENGINEER RECOMMENDATIONS. PER SEPARATE PERMIT.
  2. OVER EXCAVATE ENTIRE BUILDING AND AREA PLUS 5'-0" TO A DEPTH OF 3'-0" BELOW FOOTINGS AS RECOMMENDED BY THE SOILS ENGINEER.
  3. CONSTRUCT 24" DIA. PVC PIPE (SIZE AS SHOWN) AT 1% MINIMUM SLOPE.
  4. CONSTRUCT CONC. MOTOR COURT/DRIVEWAY PER DETAIL 1, SHEET 1.
  5. EXISTING TO BE REMOVED.
  6. EXISTING TO BE REMOVED.
  7. CONSTRUCT 4" THICK CONC. W/ #4 @ 18" O.C. OVER 4" SAND PER SOILS REPORT.
  8. SANDWICH AND JOIN TO EXISTING AC. PAVEMENT.
  9. DEEPEN FOOTING EDGE.
  10. FUTURE DISPOSAL SYSTEM - 2'-0" DIA. BY SEPTIC PITS WITH 3' CAP DEPTH.
  11. OVER-EXCAVATE HARDSCAPE PLATFORM AREAS 12" BELOW FINISH GRADE TO 2 FEET BEYOND EDGES PER SOILS REPORT.
  12. NEW SECTION OF A.C. PAVEMENT TO MATCH BY 1000' 4" DIA. AC. MIN. OVER 6" THICK CL. 8 BASE MIN. MIN. SLOPE IS GREATER.
  13. CONSTRUCT 8" A.C. SEWER PER DETAIL A, SHEET 4.
  14. NEW COLUMN TO MATCH EXISTING ON SEPARATE PERMIT.
  15. CONSTRUCT GRASSY GRADED SWALE @ 2% MIN. SLOPE.
  16. CONSTRUCT DECOMPOSED GRANITE AND RAILROAD TIE WITH CONCRETE PAVERS PER LANDSCAPE PLAN.

- LEGEND**
- E CENTER LINE
  - CO CLEANOUT
  - DG DECOMPOSED GRANITE
  - B DAYLIGHT LINE
  - DN DOWN
  - DS DOWNSPOUT
  - FF FRESH FLOOR
  - FG FINISH GRADE
  - FL FLOW LINE
  - FS FRESH SURFACE
  - HP HIGH POINT
  - INV INVERT
  - PA PLANTER AREA
  - PL PROPERTY LINE
  - NC NATURAL GRADE
  - TC TOP OF CURB
  - TD TOP OF DECK
  - TO TOP OF GRADE
  - TW TOP OF WALL
  - RS RETAINING WALL PER SEPARATE PERMIT
  - CONTRACTOR TO VERIFY HARD SURFACE THICKNESS PER ARCHITECTURAL SPECIFICATIONS AND DETAILS TO DETERMINE ROUGH GRADE ELEVATIONS.
  - 12" 50' CATCH BASIN PER MSS PLASTIC PRODUCTS PART NO. 1200-1204, U.A.G.O.
  - 6" 5' SPEED BASIN PER MSS PLASTIC PRODUCTS PART NO. 101, 102, 300, U.A.G.O.
  - INDICATES PROTECTIVE FENCING, 3' MIN. BEYOND TREE OVERLINE
  - INDICATES OAK TREE # PER OAK SEPARATE TREE PERMIT
  - 8-5 INDICATES SOILS BORING LOCATION

**UNDERGROUND SERVICE ALERT**

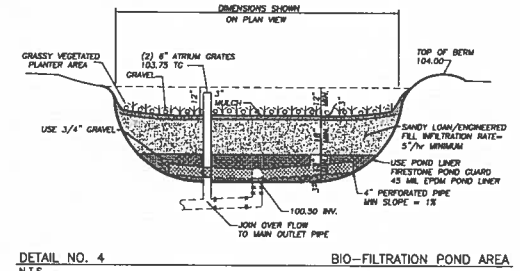
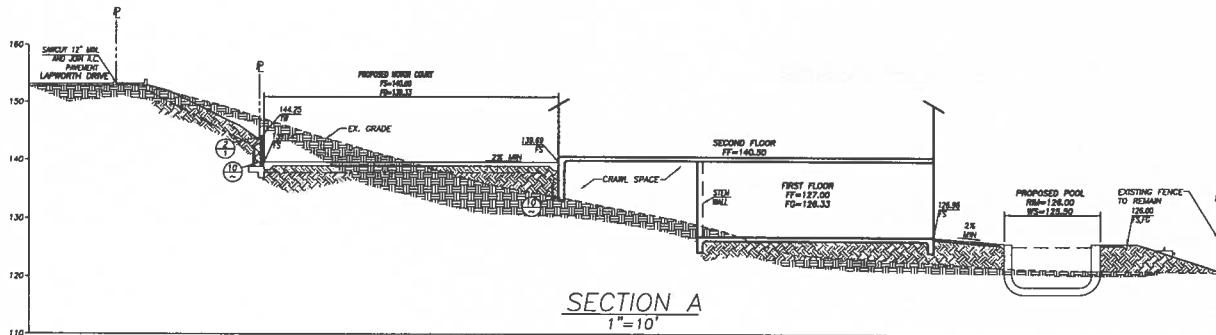
CALL TOLL FREE  
 1-800-227-2400

TWO WORKING DAYS BEFORE YOU DIG



TOTAL DISTURBED AREA: 22307.12 SQ. FT. (0.512 Ac.)

PREPARED BY: <b>LC ENGINEERING GROUP, INC.</b>				CITY OF AGOURA HILLS APPROVAL			
PROJECT ENGINEER: 62258 RCE DATE:				REVIEWED BY: DATE: RAMIRO S. ADEVA III CITY ENGINEER DATE: 08/03/08 TREE NO: EXP. DATE:			
REV	SYMBOL	DESCRIPTION OF CHANGE	RCE	DATE	CITY OF AGOURA HILLS		
					<b>GRADING AND DRAINAGE PLAN</b> 5952 LAPWORTH DR. AGOURA HILLS, CA. 91301		
					SHEET 3 OF 7		



**CHANNEL-SLOPE®**  
NW100 Series Channels  
Sloped Channels

Slope  
Each channel has a 2% built-in slope. There are 28 different slope channels (noted on 1-28).








Length  
Each channel is 20.37 ft. (6.21 m) long. Total length of part numbers 1-28 combined is 468.42 feet (143.7 m).

Width Depth Range Cross Section Range  
Channel depth at end of channel is 4 in. at end of channel Part No. 28 and 30 in. at end of channel Part No. 29.



Depth At End of Each Channel

Part No.	Depth	Part No.	Depth	Part No.	Depth	Part No.	Depth
100-1	20	100-11	10	100-21	10	100-31	10
100-2	22	100-12	12	100-22	12	100-32	12
100-3	24	100-13	13	100-23	13	100-33	13
100-4	26	100-14	14	100-24	14	100-34	14
100-5	28	100-15	15	100-25	15	100-35	15
100-6	30	100-16	16	100-26	16	100-36	16
100-7	32	100-17	17	100-27	17	100-37	17
100-8	34	100-18	18	100-28	18	100-38	18
100-9	36	100-19	19	100-29	19	100-39	19
100-10	38	100-20	20	100-30	20	100-40	20
100-11	40	100-21	21	100-31	21	100-41	21
100-12	42	100-22	22	100-32	22	100-42	22
100-13	44	100-23	23	100-33	23	100-43	23
100-14	46	100-24	24	100-34	24	100-44	24
100-15	48	100-25	25	100-35	25	100-45	25
100-16	50	100-26	26	100-36	26	100-46	26
100-17	52	100-27	27	100-37	27	100-47	27
100-18	54	100-28	28	100-38	28	100-48	28
100-19	56	100-29	29	100-39	29	100-49	29
100-20	58	100-30	30	100-40	30	100-50	30

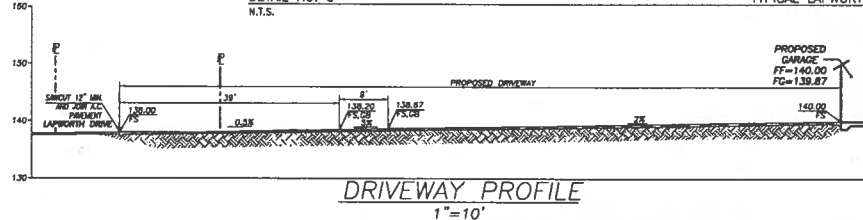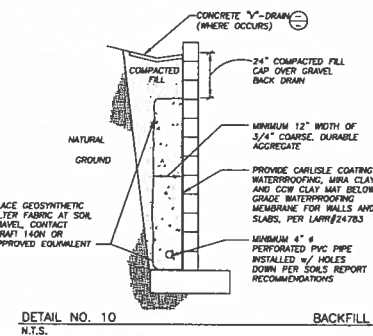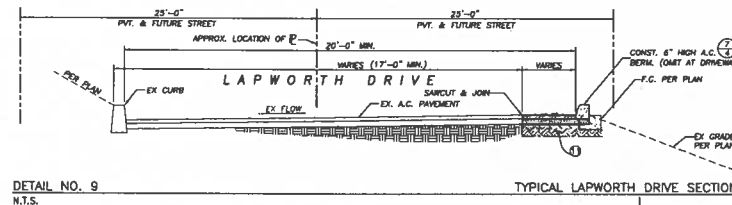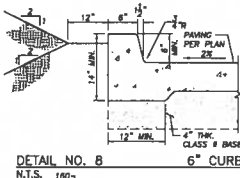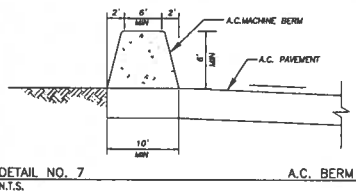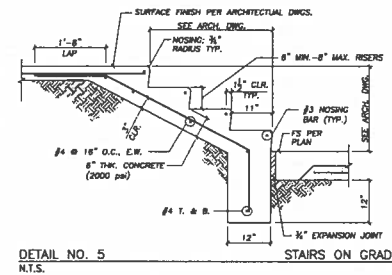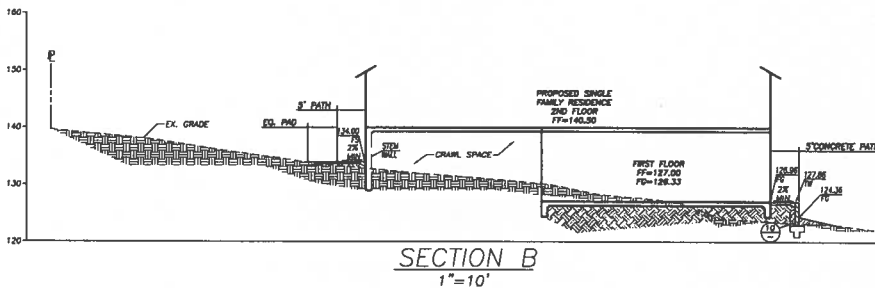

**UNDERGROUND SERVICE ALERT**  
CALL TOLL FREE 1-800-227-2400  
TWO WORKING DAYS BEFORE YOU DIG



PREPARED BY:  
**LC ENGINEERING GROUP, INC.**  
PROJECT ENGINEER: S2258  
DATE:

CITY OF AGOURA HILLS APPROVAL

REVIEWED BY: DATE:

RAMIRO A. ADEVA III  
CITY ENGINEER



**SECTIONS & DETAILS**  
5952 LAPWORTH DR.  
AGOURA HILLS, CA. 91301


PROJECT NO. SHEET 4 OF 7

REV	SYMBOL	DESCRIPTION OF CHANGE	RCE	DATE



**NOTES:**

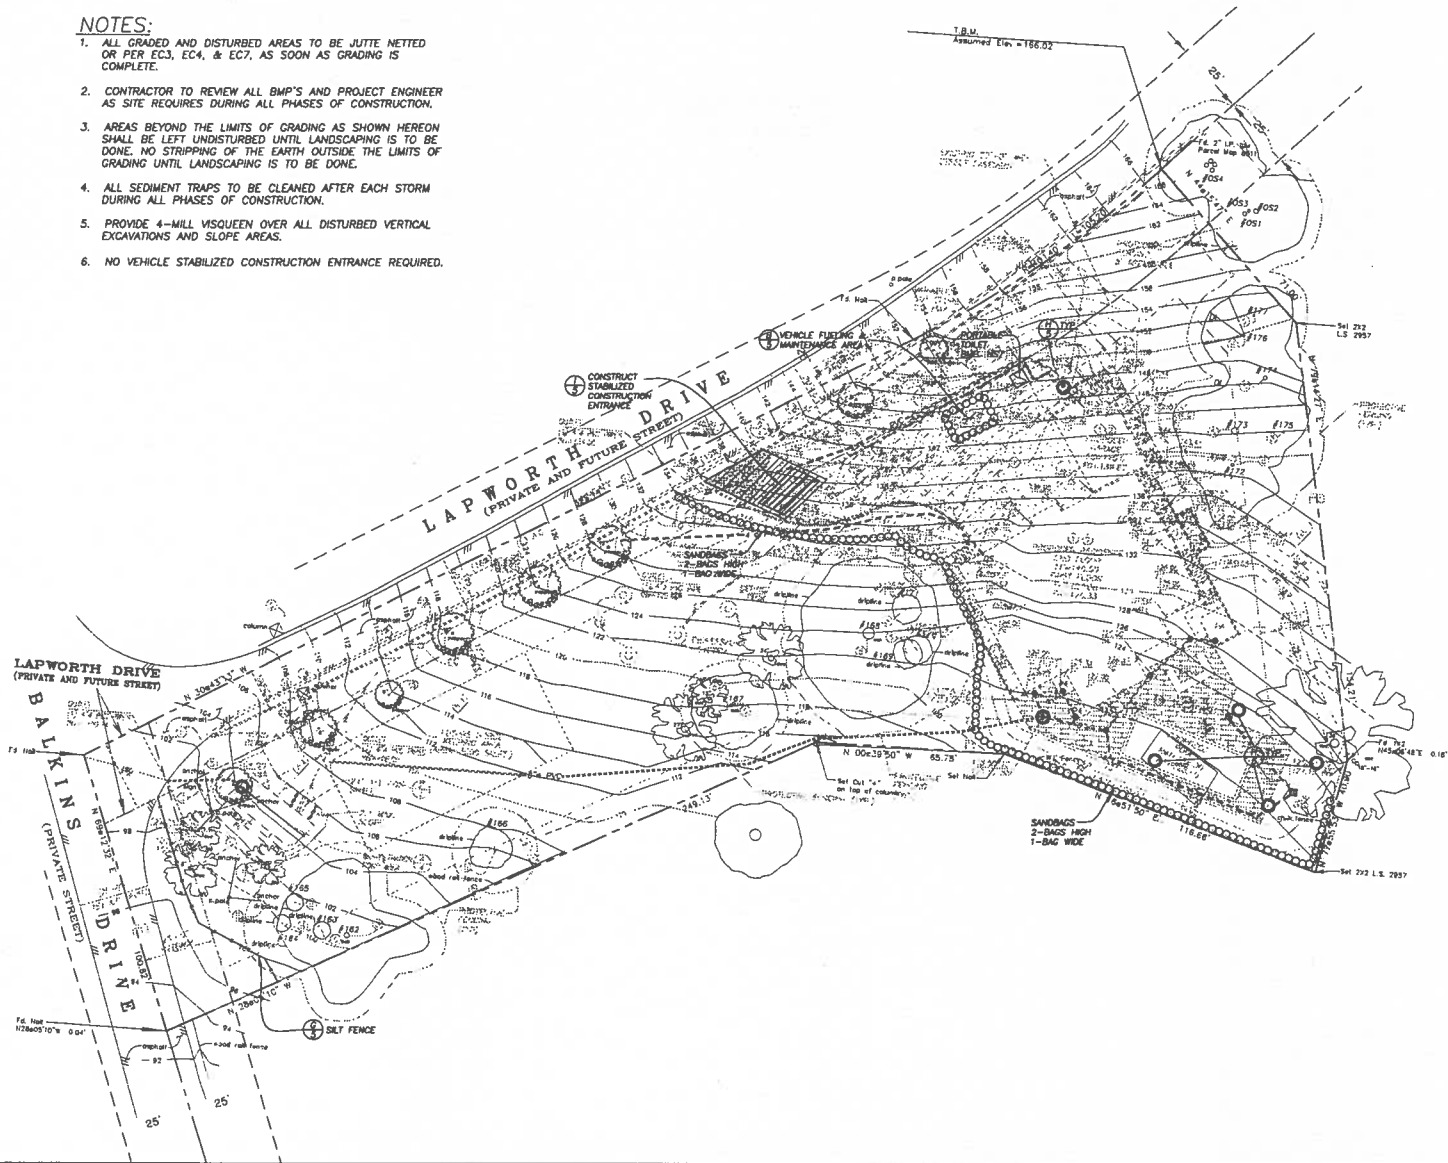1. ALL GRADED AND DISTURBED AREAS TO BE JUTTE NETTED OR PER EC3, EC4, & EC7, AS SOON AS GRADING IS COMPLETE.
2. CONTRACTOR TO REVIEW ALL BMP'S AND PROJECT ENGINEER AS SITE REQUIRES DURING ALL PHASES OF CONSTRUCTION.
3. AREAS BEYOND THE LIMITS OF GRADING AS SHOWN HEREON SHALL BE LEFT UNDISTURBED UNTIL LANDSCAPING IS TO BE DONE. NO STRIPPING OF THE EARTH OUTSIDE THE LIMITS OF GRADING UNTIL LANDSCAPING IS TO BE DONE.
4. ALL SEDIMENT TRAPS TO BE CLEANED AFTER EACH STORM DURING ALL PHASES OF CONSTRUCTION.
5. PROVIDE 4-MILL VISQUEEN OVER ALL DISTURBED VERTICAL EXCAVATIONS AND SLOPE AREAS.
6. NO VEHICLE STABILIZED CONSTRUCTION ENTRANCE REQUIRED.



SCALE: 1"=20'

0 20 40 60

REV	SYMBOL	DESCRIPTION OF CHANGE	RCE	DATE

PREPARED BY:  
**LC ENGINEERING GROUP, INC.**  
 PROJECT ENGINEER: C. 52258  
 RCE: DATE

CITY OF AGOURA HILLS APPROVAL

REVIEWED BY: DATE

RAMIRO S. ADEVA III  
 CITY ENGINEER

DATE: 08/05  
 RCE NO.: EXP. DATE



**EROSION CONTROL PLAN**  
 5952 LAPWORTH DR.  
 AGOURA HILLS, CA. 91301

PROJECT NO. \_\_\_\_\_ SHEET 6 OF 7

**SWPPP BMP SELECTION**

**Table 3.2 Temporary Erosion Control BMPs**

CADA Fact Sheet	BMP Name	Meets a Minimum Requirement?	BMP Used		If not used, state reason
			YES	NO	
EC-1	Scheduling	X			
EC-2	Prevention of Picking Vegetation	X			
EC-3	Hydraulic Erosion		X		N/A
EC-4	Strawmat	X	X		N/A
EC-5	Silt Binders		X		N/A
EC-6	Sewer Mats		X		N/A
EC-7	Construction and Maintenance	X	X		N/A
EC-8	Wind Shields	X	X		N/A
EC-9	Earth Dike and Drainage Swales		X		N/A
EC-10	Velocity Dissipation Devices		X		N/A
EC-11	Slope Erosion		X		N/A
EC-12	Reverse Bank Stabilization		X		N/A
EC-13	Check Dam		X		N/A
EC-14	Check Dam		X		N/A
EC-15	Soil Preparation/Amending		X		N/A
EC-16	Vegetation Stabilization		X		N/A
EC-17	Wind Erosion Control	X			

Alternate BMPs Used: \_\_\_\_\_ If used, state reason: \_\_\_\_\_  
 1) Applicability to a specific project shall be determined by the QSD.  
 2) The QSD shall ensure implementation of use of the minimum measures listed or a combination thereof to achieve and maintain the Risk Level requirement.  
 3) Reason for not being used shall be derived from: areas of disturbed areas, diversion of ditches, areas may require, demonstrated by a licensed civil engineer and/or additional environmental permitting.

**Table 3.3 Temporary Sediment Control BMPs**

CADA Fact Sheet	BMP Name	Meets a Minimum Requirement?	BMP used		If not used, state reason
			YES	NO	
SE-1	Silt Fence		X		N/A
SE-2	Sediment Basin		X		N/A
SE-3	Sediment Trap		X		N/A
SE-4	Check Dam		X		N/A
SE-5	Filter Cloth		X		N/A
SE-6	Grass Strip Barrier		X		N/A
SE-7	Sewer Sweeping		X		N/A
SE-8	Sandbag Barrier		X		N/A
SE-9	Storm Water Inlet Protection		X		N/A
SE-10	Storm Drain Inlet Protection		X		N/A
SE-11	A15		X		N/A
SE-12	Temporary Silt Dike		X		N/A
SE-13	Concrete Sock and Flare		X		N/A
SE-14	Rebar Wall		X		N/A
SE-15	Shrubland Construction Entrance and Exit		X		N/A
SE-16	Stabilized Construction Entrance		X		N/A
SE-17	Steeper Under Tire Wash		X		N/A

Alternate BMPs Used: \_\_\_\_\_ If used, state reason: \_\_\_\_\_  
 1) Applicability to a specific project shall be determined by the QSD.  
 2) The QSD shall ensure implementation of use of the minimum measures listed or a combination thereof to achieve and maintain the Risk Level requirement.  
 3) Risk Level 2.3.3 shall provide for the required control along line of slope, face of slope, and at the grade levels of equal slope.

**Table 3.4 Temporary Non-Stormwater BMPs**

CADA Fact Sheet	BMP Name	Meets a Minimum Requirement?	BMP used		If not used, state reason
			YES	NO	
NS-1	Water Conservation Practices	X			
NS-2	Demolition Operation		X		N/A
NS-3	Paving and Grading Operation	X			
NS-4	Temporary Stream Crossing		X		N/A
NS-5	Clear Water Operation		X		N/A
NS-6	Block Connection (Legal Discharge Connection)		X		N/A
NS-7	Possible Water Irrigation Discharge Disruption		X		N/A
NS-8	Vehicle and Equipment Cleaning	X			
NS-9	Vehicle and Equipment Traffic	X			
NS-10	Vehicle and Equipment Maintenance	X			
NS-11	Pile Driving Operation		X		N/A
NS-12	Concrete Curing		X		
NS-13	Concrete Finishing		X		
NS-14	Metal and Equipment Use Over Water		X		N/A
NS-15	Domestic Animal Adjacent to Water		X		N/A
NS-16	Temporary Beach Phase		X		N/A

Alternate BMPs Used: \_\_\_\_\_ If used, state reason: \_\_\_\_\_  
 1) Applicability to a specific project shall be determined by the QSD.

**Table 3.4 Temporary Non-Stormwater BMPs**

CADA Fact Sheet	BMP Name	Meets a Minimum Requirement?	BMP used		If not used, state reason
			YES	NO	
NS-1	Water Conservation Practices	X			
NS-2	Demolition Operation		X		N/A
NS-3	Paving and Grading Operation	X			
NS-4	Temporary Stream Crossing		X		N/A
NS-5	Clear Water Operation		X		N/A
NS-6	Block Connection (Legal Discharge Connection)		X		N/A
NS-7	Possible Water Irrigation Discharge Disruption		X		N/A
NS-8	Vehicle and Equipment Cleaning	X			
NS-9	Vehicle and Equipment Traffic	X			
NS-10	Vehicle and Equipment Maintenance	X			
NS-11	Pile Driving Operation		X		N/A
NS-12	Concrete Curing		X		
NS-13	Concrete Finishing		X		
NS-14	Metal and Equipment Use Over Water		X		N/A
NS-15	Domestic Animal Adjacent to Water		X		N/A
NS-16	Temporary Beach Phase		X		N/A

Alternate BMPs Used: \_\_\_\_\_ If used, state reason: \_\_\_\_\_  
 1) Applicability to a specific project shall be determined by the QSD.

**Table 3.5 Temporary Materials Management BMPs**

CADA Fact Sheet	BMP Name	Meets a Minimum Requirement?	BMP used		If not used, state reason
			YES	NO	
WM-01	Material Delivery and Storage		X		
WM-02	Material Use		X		
WM-03	Stockpile Management		X		
WM-04	Spill Prevention and Control		X		
WM-05	Solid Waste Management		X		
WM-06	Hazardous Waste Management		X		
WM-07	Contaminated Soil Management		X		N/A
WM-08	Construction Waste Management		X		
WM-09	Sanitary-Swale Waste Management		X		
WM-10	Liquid Waste Management		X		

Alternate BMPs Used: \_\_\_\_\_ If used, state reason: \_\_\_\_\_  
 1) Applicability to a specific project shall be determined by the QSD.

JOB ADDRESS: 5952 LAPWORTH DRIVE PERMIT #:

**STORMWATER DEVELOPMENT CONSTRUCTION PROGRAM  
 PRIORITY PROJECTS  
 CERTIFICATION STATEMENT**

AS THE OWNER OR AUTHORIZED AGENT OF THE OWNER, I CERTIFY THAT THE APPROXIMATE BMP'S WILL BE IMPLEMENTED IS EFFECTIVELY MINIMIZE THE NEGATIVE IMPACTS OF THIS PROJECT'S CONSTRUCTION ACTIVITIES ON STORM WATER QUALITY. THE PROJECT CONTRACTOR IS AWARE THAT THE SELECTED BMP'S MUST BE INSTALLED, MONITORED, AND MAINTAINED TO ENSURE THEIR EFFECTIVENESS. THE BMP'S NOT SELECTED FOR IMPLEMENTATION ARE REDUNDANT OR DEEMED NOT APPLICABLE TO THE PROPOSED CONSTRUCTION ACTIVITIES.

COMPLETED FORM TO BE ATTACHED TO THE LOCAL STORM WATER POLLUTION PREVENTION PLAN.

PRINT NAME: \_\_\_\_\_  
 (OWNER OR AUTHORIZED AGENT OF THE OWNER)

SIGNATURE: \_\_\_\_\_ DATE: \_\_\_\_\_  
 (OWNER OR AUTHORIZED AGENT OF THE OWNER)

JOB ADDRESS: 5952 LAPWORTH DRIVE PERMIT #:

**DEPARTMENT OF BUILDING AND SAFETY  
 MINIMUM REQUIREMENTS FOR CONSTRUCTION PROJECTS/  
 CERTIFICATION STATEMENT**

THE FOLLOWING IS INTENDED AS AN ATTACHMENT TO THE CONSTRUCTION/GRADING PLANS AND REPRESENT THE MINIMUM STANDARDS OF GOOD HOUSEKEEPING WHICH MUST BE IMPLEMENTED ON ALL SITES CLASSIFIED AS DEVELOPMENT CONSTRUCTION PROJECTS.

DEVELOPMENT CONSTRUCTION PROJECTS ARE DEFINED AS PROJECTS WHERE THERE IS LESS THAN TWO ACRES OF DISTURBED SOIL, NOT LOCATED IN DESIGNATED HILLSIDE AREAS, AND NOT ON OR ADJACENT TO AN ENVIRONMENTAL SENSITIVE AREA. NOTE: A PROJECT IN A DESIGNATED HILLSIDE AREA WITH LESS THAN TWO ACRES OF DISTURBED SOIL AND NOT IN OR ADJACENT TO AN ENVIRONMENTAL SENSITIVE AREA MAY BE CLASSIFIED AS A DEVELOPMENT CONSTRUCTION PROJECT IF THE GRADING PRE-INSPECTION (GPI) IS NOT REQUIRED OR THE ENTIRE LOT HAS A SLOPE OF TEN PERCENT OR LESS.

- ERODED SEDIMENTS AND OTHER POLLUTANTS MUST BE RETAINED ONSITE AND MAY NOT BE TRANSPORTED FROM THE SITE VIA SHEETFLOW, SWALES, AREA DRAINS, NATURAL DRAINAGE COURSE, OR WIND.
- STOCKPILES OF EARTH AND OTHER CONSTRUCTION-RELATED MATERIALS MUST BE PROTECTED FROM BEING TRANSPORTED FROM THE SITE BY WIND OR WATER.
- FUELS, OILS, SOLVENTS, AND OTHER TOXIC MATERIALS MUST BE STORED IN ACCORDANCE WITH THEIR LISTING AND ARE NOT TO CONTAMINATE THE SOIL NOR THE SURFACE WATERS. ALL APPROVED STORAGE CONTAINERS ARE TO BE PROTECTED FROM THE WEATHER. SPILLS MUST BE CLEANED UP IMMEDIATELY AND DISPOSED OF IN A PROPER MANNER. SPILLS MAY NOT BE WASHED INTO THE DRAINAGE SYSTEM.
- EXCESS OR WASTE CONCRETE MAY NOT BE WASHED INTO THE PUBLIC WAY OR ANY OTHER DRAINAGE SYSTEM. PROVISIONS SHALL BE MADE TO RETAIN CONCRETE WASTES ONSITE UNTIL THEY CAN BE DISPOSED OF AS SOLID WASTE.
- TRASH AND CONSTRUCTION-RELATED SOLID WASTES MUST BE DEPOSITED INTO A COVERED RECEPTACLE TO PREVENT CONTAMINATION OF RAINWATER AND DISPERSAL BY WIND.



#	REVISIONS	DATE	GRADING PLAN PREPARED BY:	CITY OF AGOURA HILLS
			<b>LC ENGINEERING GROUP, INC.</b>	EROSION CONTROL ATTACHMENTS
			REGISTERED ENGINEER NO. 32258 DATE	5952 LAPWORTH DRIVE
			CHECKED BY / DATE	10/8-0-14
				SHEET 7 OF 7



**CUT / FILL LEGEND:**

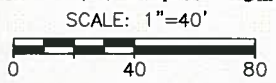
CUT		-10' TO -5'
		-5' TO -2'
		-2' TO -1'
		-1' TO 0'
FILL		0' TO 1'
		1' TO 2'
		2' TO 4'
		4' TO 8'

**EARTHWORK QUANTITIES**

CUT/FILL:  
 CUT: 906 CU. YDS. FILL: 1,117 CU. YDS.  
 EXPORT: 0 CU. YDS. IMPORT: 212 CU. YDS.

**EARTHWORK EXHIBIT**  
 FOR  
**5952 LAPWORTH DR.**  
**AGOURA HILLS, CA. 91301**

**LC ENGINEERING GROUP, INC.**  
 CONSULTING ENGINEERS  
 888 Pierce Court, Suite 101, Thousand Oaks, California 91380  
 (805) 497-1244 (818) 091-7148 FAX: (818) 091-5942 Email: [workfiles@lcegroupinc.com](mailto:workfiles@lcegroupinc.com)





# Cut/Fill Report

**Generated:** 2015-06-24 16:13:42  
**By user:** Edward Raysinger  
**Drawing:** X:\LCE GROUP\Civil\JOBS\6800\6858  
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 SHARMA\CIVIL\DWG\XREF\6858 SITE PLAN C3D.dwg

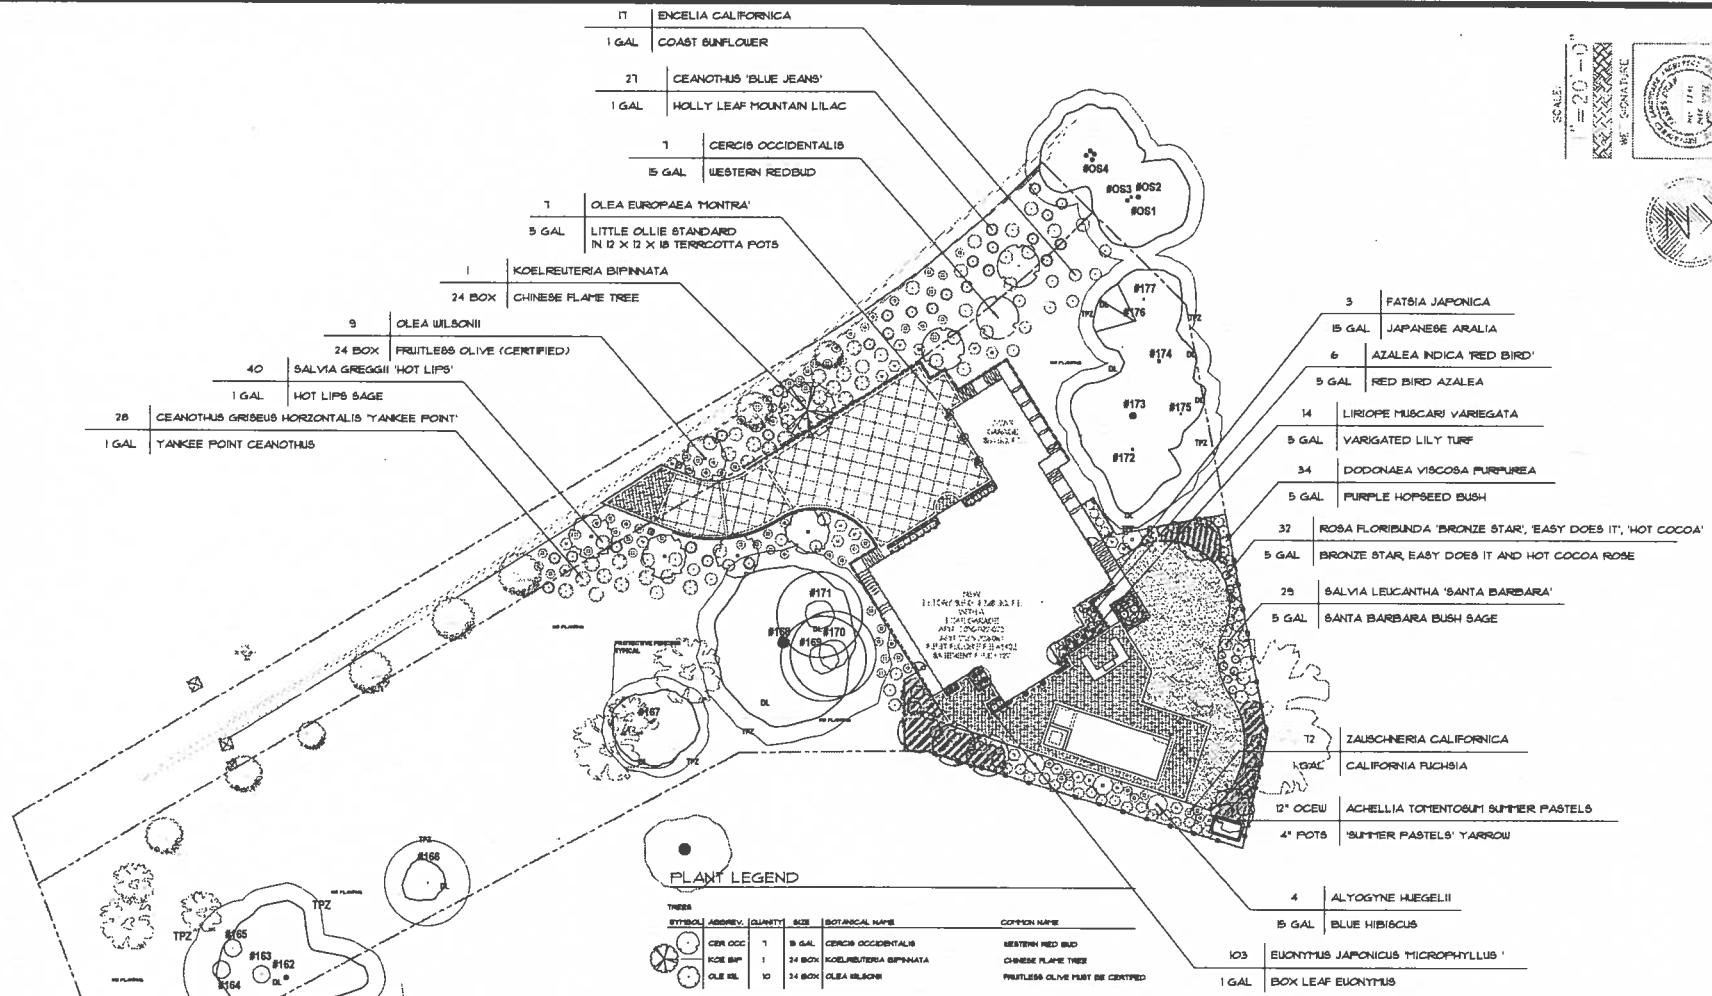
Volume Summary							
Name	Type	Cut Factor	Fill Factor	2d Area (Sq. Ft.)	Cut (Cu. Yd.)	Fill (Cu. Yd.)	Net (Cu. Yd.)
6858 proposed volume	full	1.000	1.150	21568.42	906	1117*	212*

Totals				
	2d Area (Sq. Ft.)	Cut (Cu. Yd.)	Fill (Cu. Yd.)	Net (Cu. Yd.)
Total	21568.42	906	1117*	212*

\* Value adjusted by cut or fill factor other than 1.0

# L2 LANDSCAPE

**SHARMA RESIDENCE**  
 5952 LAFWORTH DRIVE AGOURA HILLS, CA. 91301  
 APN# 2055-022-013, 2055-022-091



- 11 ENCELIA CALIFORNICA  
1 GAL COAST SUNFLOWER
- 27 CEANOTHUS 'BLUE JEANS'  
1 GAL HOLLY LEAF MOUNTAIN LILAC
- 1 CERCIS OCCIDENTALIS  
5 GAL WESTERN REDBUD
- 1 OLEA EUROPAEA 'MONTRA'  
3 GAL LITTLE OLLIE STANDARD  
IN 12 X 12 X 18 TERRACOTTA POTS
- 1 KOELREUTERIA BIPINNATA  
24 BOX CHINESE FLAME TREE
- 9 OLEA WILSONII  
24 BOX FRUITLESS OLIVE (CERTIFIED)
- 40 SALVIA GREGGII 'HOT LIPS'  
1 GAL HOT LIPS SAGE
- 28 CEANOTHUS GRISBEUS HORIZONTALIS 'YANKEE POINT'  
1 GAL YANKEE POINT CEANOTHUS

- 3 FATSIA JAPONICA
- 15 GAL JAPANESE ARALIA
- 6 AZALEA INDICA 'RED BIRD'  
9 GAL RED BIRD AZALEA
- 14 LIRIOPE MUSCARI VARIEGATA  
5 GAL VARIGATED LILY TURF
- 34 DODONAEA VISCOSA PURPUREA  
5 GAL PURPLE HOPSEED BUSH
- 32 ROSA FLORIBUNDA 'BRONZE STAR', 'EASY DOES IT', 'HOT COCOA'  
5 GAL BRONZE STAR, EASY DOES IT AND HOT COCOA ROSE
- 29 SALVIA LEUCANTHA 'SANTA BARBARA'  
5 GAL SANTA BARBARA BUSH SAGE
- 12 ZALUSCHNERIA CALIFORNICA  
1 GAL CALIFORNIA RUCHSIA
- 12' OCEU ACHILLIA TOMENTOSUM 'SUMMER PASTELS'  
4' POTS 'SUMMER PASTELS' 'YARROW'
- 4 ALTYOGYNE HUEGELII  
15 GAL BLUE HIBISCUS
- 103 EUONYMUS JAPONICUS 'MICROPHYLLUS'  
1 GAL BOX LEAF EUONYMUS

### PLANT LEGEND

SYMBOL	ABBREV.	QUANTITY	SIZE	BOTANICAL NAME	COMMON NAME
(Symbol)	CER OCC	1	5 GAL	CERCIS OCCIDENTALIS	WESTERN RED BUD
(Symbol)	KOE BP	1	34 BOX	KOELREUTERIA BIPINNATA	CHINESE FLAME TREE
(Symbol)	OLE WIL	10	34 BOX	OLEA WILSONII	FRUITLESS OLIVE MUST BE CERTIFIED

SYMBOL	ABBREV.	QUANTITY	SIZE	BOTANICAL NAME	COMMON NAME
(Symbol)	ACH PNT	2	4' POTS	ACHILLIA TOMENTOSUM 'SUMMER PASTELS'	'SUMMER PASTELS' 'YARROW'
(Symbol)	ALY HIB	5	15 GAL	ALTYOGYNE HUEGELII	BLUE HIBISCUS
(Symbol)	AZA RED	6	9 GAL	AZALEA HYBRID 'RED BIRD'	RED BIRD AZALEA
(Symbol)	CEA YAN	28	1 GAL	CEANOTHUS G. HORIZ. 'YANKEE POINT'	YANKEE POINT CEANOTHUS
(Symbol)	CEA HLL	26	1 GAL	CEANOTHUS 'BLUE JEANS'	HOLLY LEAF MOUNTAIN LILAC
(Symbol)	DOD PUR	34	5 GAL	DODONAEA VISCOSA PURPUREA	PURPLE HOPSEED BUSH
(Symbol)	ENC CAL	11	1 GAL	ENCELIA CALIFORNICA	COAST SUNFLOWER
(Symbol)	EUO MIC	103	1 GAL	EUONYMUS JAPONICUS 'MICROPHYLLUS'	BOX LEAF EUONYMUS
(Symbol)	FAT JAP	3	5 GAL	FATSIA JAPONICA	JAPANESE ARALIA
(Symbol)	LIR VAR	14	1 GAL	LIRIOPE 'MUSCARI VARIEGATA'	VARIGATED LILY TURF
(Symbol)	OLE MON	14	1 GAL	OLEA EUROPAEA 'MONTRA'	LITTLE OLLIE STANDARD 'TOPARY' IN 12 X 12 X 18 TERRACOTTA POTS
(Symbol)	ROS BRN	32	5 GAL	ROSA FLORIBUNDA 'BRONZE STAR', 'HOT COCOA', 'EASY DOES IT'	BRONZE STAR, HOT COCOA ROSE AND EASY DOES IT ROSE
(Symbol)	SAL HOT	40	1 GAL	SALVIA GREGGII 'HOT LIPS'	HOT LIPS SAGE
(Symbol)	SAL SAN	29	5 GAL	SALVIA LEUCANTHA 'SANTA BARBARA'	SANTA BARBARA BUSH SAGE
(Symbol)	ZAU CAL	12	1 GAL	ZALUSCHNERIA CALIFORNICA	CALIFORNIA RUCHSIA

**GROUND COVER NOTE:**  
 ALL PLANTED AREAS TO RECEIVE PRAGERIA CHLOEAS PLANTED AT 1" OC.

**ADDITIONAL NOTES:**  
 ALL PLANTED AREAS ARE TO BE AMENDED WITH DRIVING COPPOIT AT A DEPTH OF 4" DEEP FOR SOIL SOIL. EXCEPT: EXCEPTION NO AMENDMENT OF SLOPE AREAS. ALL PLANTER AREA TO RECEIVE 1" OF FRESH BANK MULCH.

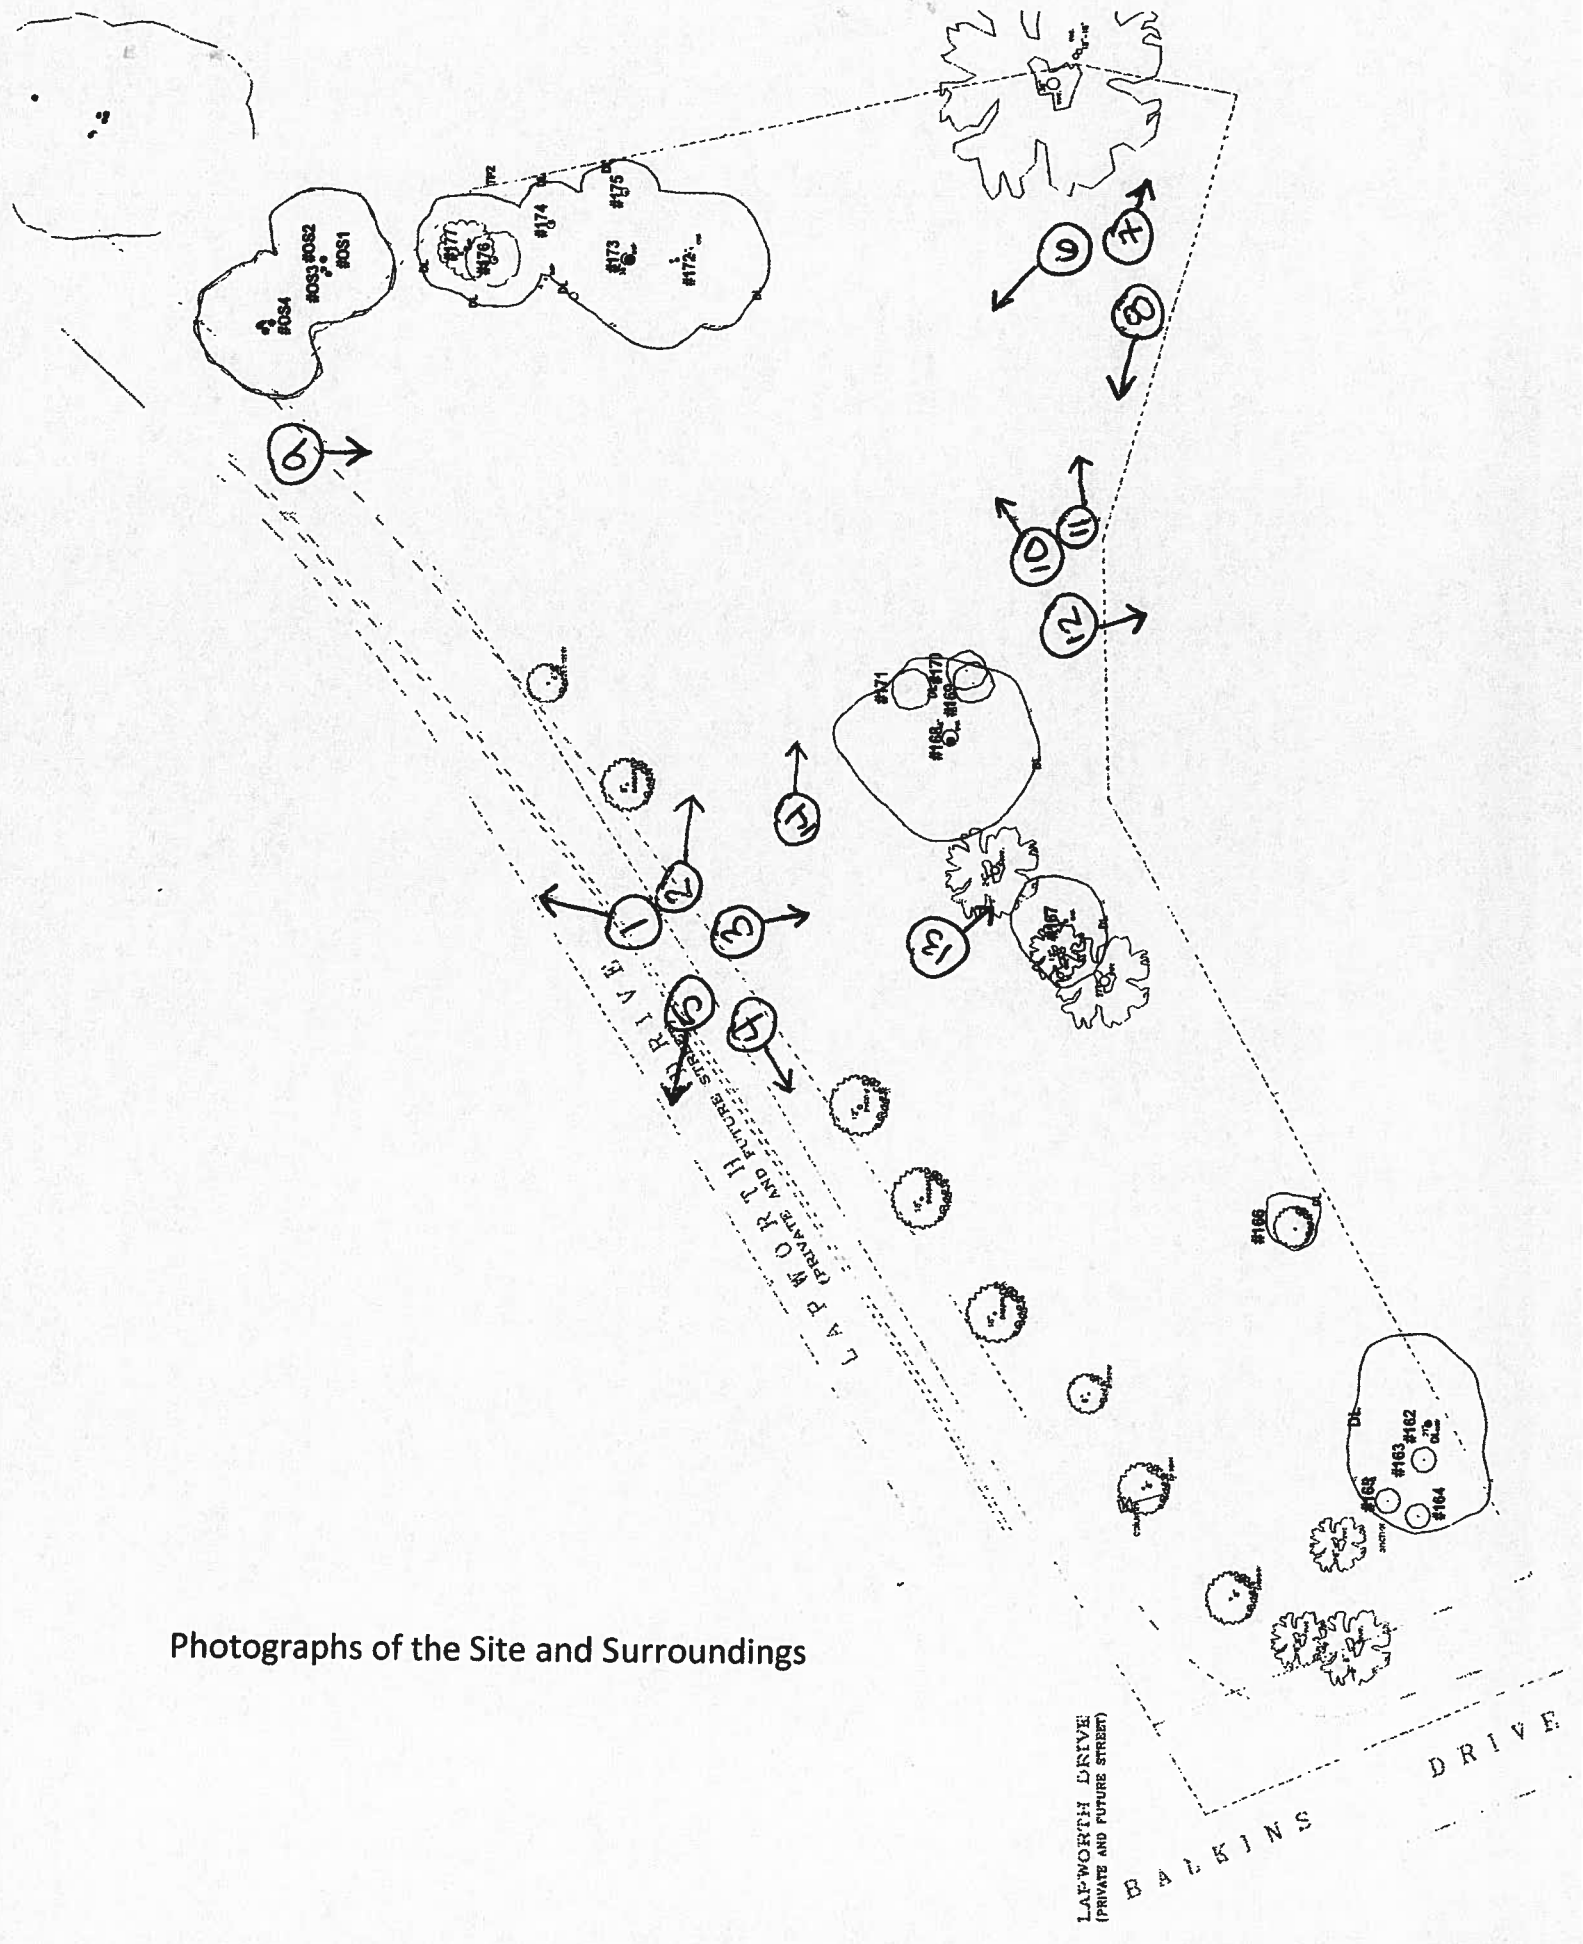
**IRRIGATION NOTE:**  
 ALL LASH AND PLANTER AREAS ARE TO BE IRRIGATED WITH AN AUTOMATIC SPRINKLER SYSTEM. THE SYSTEM MUST HAVE A MAIN ARBOR, LOW FLOW SPRAY HEADS AND DRAIN LINES IN LEVEL PLANTER AREAS.

**OLWYN KINGERY**  
 LANDSCAPE DESIGN  
 1938 THOUSAND OAKS BLVD SUITE B  
 THOUSAND OAKS, CALIFORNIA 91362  
 805.219.9119 VOICE


DATE: 7/2/15  
 REVISIONS:  
 PRINT DATE:

## SHARMA L2 LANDSCAPE PLAN





Photographs of the Site and Surroundings

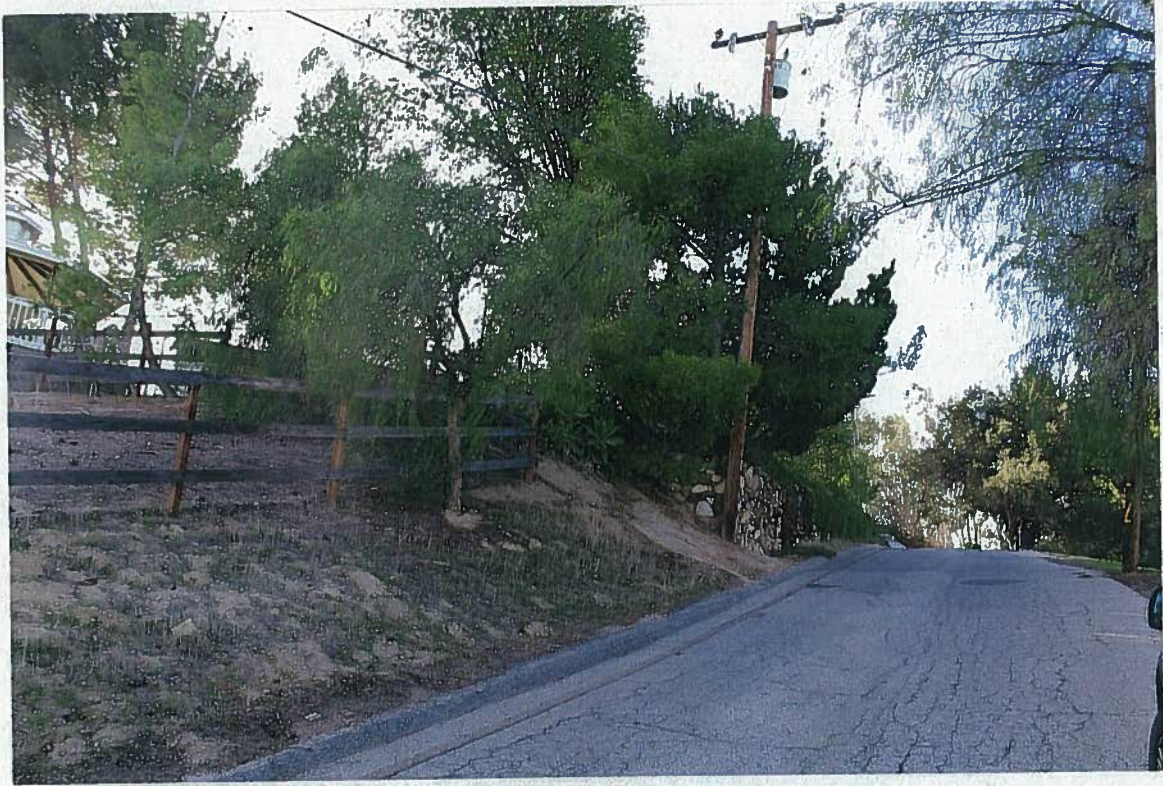


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(11)


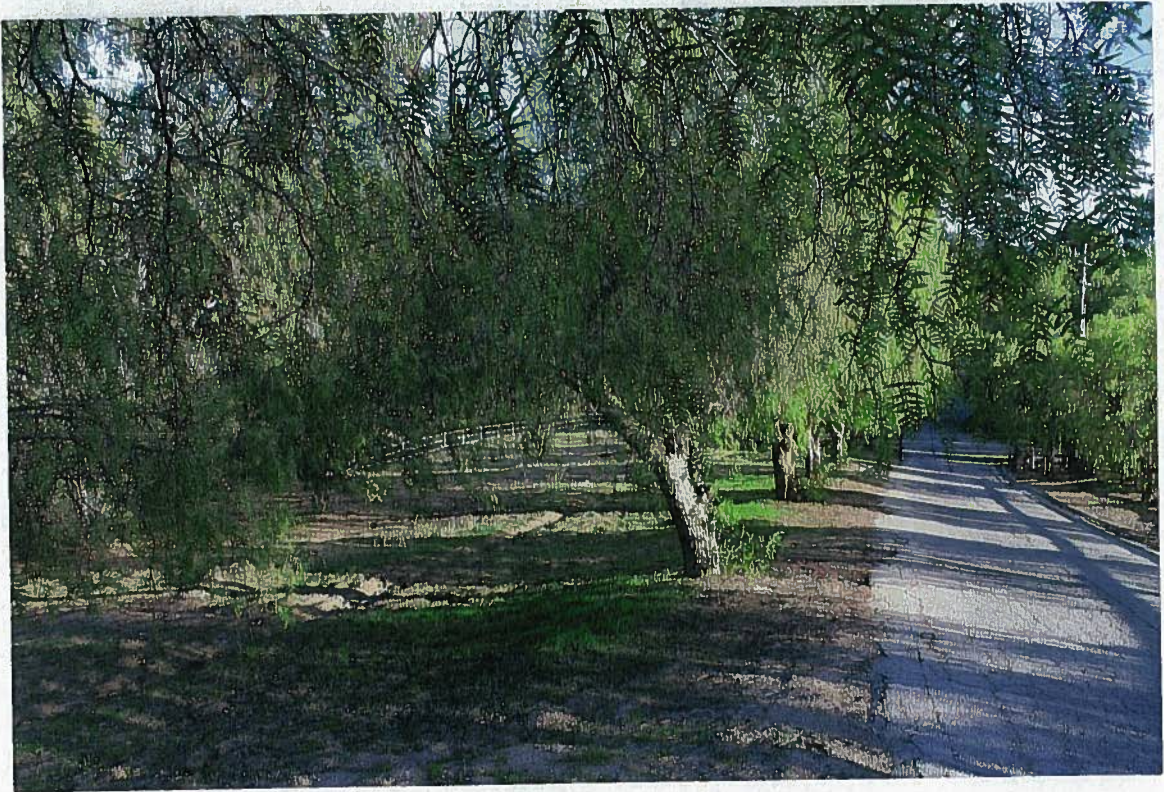
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