



**TENTATIVE TRACT MAP NO. 69073**

**FOR THE PROPERTY LOCATED AT**

**5310 COLODNY DRIVE, AGOURA HILLS**

**EXHIBIT G**


**REDUCED COPIES OF PLANS**



montage<sup>TM</sup>  
NEIGHBORHOOD BUILDERS<sup>TM</sup>

## "COLODNY APARTMENTS"

Rendering by Thomas Scott Architects  
1-800-255-1425 [montagelabs.com](http://montagelabs.com)

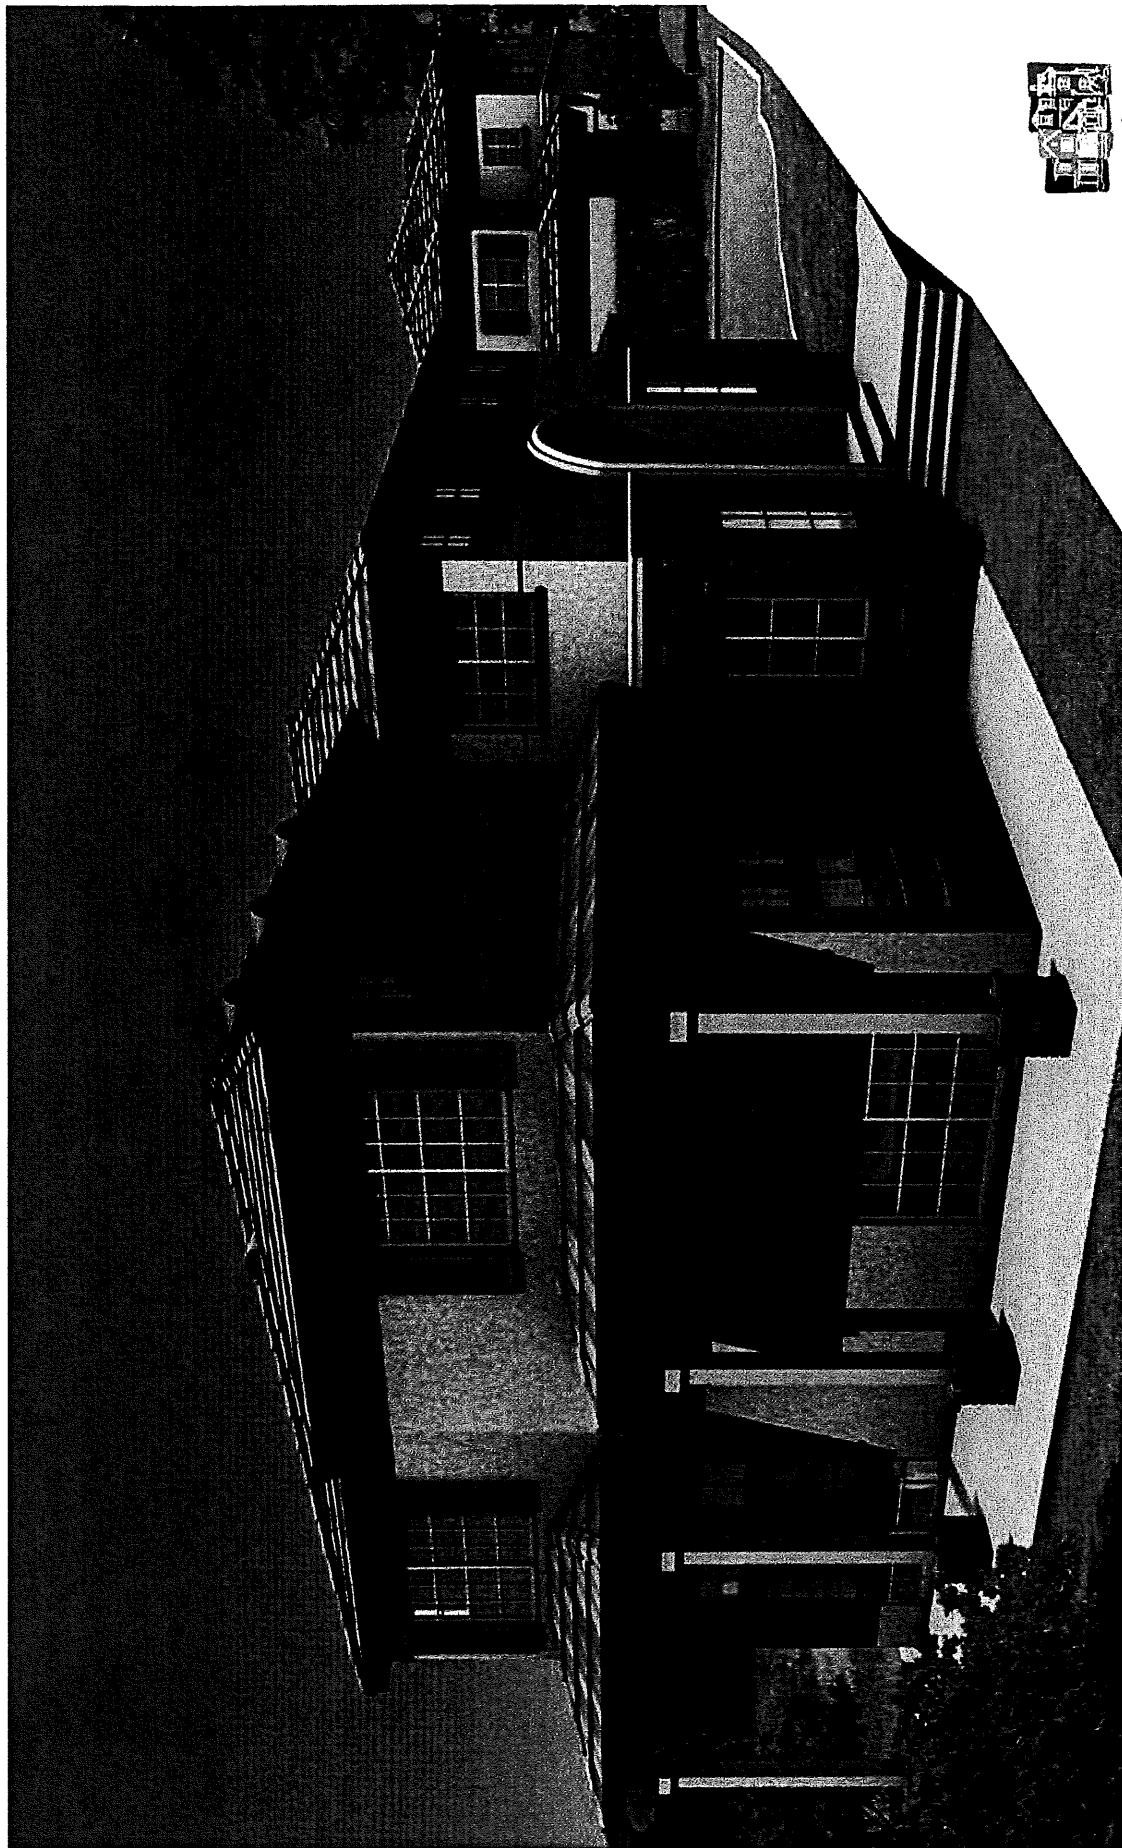

Rendering by Thomas Scott Nelson  
(305) 725-7149 Neighborhood #2206


## "Colodny Apartments"

NEIGHBORHOOD BUILDERS™



montage®



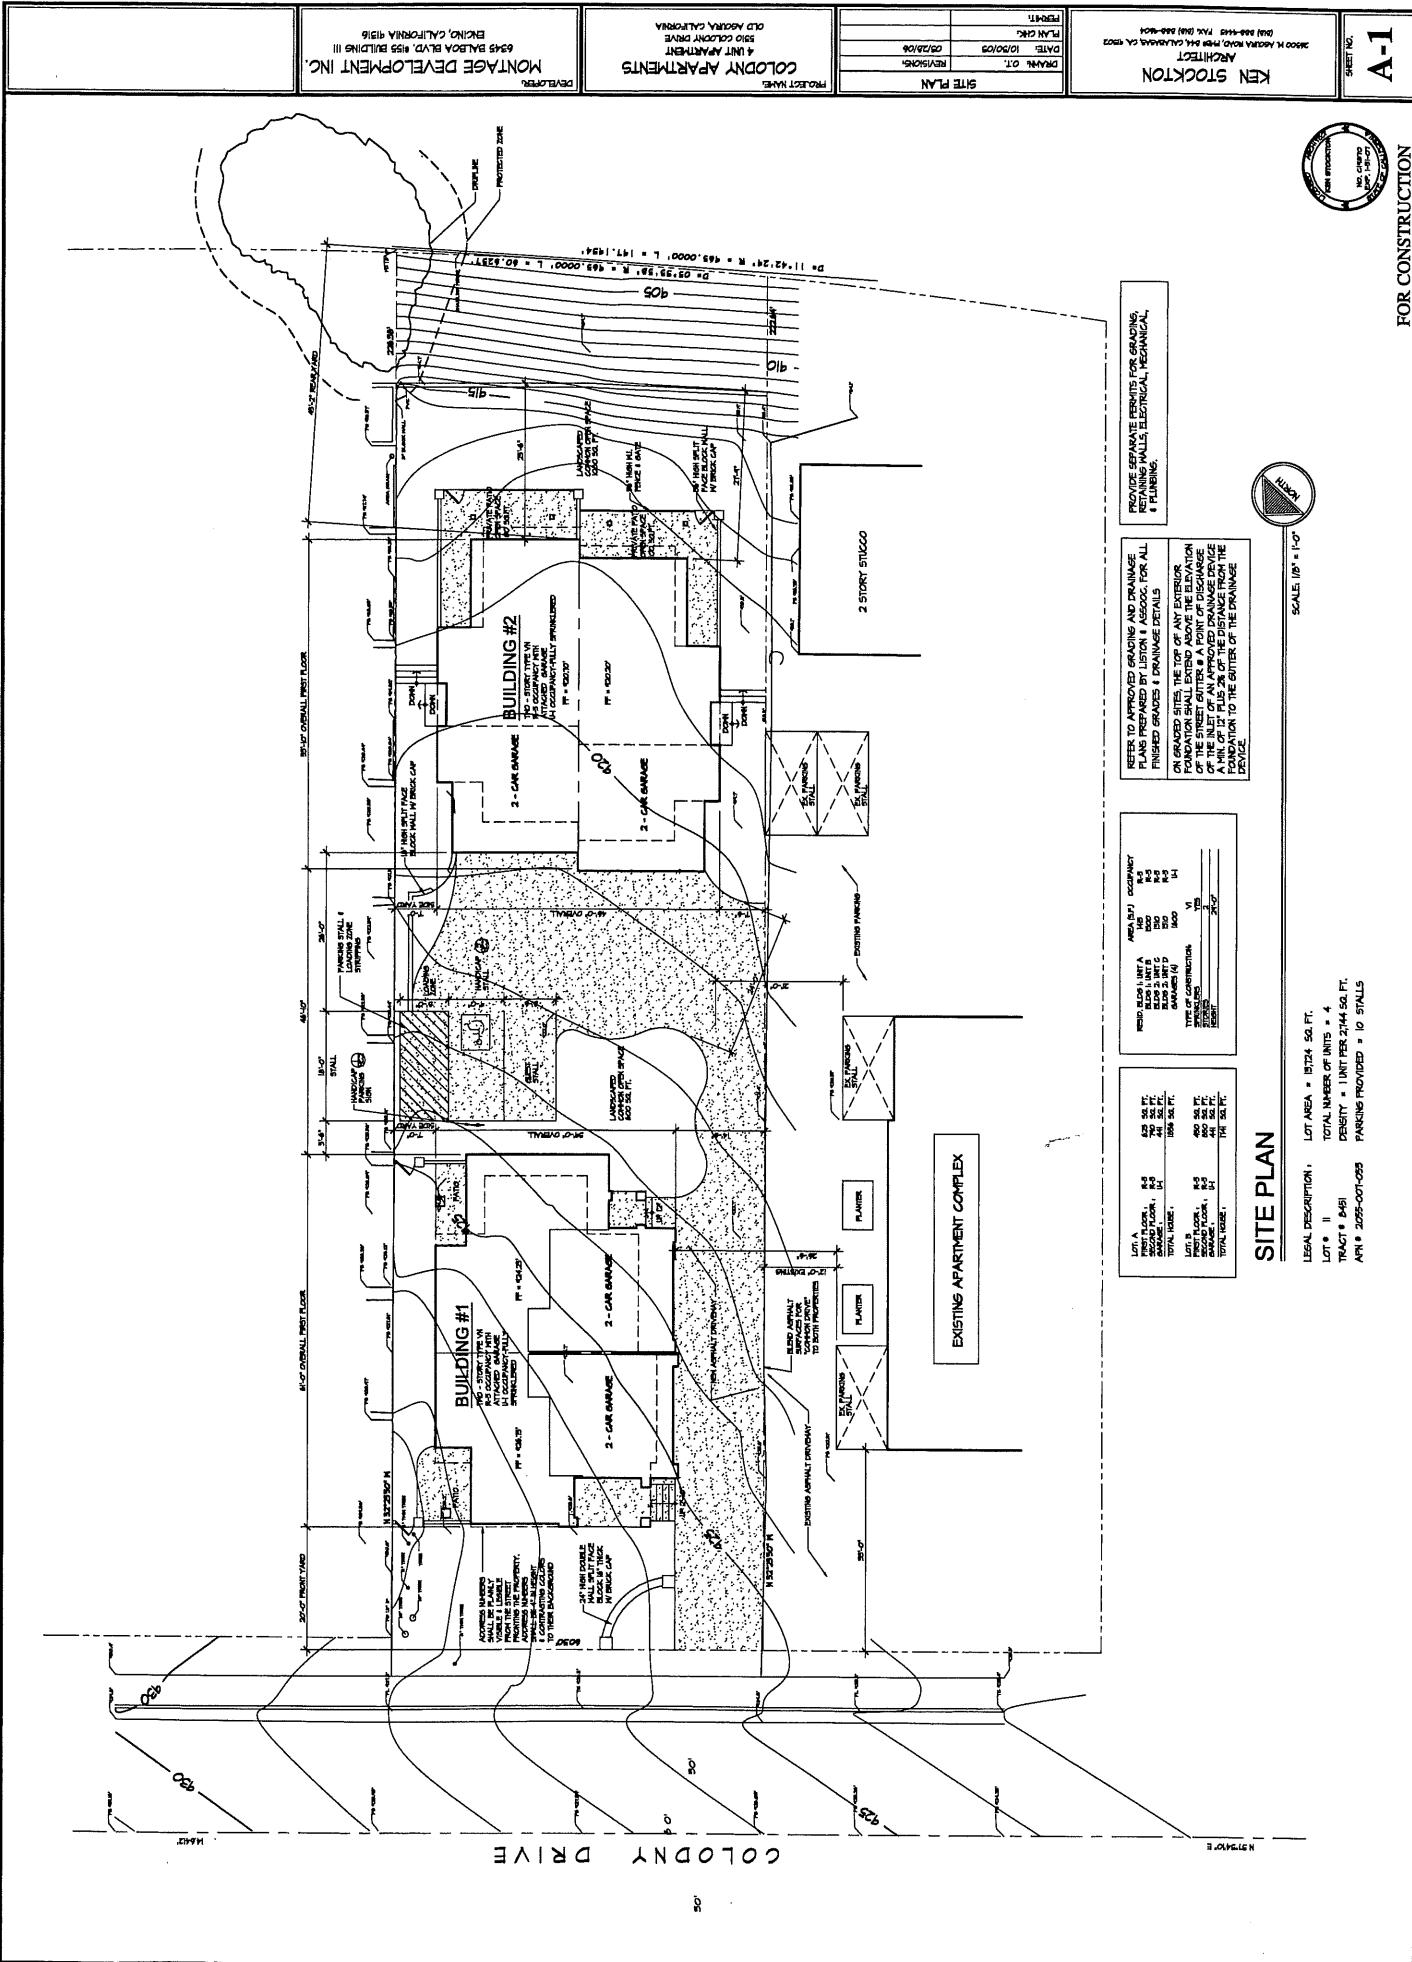




## KEN STOKTON

ARCHITECT  
3600 N Academy Blvd. Suite 200, Colorado Springs, CO 80904  
(719) 590-4414 Fax: (719) 590-4404


SECRET NO.

FIRST FLOOR PLAN - BUILDING #1  
PROJECT NUMBER: 937106  
DATE: 10/20/03  
REVISIONS: 0  
PLAT: GRS  
SHEET: 1 OF 1  
COLDNTR APARTMENTS  
4 INT APPARTMENT  
SUS CONCRETE PAVING  
CLD AGGREGATE  
EBCIC, CALIFORNIA 9116  
6345 BLAZER BLVD., SUITE BUILDING III  
MONTEAGE DEVELOPMENT INC.  
DEVELOPER

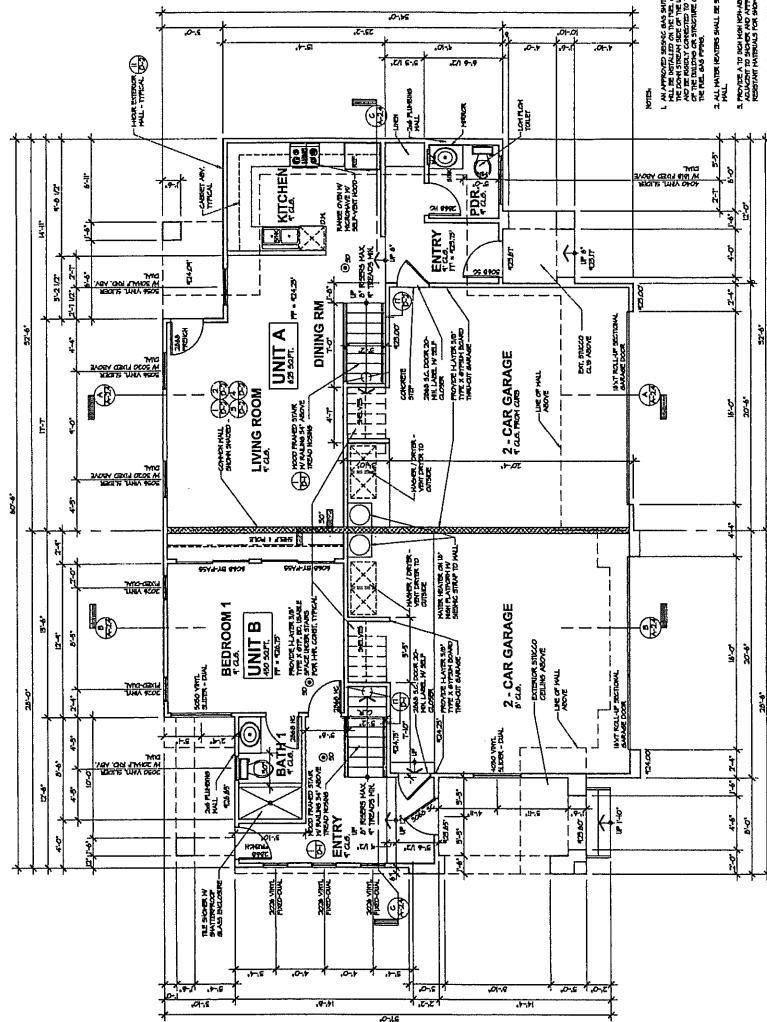

FIRST FLOOR PLAN - BUILDING #1

SCALE: 1" = 1'-0"

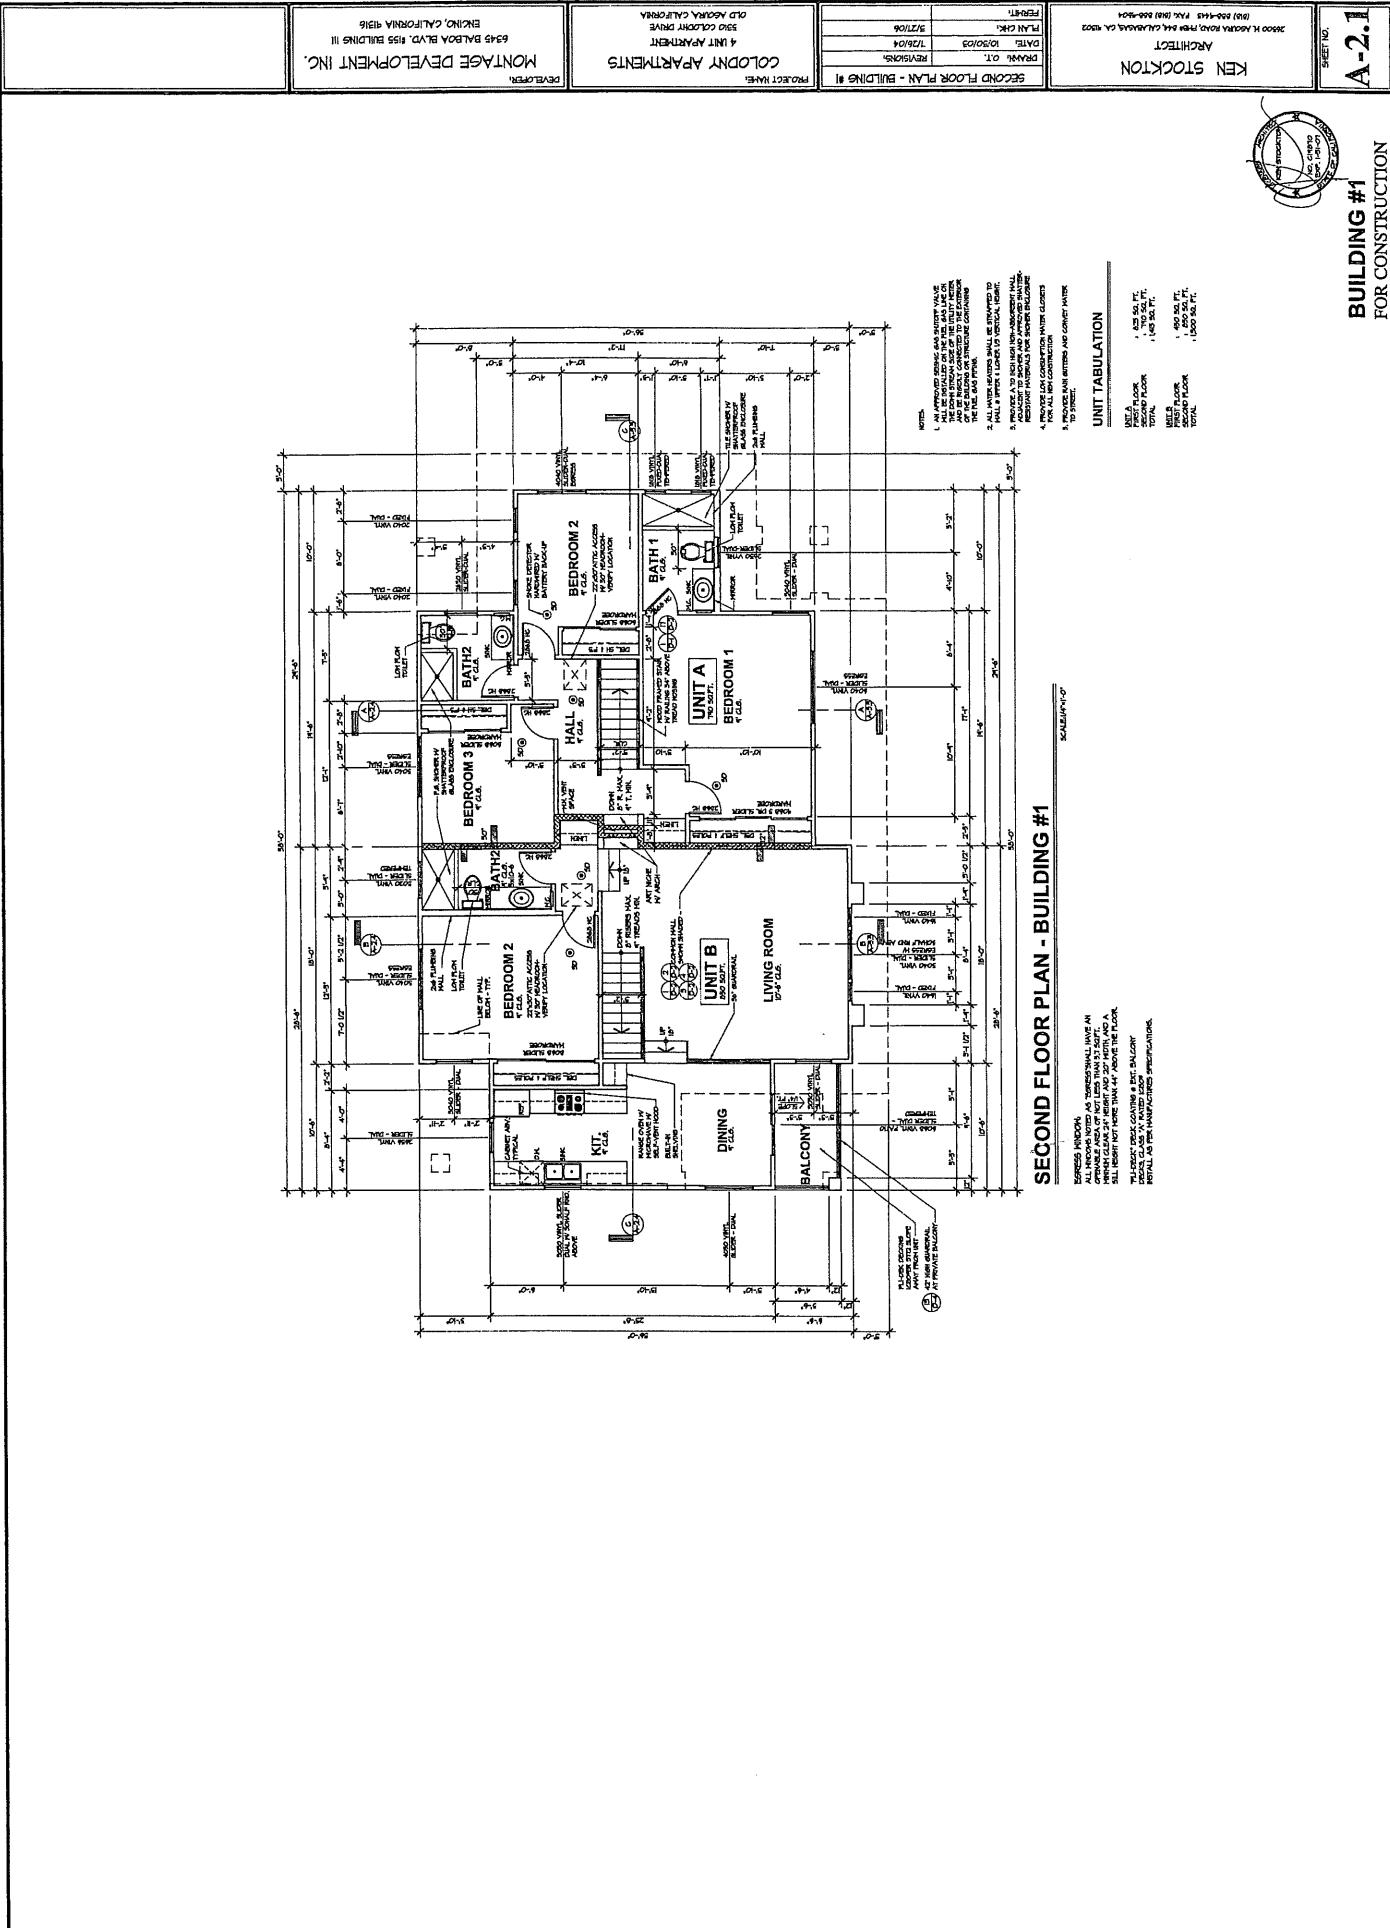

A = 2,2

BUILDING #1  
FOR CONSTRUCTION



KEN STOCKTON

ARCHITECT  
5300 N. MCKEEAN AVENUE, SUITE 300, CHICAGO, IL 60645  
(773) 334-1555 FAX (773) 334-6604

PERMIT

PLATE

DATE

REVISIONS

SECTION

FILE

PROJECT

NAME

UNIT NUMBER

STRUCTURE

ADDRESS


CITY

STATE

ZIP

MONTAGE DEVELOPMENT INC.  
DEVELOPER  
COLONY APARTMENTS  
PROJECT NAME


BURGESS CALIFORNIA 91316  
6915 BURGESS BLVD., SUITE BUILDINGS III

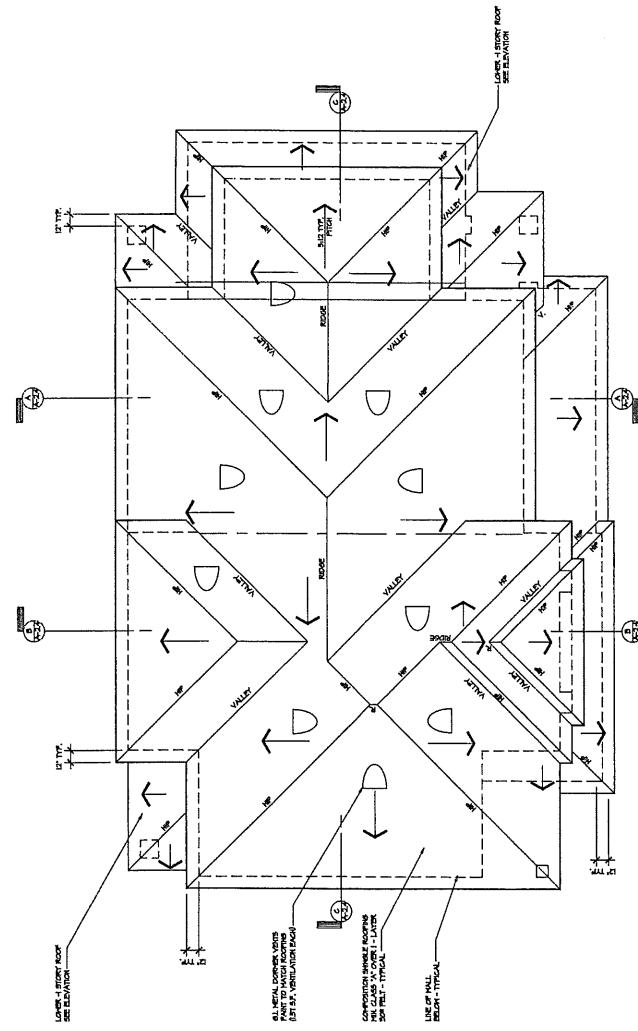



ROOF PLAN - BUILDING #1

SCALE: 1/8 INCH = 1'-0"

NOTE: ALL ROOF SLOPES TO BE 5:12  
TYPICAL RAFFIA OR FIBERGLASS TILED  
ROOF VALLEY FLASHING SHALL BE PROVIDED  
ACROSS ALL ROOF VALLEYS. THE ROOF VALLEY  
FLASHING SHALL BE A DURABLE PLASTIC SHEET  
EXTENDED OVER THE ROOF VALLEY BY A MINIMUM  
LEAD INCHES. THE ROOF VALLEY FLASHING SHALL  
NOT EXPOSE THE ROOFING SHEET. THE ROOF  
VALLEY FLASHING SHALL BE ATTACHED  
BY SCREWS WHICH SHALL BE NO LARGER THAN  
A VATED  
ROOF COMPONENTS SHALL BE GROUTED AND SMALL  
BE FINE SMOOTH & WELL FINISHED.

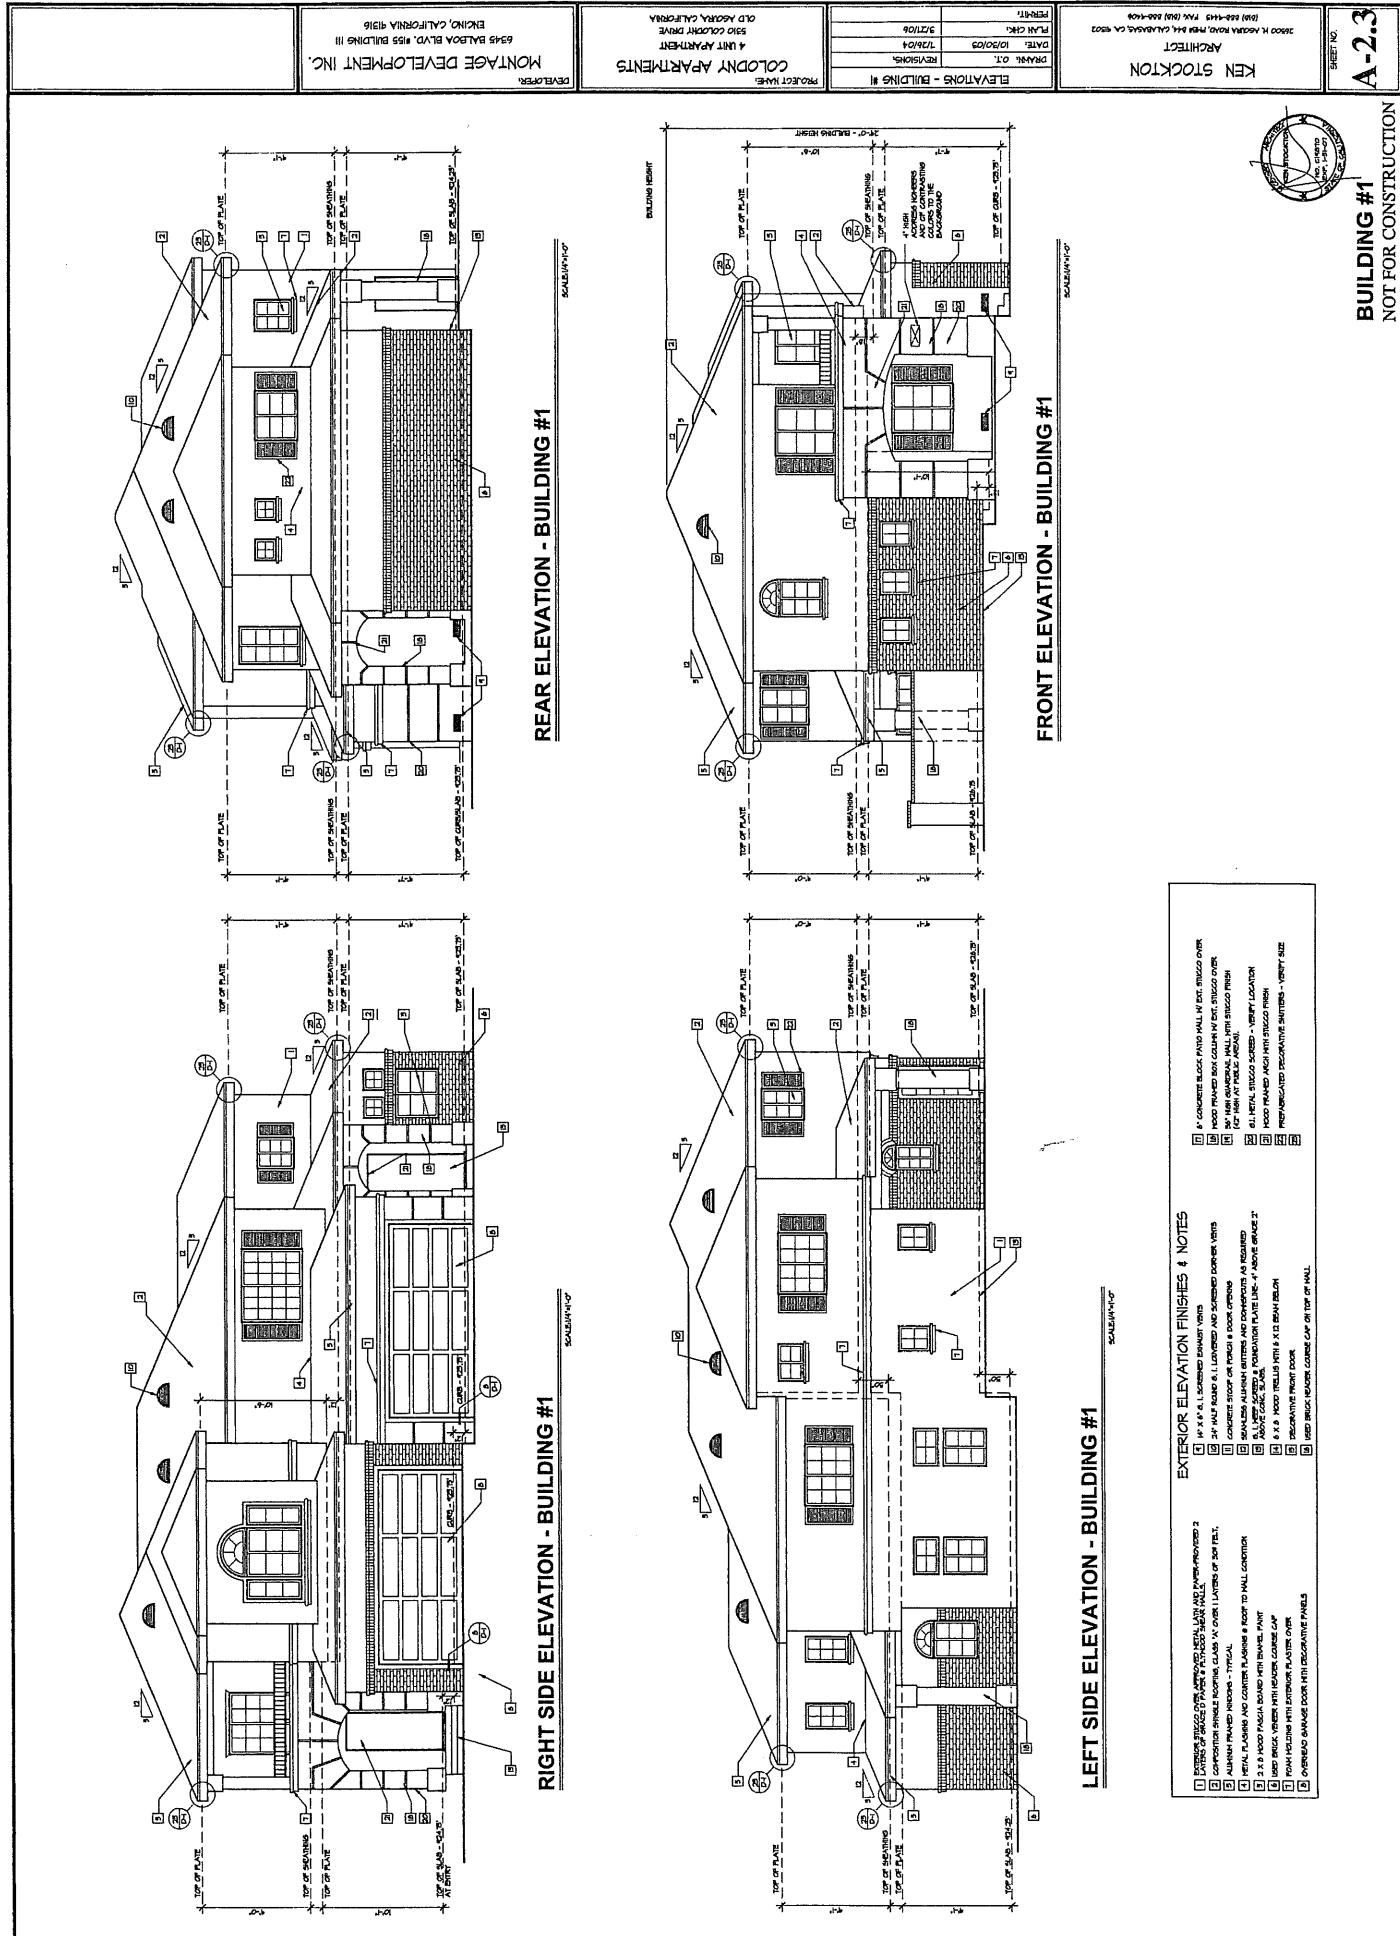

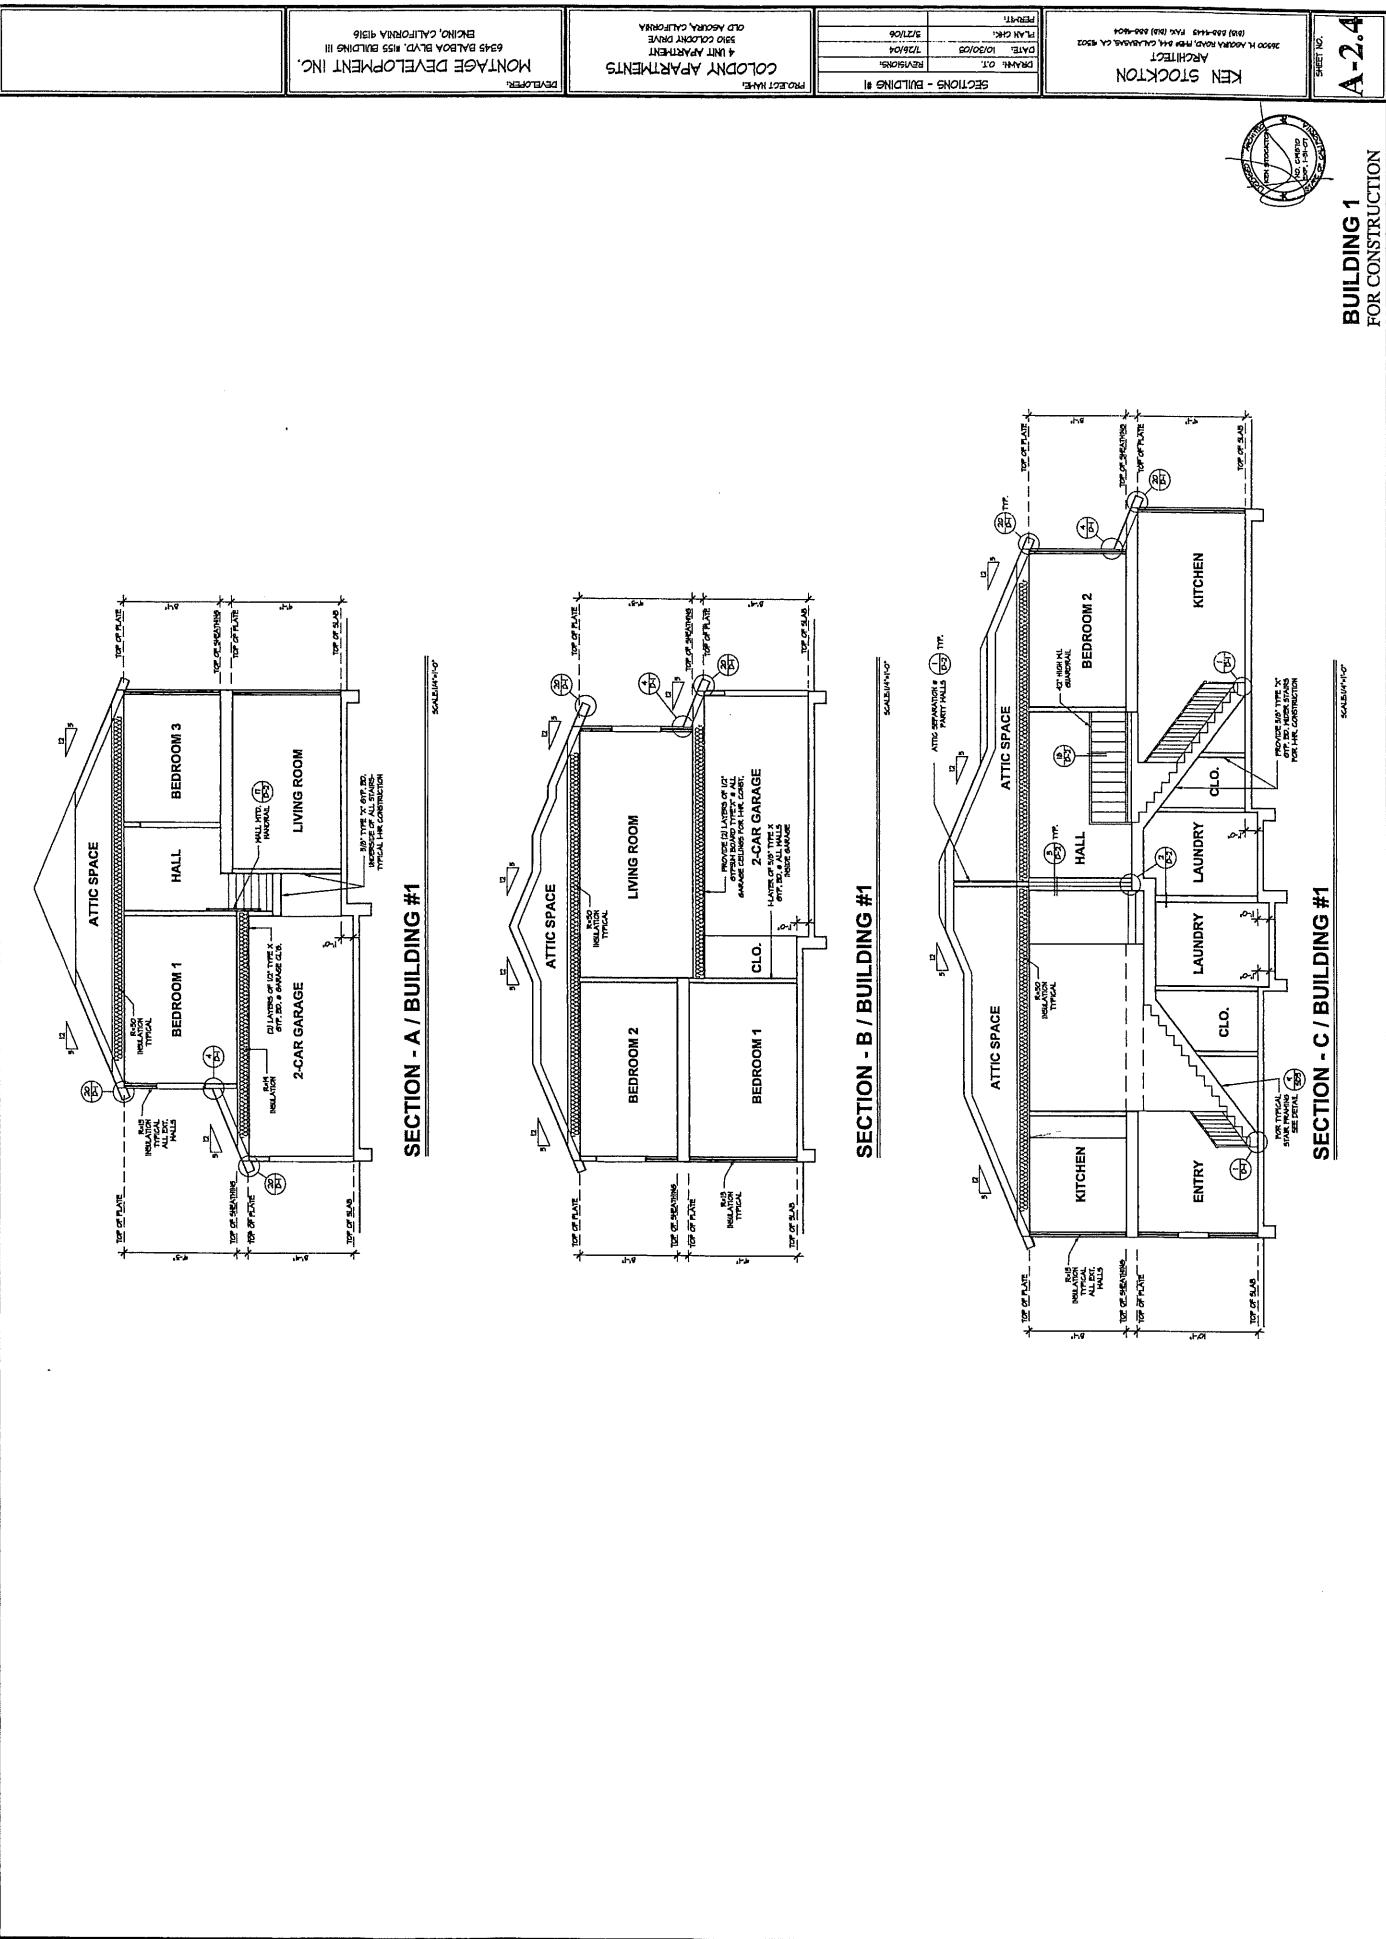

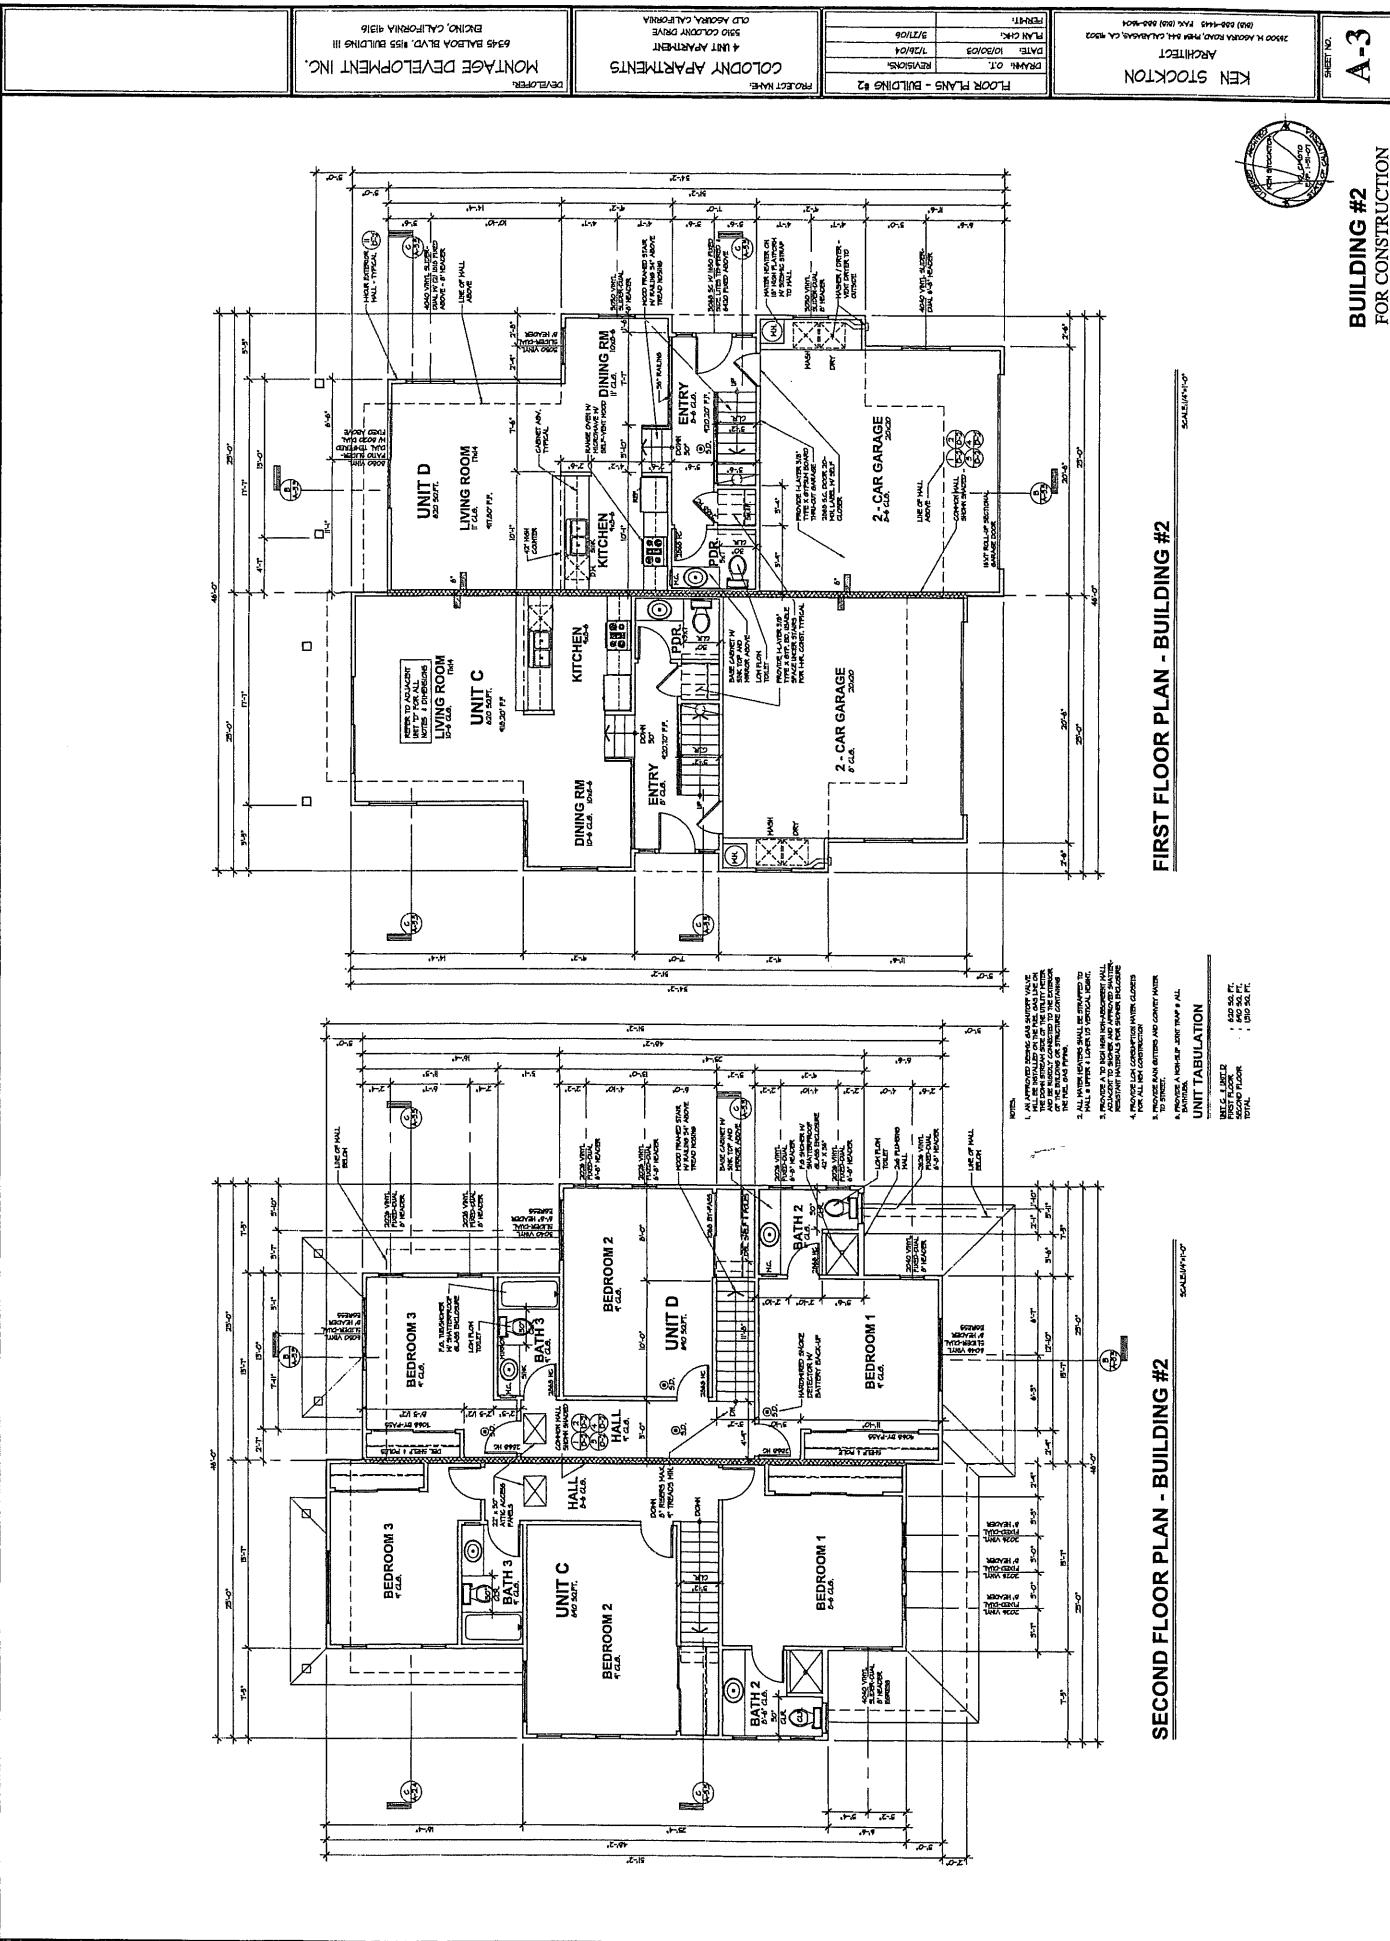

A-3.1



BUILDING #2  
FOR CONSTRUCTION

KEN STOCKTON

4000 N Academy Blvd, Suite 100, Colorado Springs, CO 80916

(719) 590-1144 Fax (719) 590-1145

Project No.

PLAT

DATE

DESIGNERS

SCALE

COLONIAL APARTMENTS  
4 UNIT APARTMENT  
301 COLONIAL DRIVE  
6345 CALIFORNIA BLVD. COLORADO SPRINGS, CO 80916

DEVELOPER


NAME

ADDRESS

CITY

STATE


ZIP

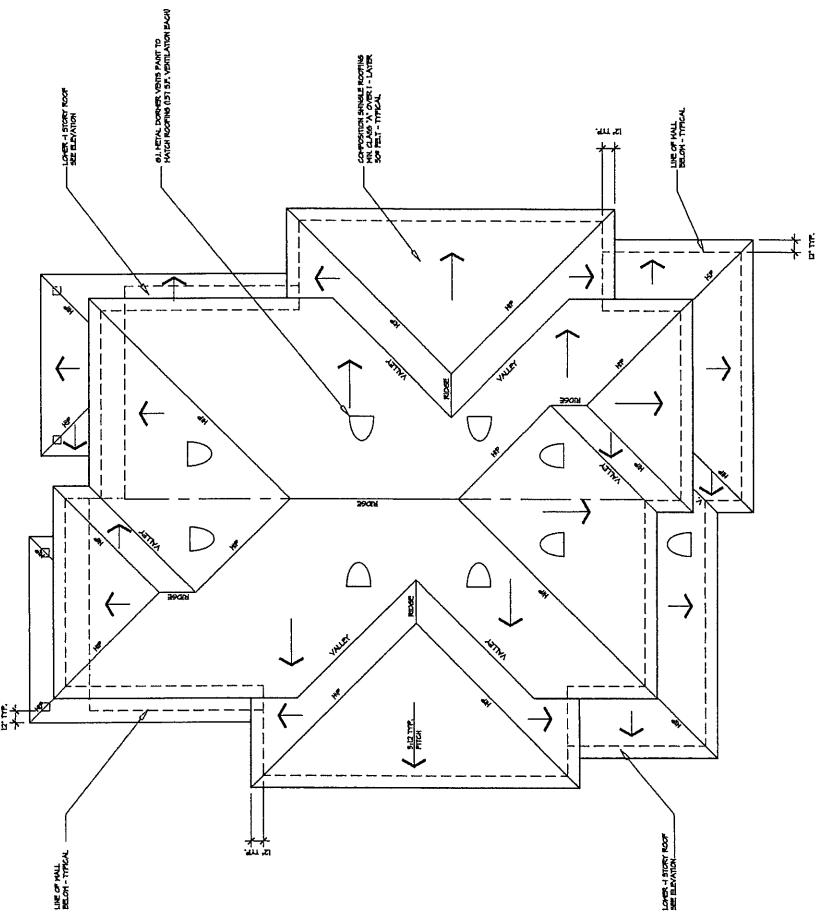

ROOF PLAN - BUILDING #2

SCALE 1/8" = 1'-0"

NOTE:  
ALL ROOF LAVES TO BE 5/12.  
IRON VALLEY LAVES SHALL BE PROVIDED  
SHEAR CORDON EROOFING METAL AND SURFACED  
EACH AT LEAST 12 INCHES THICK AND 12 INCHES  
LINE DASH, EROOFING METAL AND SURFACED  
IRON VALLEY LAVES SHALL BE PROVIDED  
NO TWO METAL SHEET LAVES SHALL BE ADDED  
A UNITED  
IRON CORDON SHELL, GLASS, W. NO SMALL  
BE THE SPACES & THE SHELL.

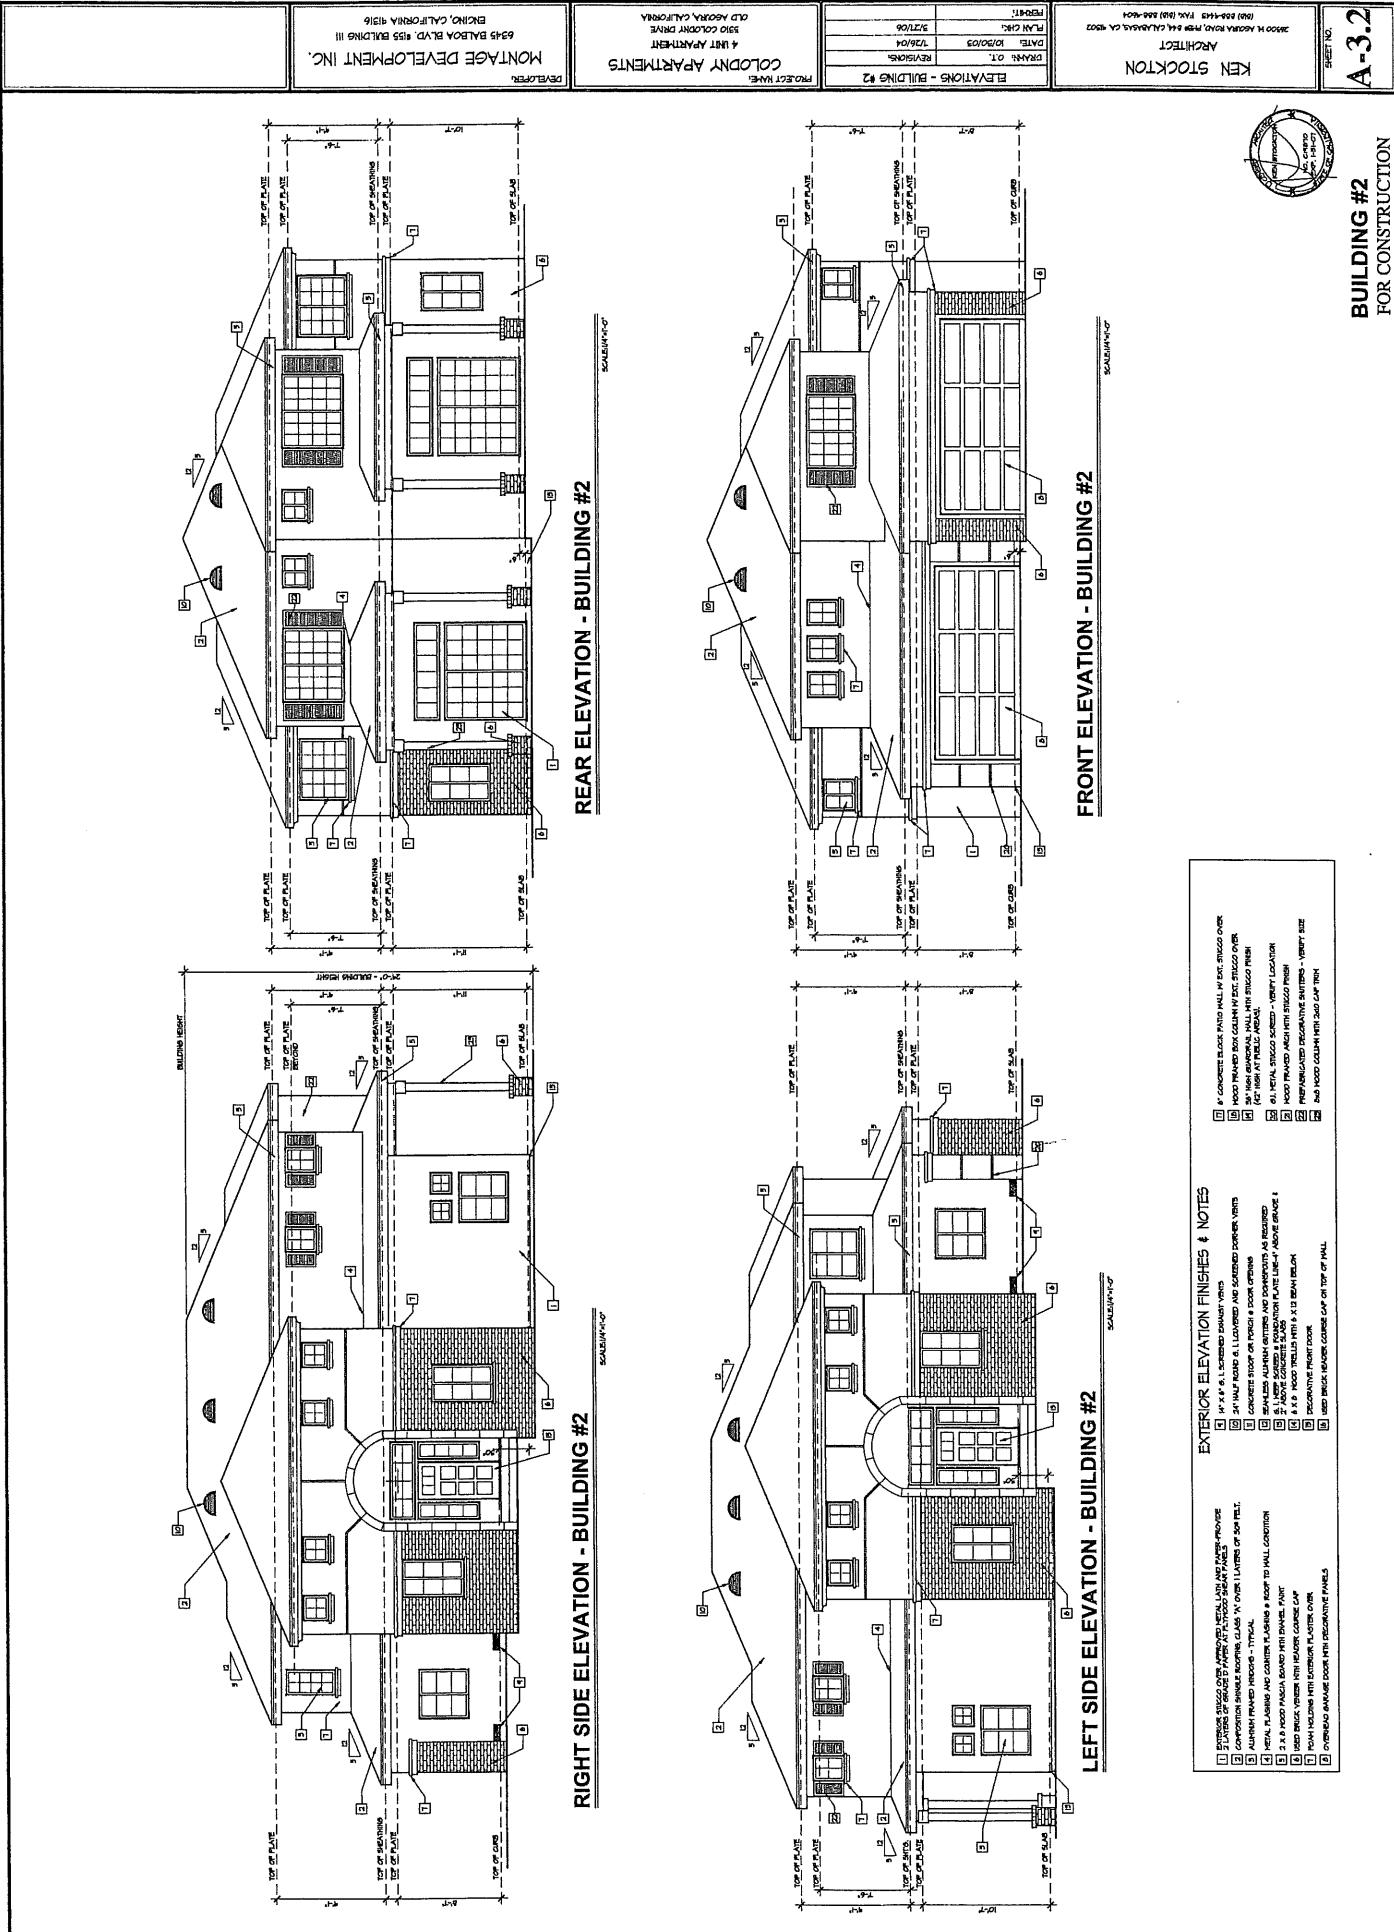

KEN STOCKTON

A-3.3



BUILDING #2  
FOR CONSTRUCTION


3200 N. AUBURN AVENUE, SUITE 100, CHICAGO, IL 60640

(773) 525-1113 FAX (773) 525-1100

SHEET NO.


COLONY APARTMENTS  
MONTEGE DEVELOPMENT INC.  
6345 BELMONT BLVD., SUITE 111  
CHICAGO, ILLINOIS 60631  
DEVELOPER

PROJECT NAME:  
SECURITY - BUILDING #2  
PROJECT NUMBER:  
DATE: 10/20/02  
REVISED: 09/22/02  
PLATE:

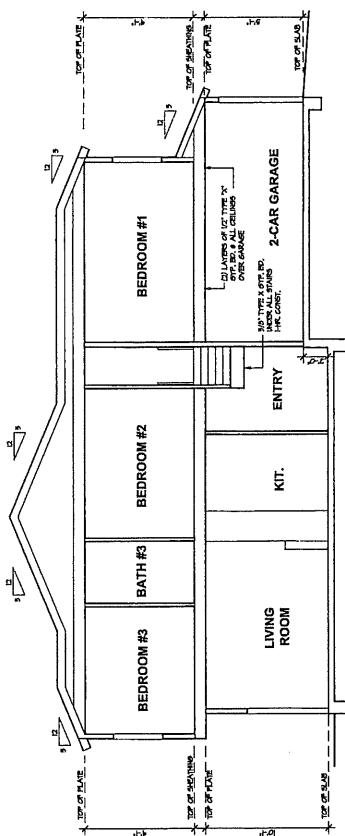


SECTION - B / BUILDING #2

SECTION - A / BUILDING #2

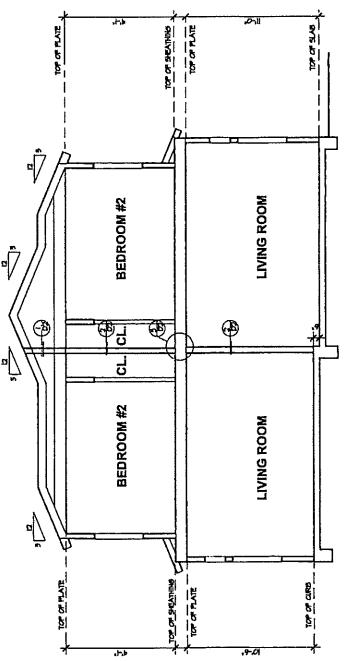

SECTION - C / BUILDING #2

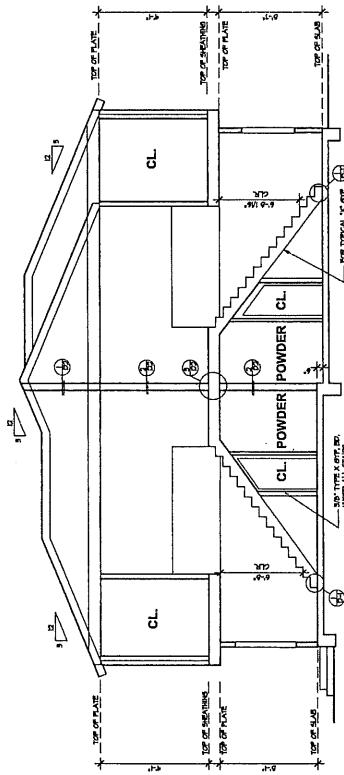






MONTAGE DEVELOPMENT INC.  
6955 PINEWOOD BLVD., SUITE 1100, BURBANK, CA 91505


COLUDRY APARTMENTS  
1011 PINEWOOD DRIVE  
OLD ADDITION CULVER CITY  
365 CULVER DRIVE

(408) 866-1145 FAX (408) 866-1146 1011 PINEWOOD DR.

ARCHITECT  
KEN STOCKTON  
SHEET NO.  
D-2




















































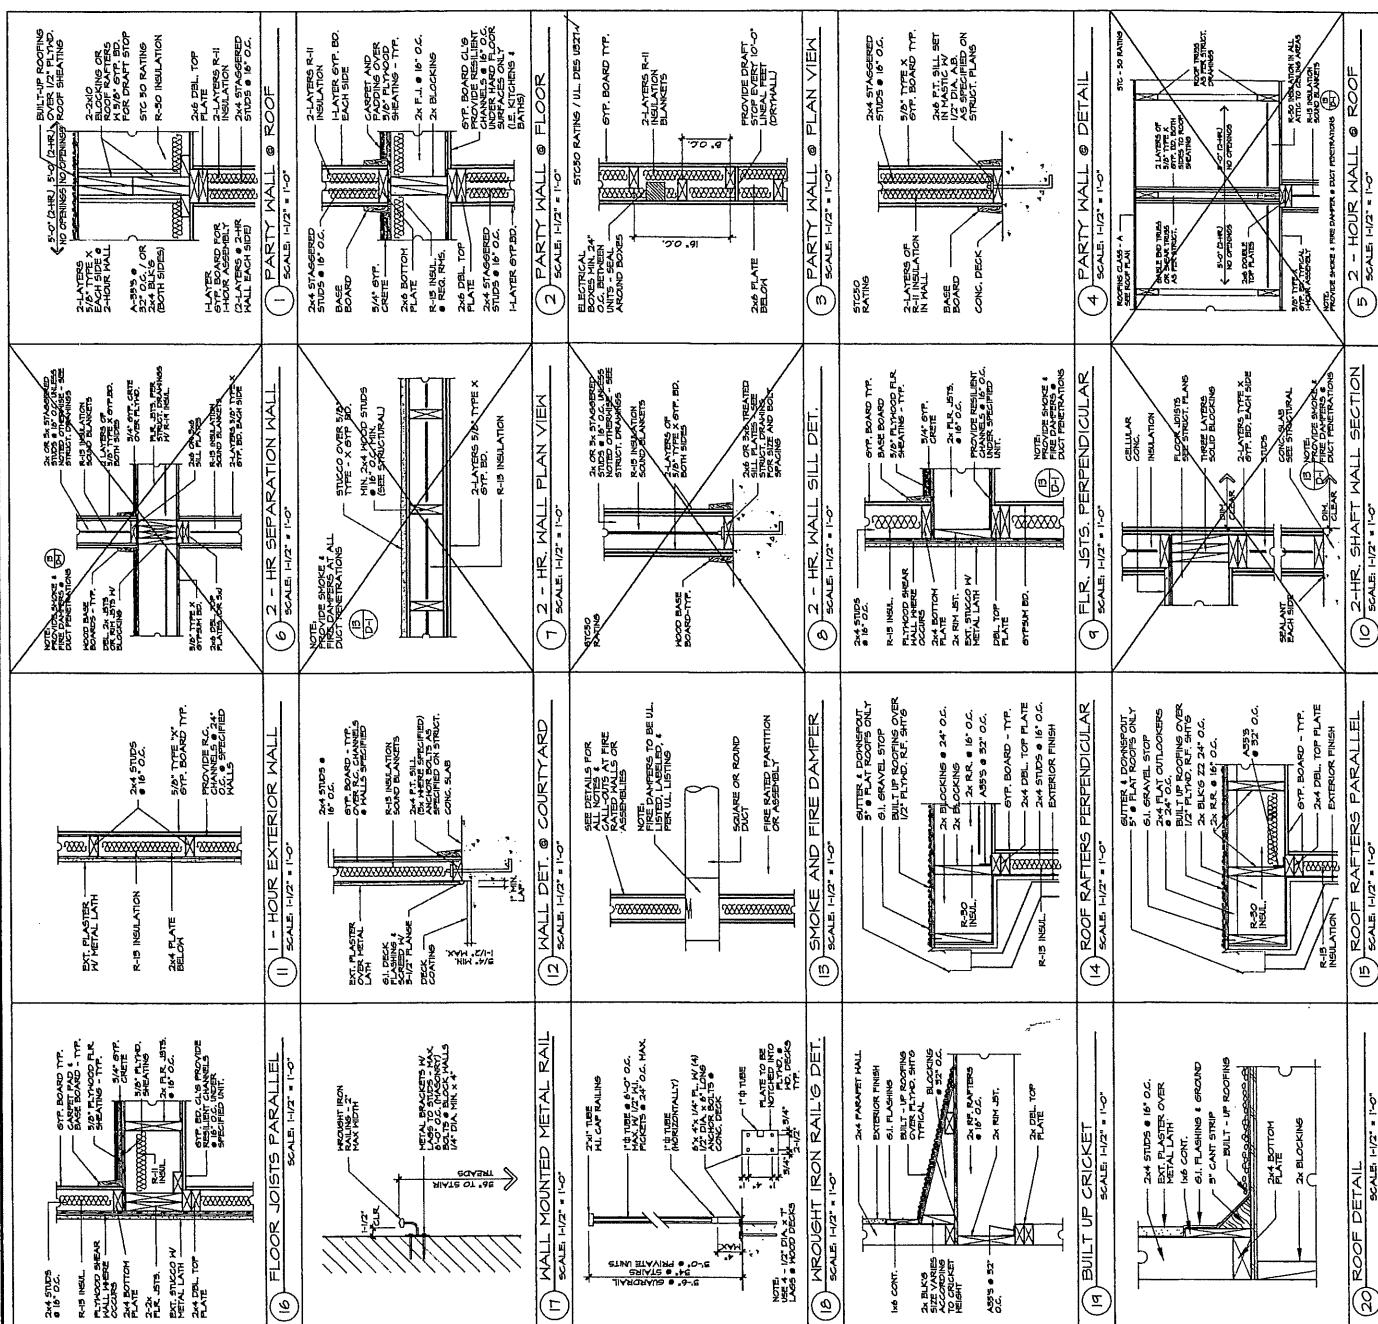





COLONY APARTMENTS  
4 UNIT APARTMENT BUILDING  
645 BALTIMORE AVE PHILADELPHIA PA 19106  
OWNER / DEVELOPER  
PROJECT NO. 102003  
DATE 10/20/03  
DESIGNER [REDACTED]  
PERMIT NO. [REDACTED]

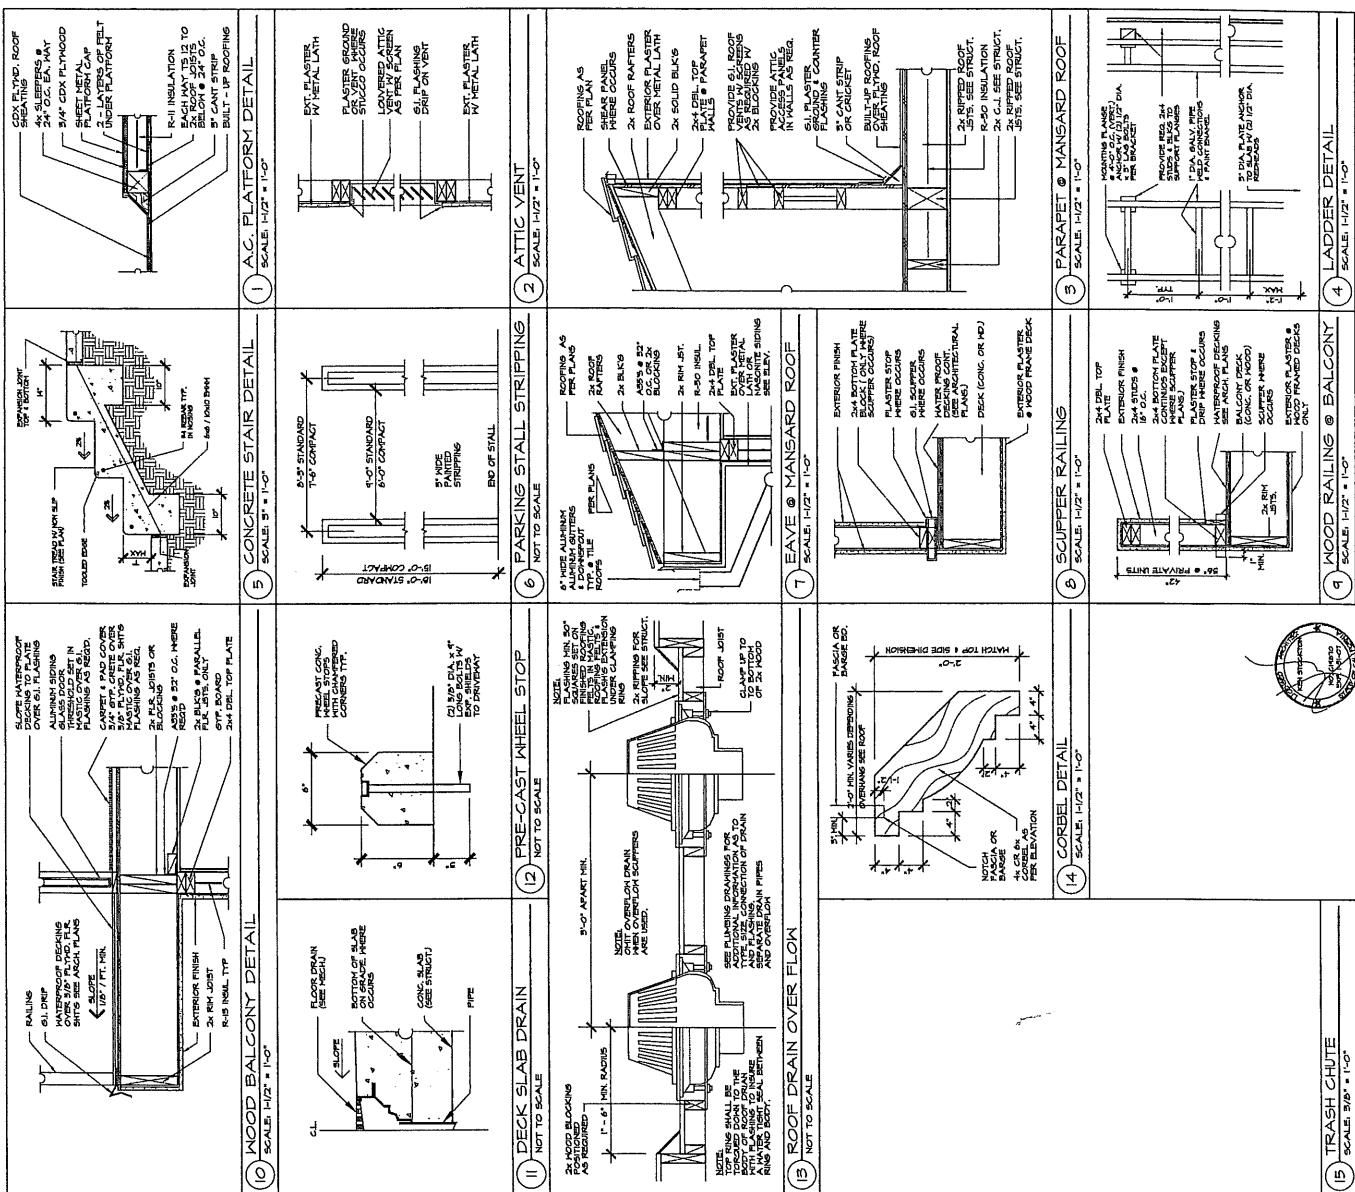

<p>1. PRIVATE STAIR TOP: Scale 5/8" = 1'-0". Shows a wooden handrail with a 5/8" radius, 2x wood struts, and a concrete slab.</p> <p>2. PRIVATE STAIR BOTTOM: Scale 5/8" = 1'-0". Shows a wooden handrail with a 5/8" radius, 2x treated pine anchor bolts, and a concrete slab.</p> <p>3. STAIR TO SLAB: Scale 5/8" = 1'-0". Shows a wooden handrail with a 5/8" radius, 2x wood struts, and a concrete slab.</p> <p>4. HANSDARD CAP DETAIL: Scale 1/2" = 1'-0". Shows a metal header, black strap, and various plaster and metal components.</p> <p>5. PARAPET WALL: Scale 1/2" = 1'-0". Shows a parapet wall with a 2x6 header, 2x6 studs, 1/2" sheathing, 2x4 bottom plate, 2x4 top plate, and various trim and flashing details.</p> <p>6. ACCESSIBLE PARKING STALL SIGN: Not to scale. Shows a sign for accessible parking with a wheelchair symbol.</p> <p>7. ELECTRICAL OUTLET: Not to scale. Shows an electrical outlet with two receptacles and a ground terminal.</p> <p>8. BALCONY RAIL: Scale 5/8" = 1'-0". Shows a balcony rail with a 2x6 top plate, 2x4 bottom plate, and various support and fastening details.</p> <p>9. PATIO WALL: Not to scale. Shows a patio wall with a 2x6 top plate, 2x4 bottom plate, and various support and fastening details.</p> <p>10. BAR TOP DETAIL: Not to scale. Shows a bar top detail with a 2x6 top plate, 2x4 bottom plate, and various support and fastening details.</p>	<p>OWNER / DEVELOPER MONTAGE DEVELOPMENT INC. PRO-OWNER COLDTRY APARTMENTS</p> <p>ARCHITECTURE DET. 10/2003 REVISED: 10/2003 3000 N ASHBURN AVE., MILWAUKEE, WI 53211-3402 (414) 662-4443 TOLL (800) 662-4443 E-mail: 6624443@msn.com</p> <p>STRUCTURAL DET. 10/2003 REVISED: 10/2003 3000 N ASHBURN AVE., MILWAUKEE, WI 53211-3402 (414) 662-4443 TOLL (800) 662-4443 E-mail: 6624443@msn.com</p>	<p>KEN STOCKTON ARCHITECT DET. 10/2003 REVISED: 10/2003 3000 N ASHBURN AVE., MILWAUKEE, WI 53211-3402 (414) 662-4443 TOLL (800) 662-4443 E-mail: 6624443@msn.com</p> <p>SHEET NO. D-4</p>	

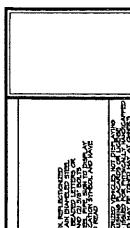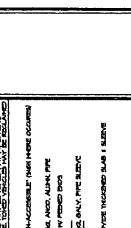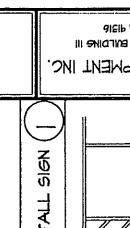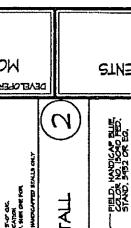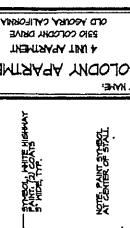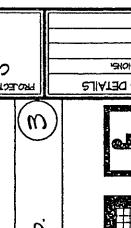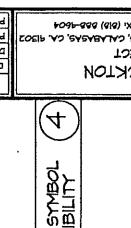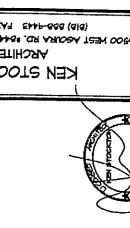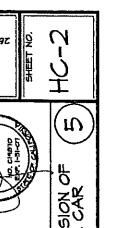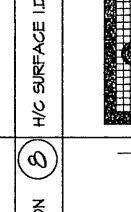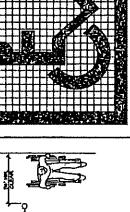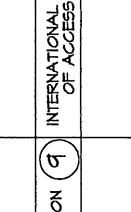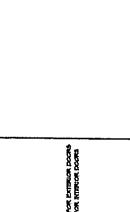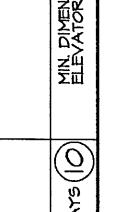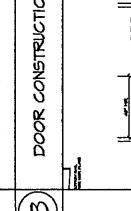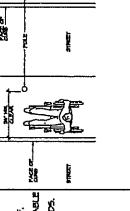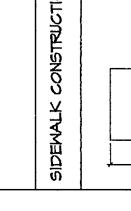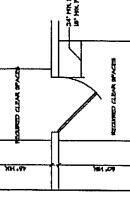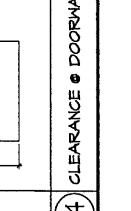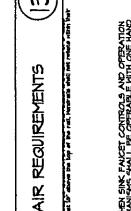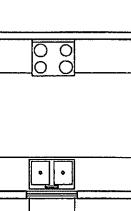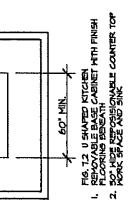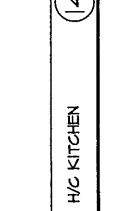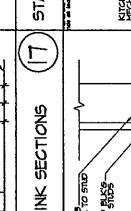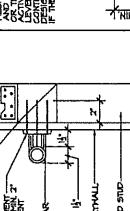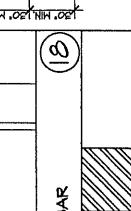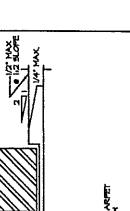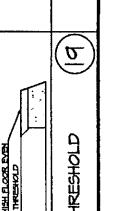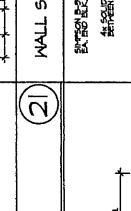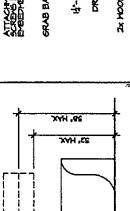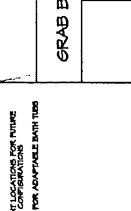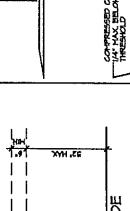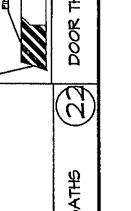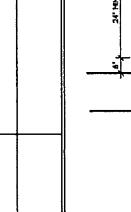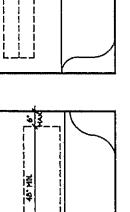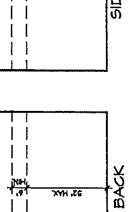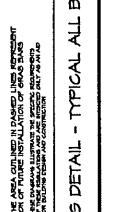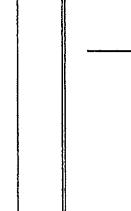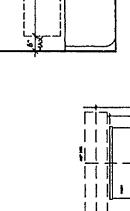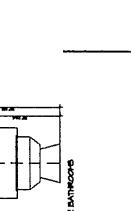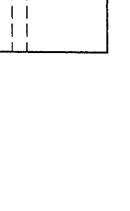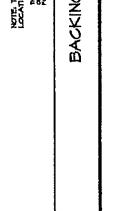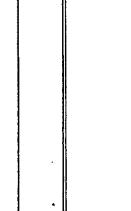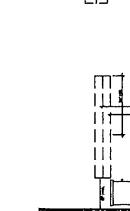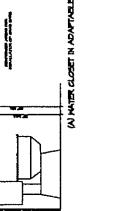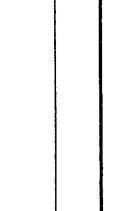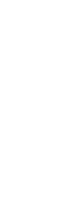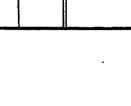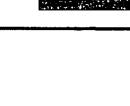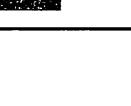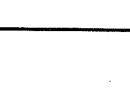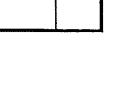

H.C. KITCHEN		BACKING DETAIL - TYPICAL ALL BATHS		DOOR THRESHOLD		H.C. KITCHEN		CLARIFICATION OF DOORWAYS		MIN. DIMENSION OF ELEVATOR CAR	
(19)		(22)		(21)		(19)		(14)		(10)	
											
											
											
											
											
											
											
											
											
											
											

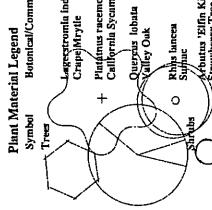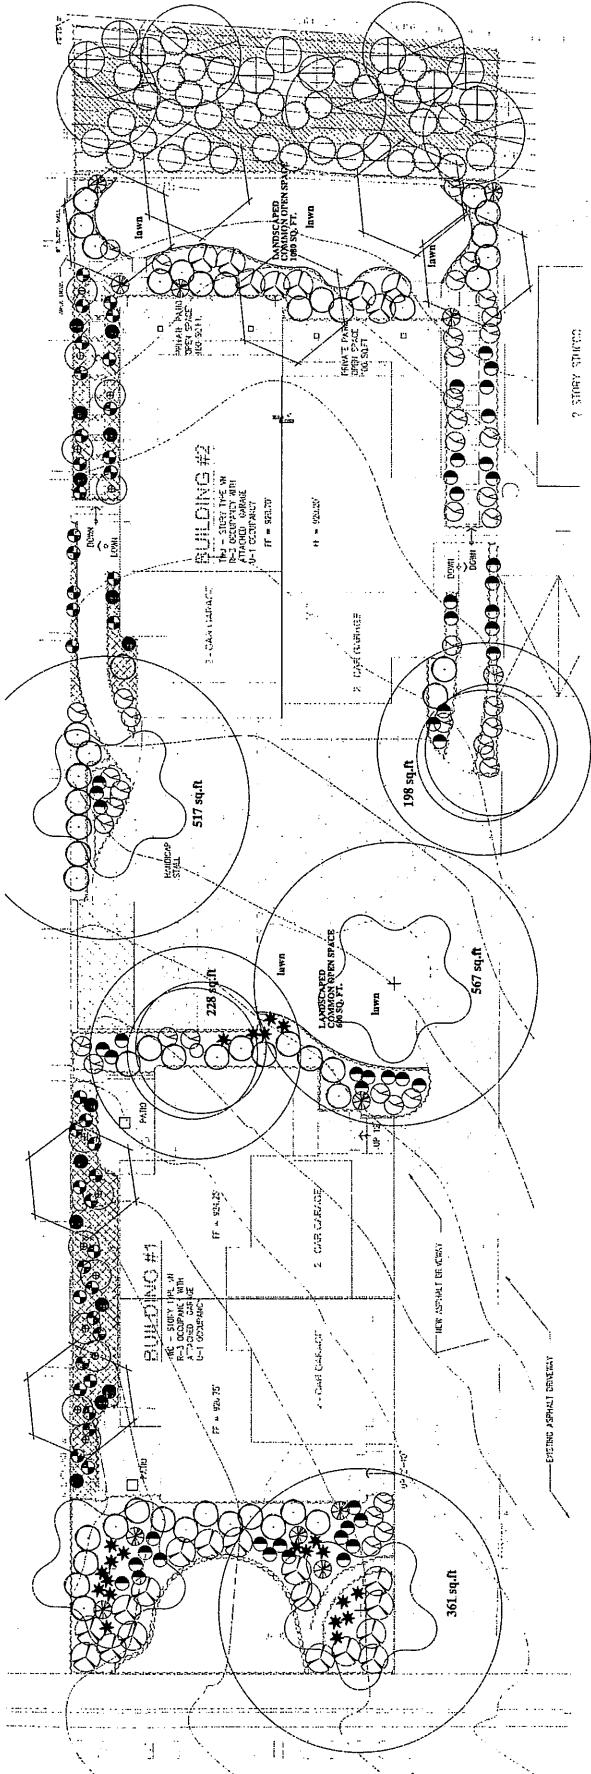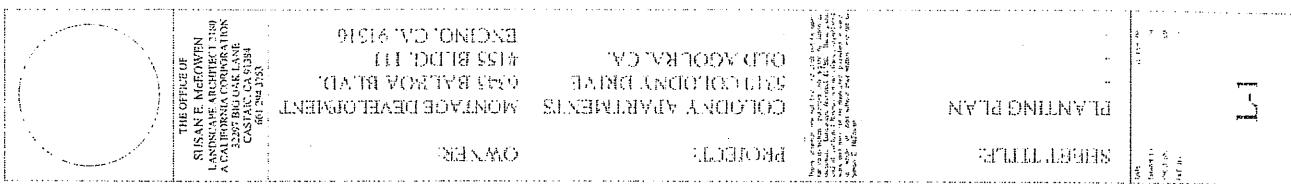

Notes:  
1. All plant material shall conform to the most recent edition of ANSI Z60.1 - American Standard for Nursery Stock.  
2. Prior to scheduling an inspection of the landscape installation with the City, the applicant's landscape architect shall certify in writing that the installation is in conformance with the approved landscape plans.

Parking & driveway area = 2,222 sq. ft.  
50% Parking & driveway area = 1,611 sq. ft.  
50% Parking & driveway area in 15 years = 1,871 sq. ft.



PLANTING PLAN  
SCALE: 1" = 5'-0"

PLANTING PLAN  
SCALE: 1" = 5'-0"

L-1

## IRRIGATION PLAN

SCALE: 100' - 1'-0"

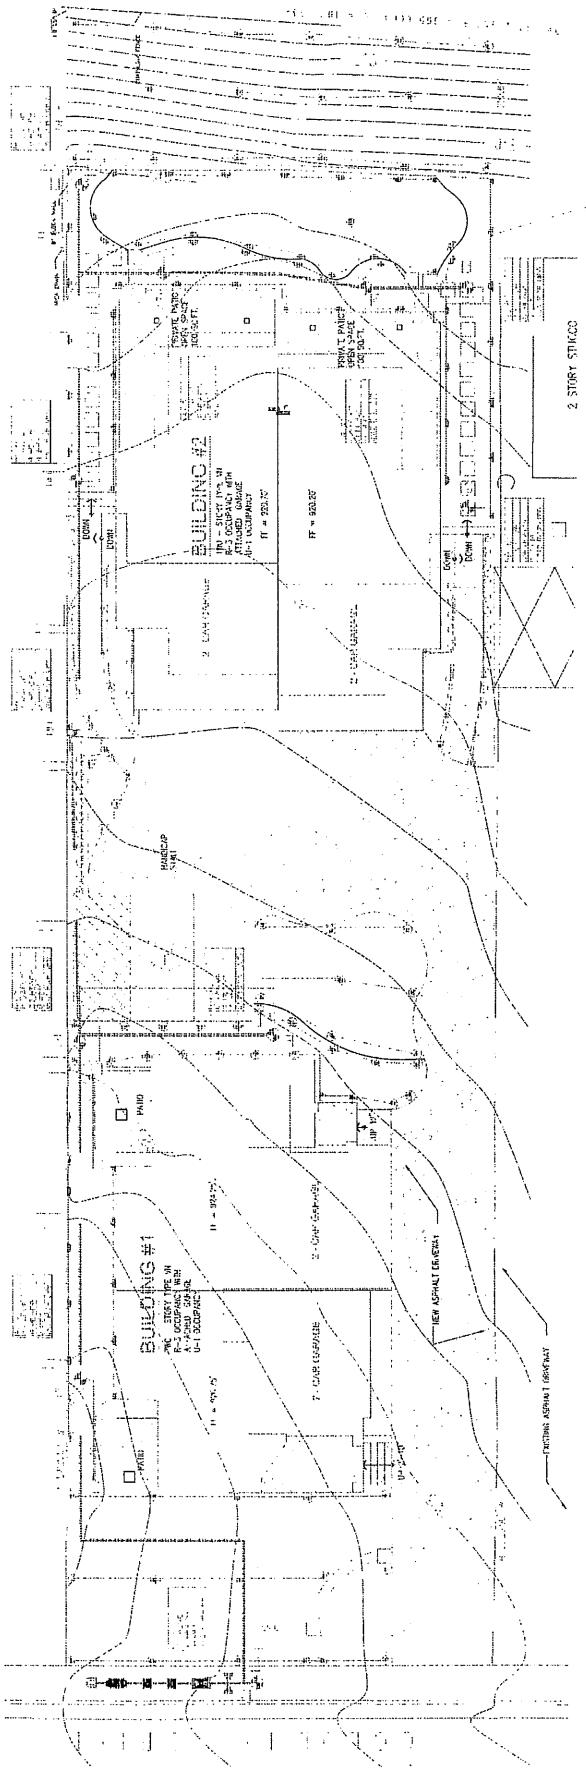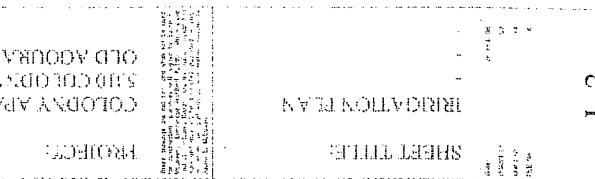



**TENTATIVE TRACT MAP NO. 69073**

**FOR THE PROPERTY LOCATED AT**  
**5310 COLODNY DRIVE, AGOURA HILLS**

**EXHIBIT H**

**VICINITY MAP**

TENTATIVE TRACT MAP NO. 69073

