



MEMORANDUM

DATE: **NOVEMBER 5, 2009**

TO: **PLANNING COMMISSION**

FROM: **PLANNING STAFF**

SUBJECT: **PRESENTATION OF INFORMATION REGARDING THE REYES ADOBE ROAD/HIGHWAY 101 INTERCHANGE IMPROVEMENTS**

The purpose of this item is for City staff to present information to the Planning Commission regarding the U.S. 101 Freeway / Reyes Adobe Road Interchange project. The project just recently commenced construction so City staff would like to take this opportunity to update the Commission on the project. This is an information item only and there is no action required by the Planning Commission.

The U.S. 101 Freeway / Reyes Adobe Road Interchange currently consists of a three-lane bridge with single left-turn pockets for the northbound and southbound on-ramps. A single sidewalk is located on the east side of the bridge. No bicycle lanes or pedestrian light fixtures are located on the bridge.

The interchange project will make improvements to the existing outdated interchange, primarily by widening the west side of the existing three-lane bridge to accommodate six lanes, including left-run pockets. The improvements also include providing sidewalks on both sides of the bridge, decorative lighting and railing, landscaping on each quadrant of the interchange, the construction of a water quality basin on the southeast corner of Canwood Street and Reyes Adobe Road, and the realignment of utility poles located on Canwood Street. Clearing and grubbing of the project site has begun and a culvert located at the southwest corner of Canwood Street and Reyes Adobe Road and been removed.

The improvements will help alleviate congestion leading to the interchange as well as on the overpass, increase pedestrian and bicycle safety thus encouraging people to walk or ride, improve landscaping at this important City gateway, and generally improves north-south access from one side of the freeway to another in the western part of the City.

The Reyes Adobe Road Bridge was first constructed in 1965. The construction of the diamond interchange provided a safe passage for through and local traffic in the area at

that time. In 1974, the U.S. 101 Freeway was widened from a four-lane highway to an eight-lane freeway. The widening required the reconfiguration of the on- and off-ramps at Reyes Adobe Road. This configuration resulted in the tight diamond interchange that exists today.

The bridge widening project will occur over four stages. Stage 1 consists of fill grading and construction of the bridge widening and will be completed by October of 2010. Stage 2 consists of construction of northbound on-ramp and southbound off-ramp modifications, and the sidewalks on Reyes Adobe Road. This second stage is expected to be completed in November of 2010. Stage 3 will be completed in December of 2010 and consists of street median work. Stage 4 is to occur in late December of 2010, through January of 2011, and includes the street overlays and punch-list items. Final completion of the project is expected in February of 2011.

Crews will soon be clearing the low-lying area just south of the southbound off-ramp mentioned above and filling it with clean fill material for the first 200 feet. The City of Agoura Hills has used this old off-ramp area in the past for a construction staging operation for various Public Works projects such as Annual Street paving projects and the Kanan Road interchange project. The contractor for the new interchange project has moved his office trailer and equipment in this narrow area. A more reasonable size staging area will be created to establish a workable level area for the staging of equipment necessary for the anticipated construction activities for the next year to eighteen months.

The plan is to clean the area of debris and foliage, build a masonry block retaining wall (slightly south of Caltrans property line), and bring in fill material from a borrow site (28661 Canwood Street). The current estimate is to import about 2,300 to 2,500 cubic yard of clean fill material to level a pad area that is 125 foot wide and 200 foot long. The finished grade of this receiving site will be raised an approximate average of 5 feet, creating a gradual cross-slope of approximately 3% away from Reyes Adobe Road. This grading work meets all Caltrans requirements and City requirements, and the conditions of a grading permit.

The borrow site is City-owned, vacant property at 28661 Canwood Street, is located between Clareton Drive and Derry Avenue. That site has excess earth material and an access road to the top of the pre-graded, relatively flat knoll located near the south end of the property. The height of this knoll will be lowered by approximately 4-5 feet, to a topographic elevation of 907 feet, which is 20 feet above Canwood Street.

The number of truck trips required for the soil transport is approximately 170, assuming a normal hauling truck carries 15 cubic yard per trip. Also, it is assumed that the earthwork operation, which is beginning this week, will take about ten working days to accomplish the anticipated task and provide a safe staging area for the construction. The anticipated fill meets all the requirements of the City's Grading Ordinance and all typical conditions of grading permits to protect public health, safety, and welfare. The haul route will begin at the Canwood grading site, with trucks heading westbound on Canwood Street to the 101 Freeway northbound on-ramp at Kanan Road, to the Reyes Adobe Road exit, and

southbound on Reyes Adobe Road to the project site. Trucks will leave the fill site by traveling eastbound on Agoura Road to northbound Kanan Road, and will then head eastbound on Canwood Street to the grading site.

Funding for the interchange project will consist of Federal grants, a Los Angeles County Metropolitan Transportation Authority (MTA) grant, the City's Traffic Impact Fees, and economic stimulus funds.

There will be some street closures for construction. The City has established a hotline which is updated weekly with information on construction schedule and road closures. The hotline number is (818) 597-7356. In addition, the City's website (www.ci.agoura-hills.ca.us) is updated regularly, and staff is available to answer questions throughout the duration of the project.

ATTACHMENTS

- Interchange Project Rendering
- Interchange Plans
- Grading Plans



New U.S. 101 / Reyes Adobe Road interchange


STATE OF CALIFORNIA - DEPARTMENT OF TRANSPORTATION
- California

The legend contains five entries, each with a small square icon followed by text:

- CONSTRUCT THIS STAGE** (diagonal hatching)
- AC OVERLAY OR RESURFACE** (solid dark gray)
- CONSTRUCTION STAGING AREA** (cross-hatching)
- DIRECTION OF TRAFFIC** (arrow pointing right)
- EXISTING TRAFFIC** (arrow pointing left)

CONSTRUCTION NOTES

- ① COMPLETE BRIDGE CLOSURE PER BRIDGE GENERAL PLAN.
 - ② REMOVE EXISTING MEDIAN ISLAND AND CONSTRUCT MEDIAN WITH NEW LANDSCAPING PER SHEET L-1.
 - ③ AC OVERLAY PER L-1. KEEP FREEWAY RAMP OPEN AT ALL TIMES.
 - ④ CONSTRUCT PORTION OF APPROACH SLAB PER BRIDGE PLANS.

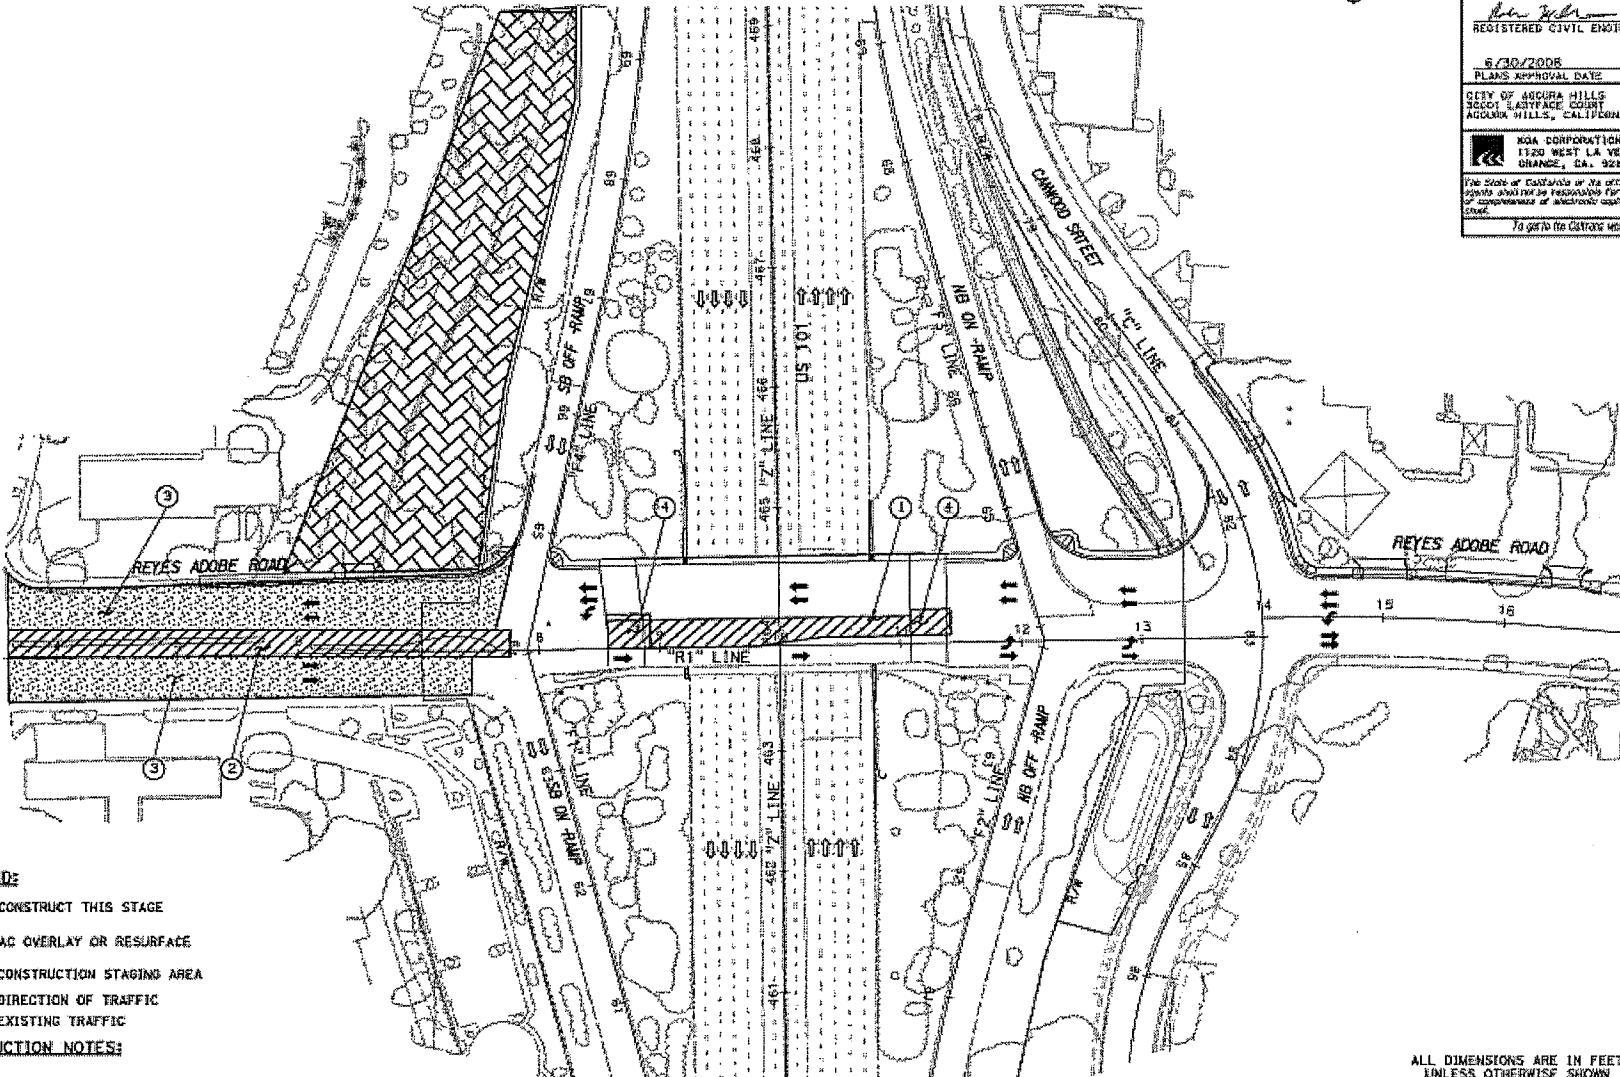

THIS PLAN ACCURATE FOR STAGE CONSTRUCTION WORK ONLY.

ALL DIMENSIONS ARE IN FEET
UNLESS OTHERWISE SHOWN

STAGE CONSTRUCTION PLAN
STAGE 3A INDEX

STATE 1st EDITION

SC-3A

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STATE OF CALIFORNIA - DEPARTMENT OF TRANSPORTATION




LEGEND:

- CONSTRUCT THIS STAGE
- AC OVERLAY OR RESURFACE
- CONSTRUCTION STAGING AREA
- DIRECTION OF TRAFFIC
- EXISTING TRAFFIC

CONSTRUCTION NOTES:

- ① REMOVE EXISTING MEDIAN ISLAND AND REPAVE PER SHEET L-1.
- ② AC OVERLAY PER L-1. KEEP FREEWAY RAMP OPEN AT ALL TIMES.
- ③ CONSTRUCT PORTION OF APPROACH SLAB PER BRIDGE PLANS.

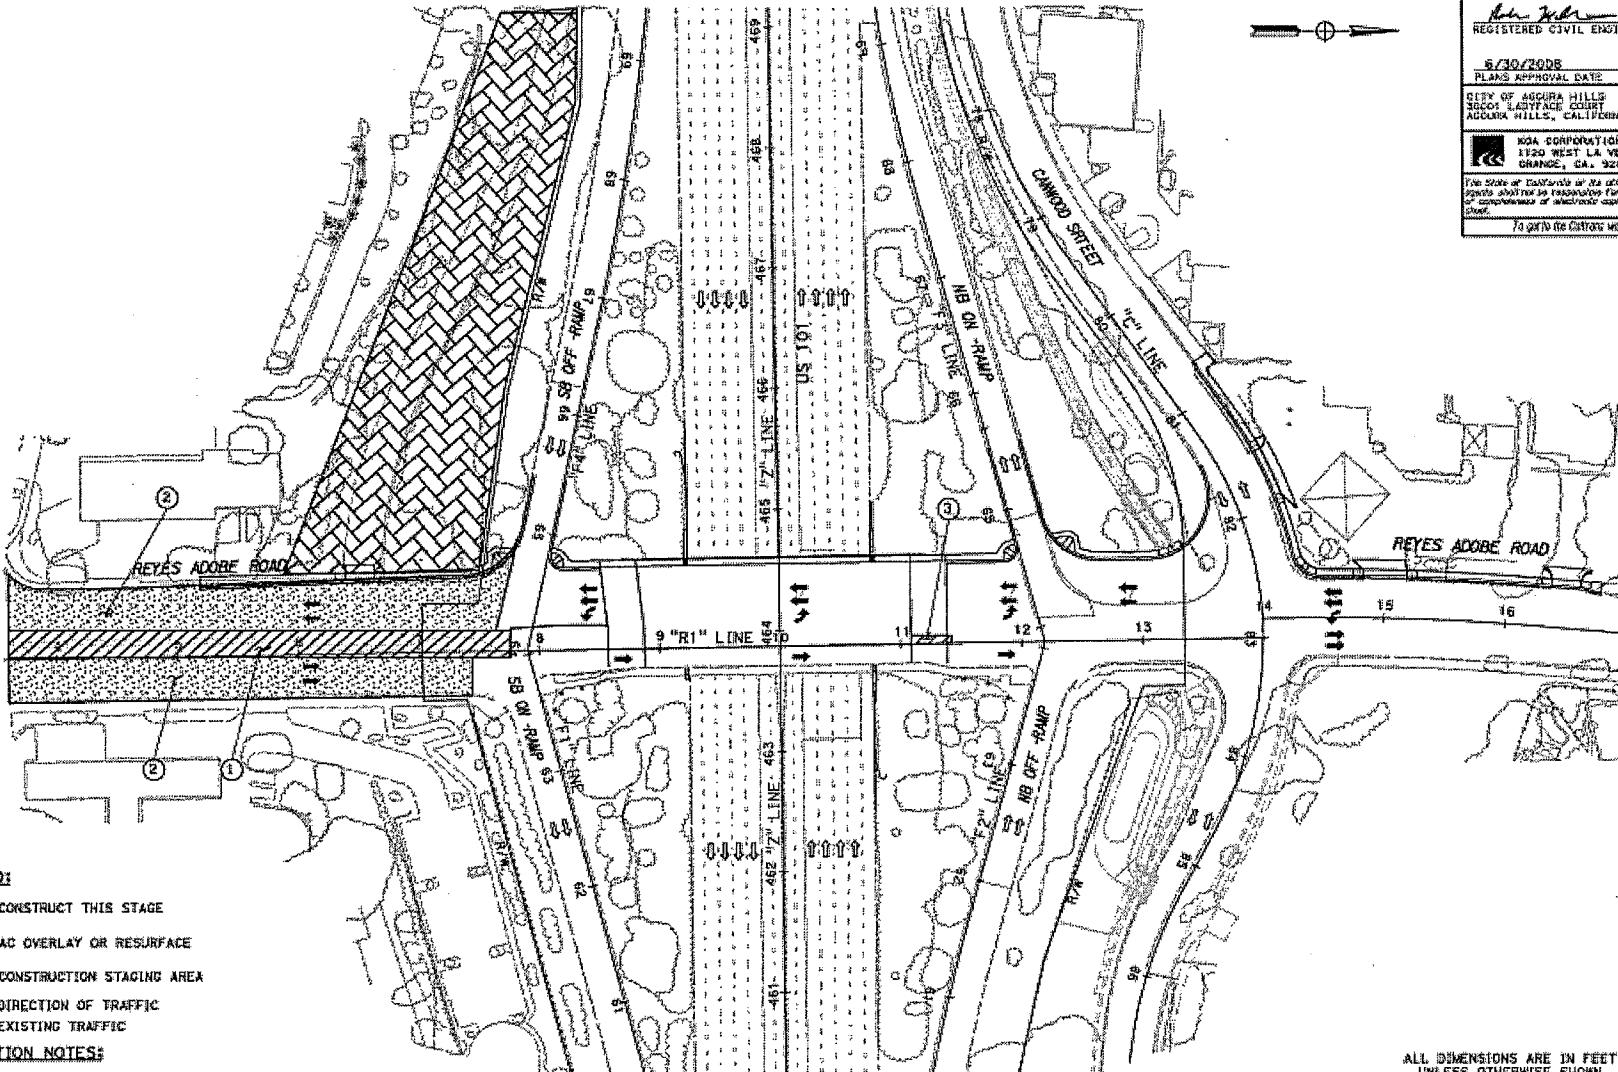

THIS PLAN ACCURATE FOR STAGE CONSTRUCTION WORK ONLY.

DIST	COUNTRY	LOCATION CODE	POST MILE	TOTAL PROJECT	HEET NO.	TOTAL SHEETS
07	LA	101	36.1/36.3	3A	10B	


Rick E. Miller 6/2/08
REGISTERED CIVIL ENGINEER
R.E. MILLER
6/30/2008
PLANS APPROVAL DATE
CITY OF AGOURA HILLS
REGO LAINFACE COURT
AGOURA HILLS, CALIFORNIA 91303
KGA CORPORATION
1920 WEST LA VETA AVE. SUITE 600
GRANGE, CAL 92668
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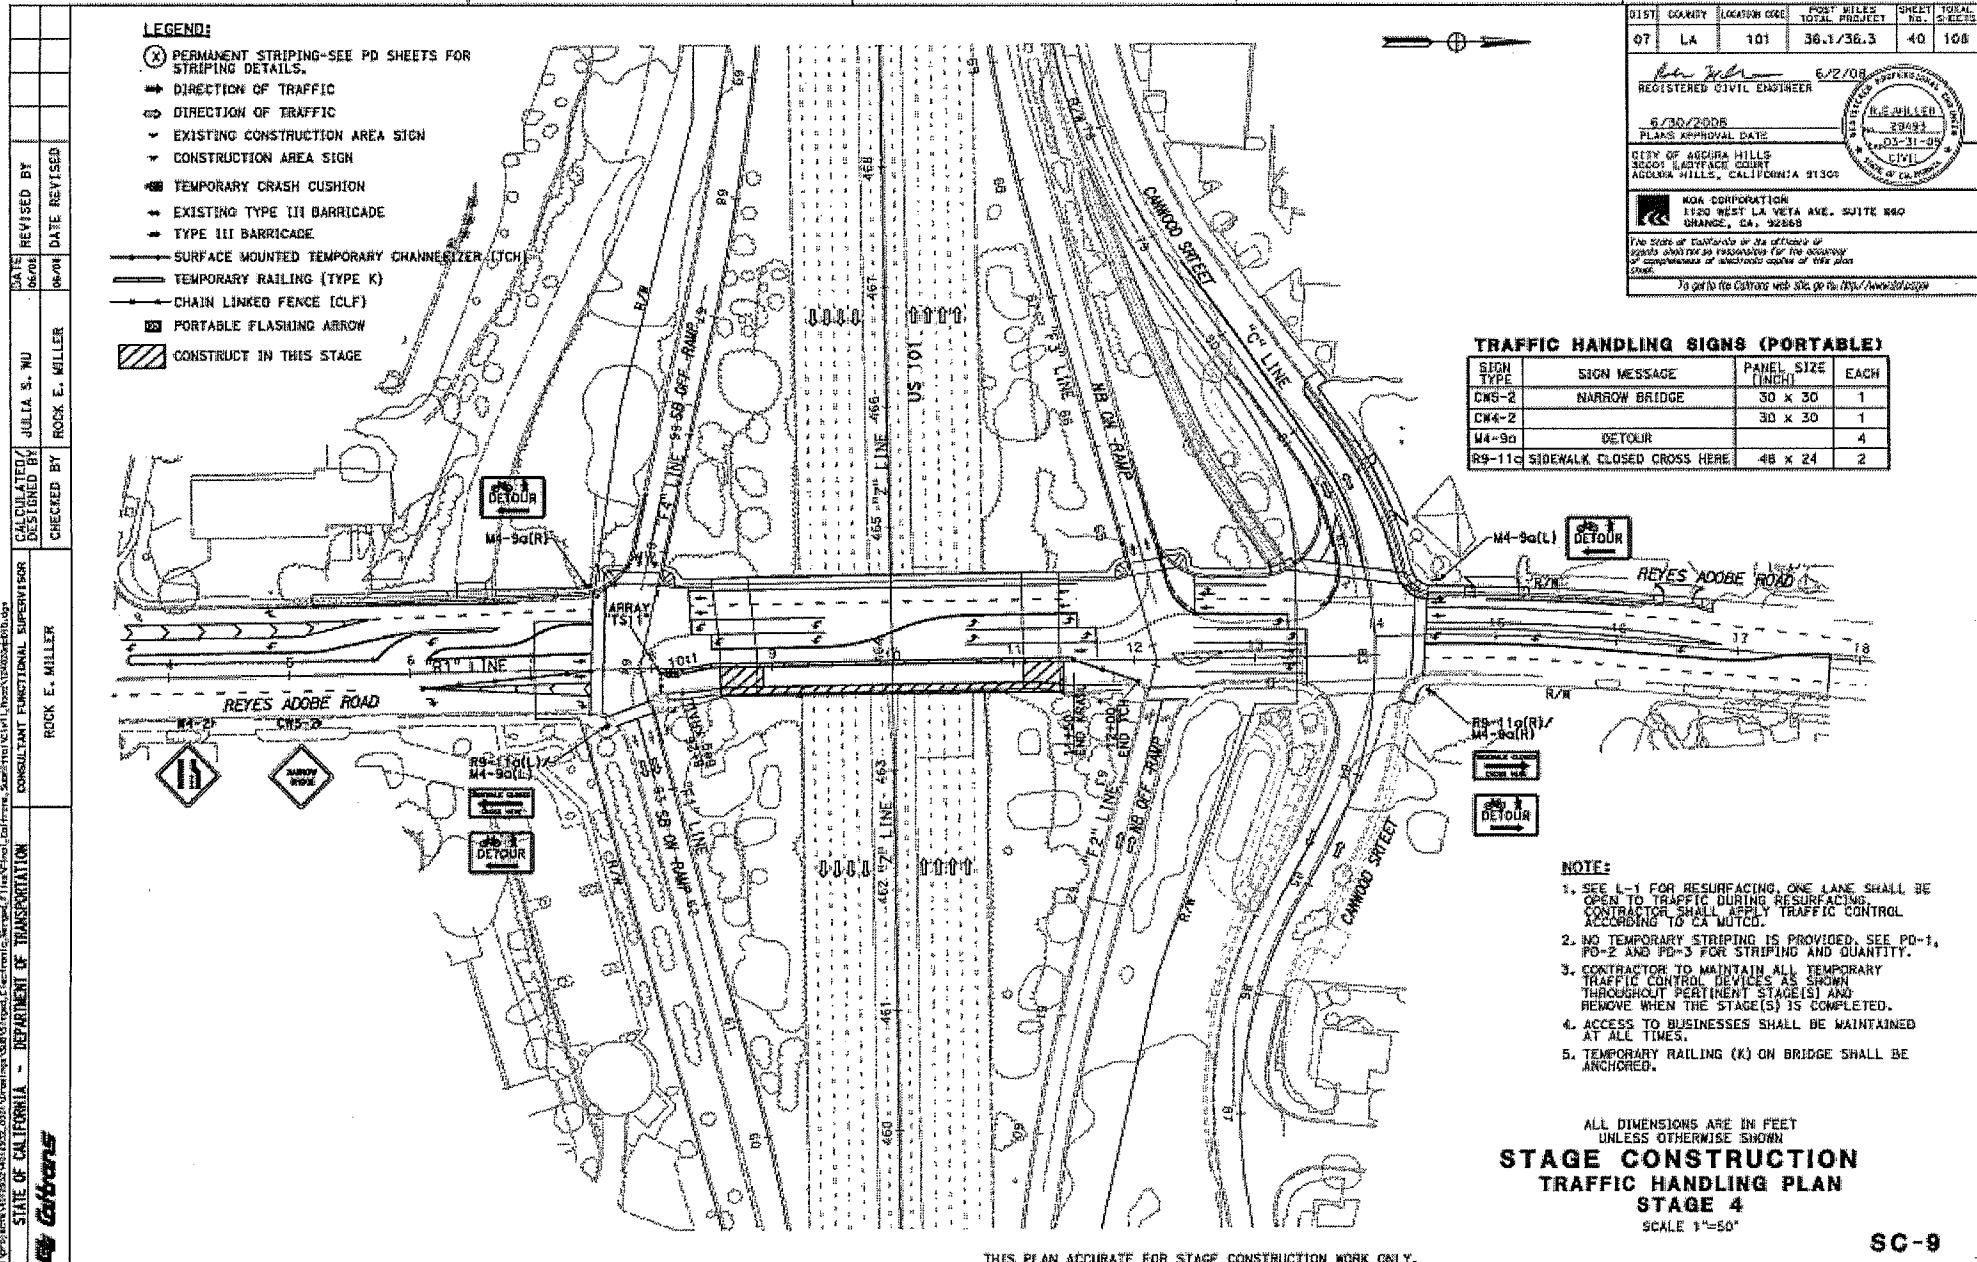
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**STAGE CONSTRUCTION PLAN
STAGE 3B INDEX**

SCALE 1"=50'

SC-3B



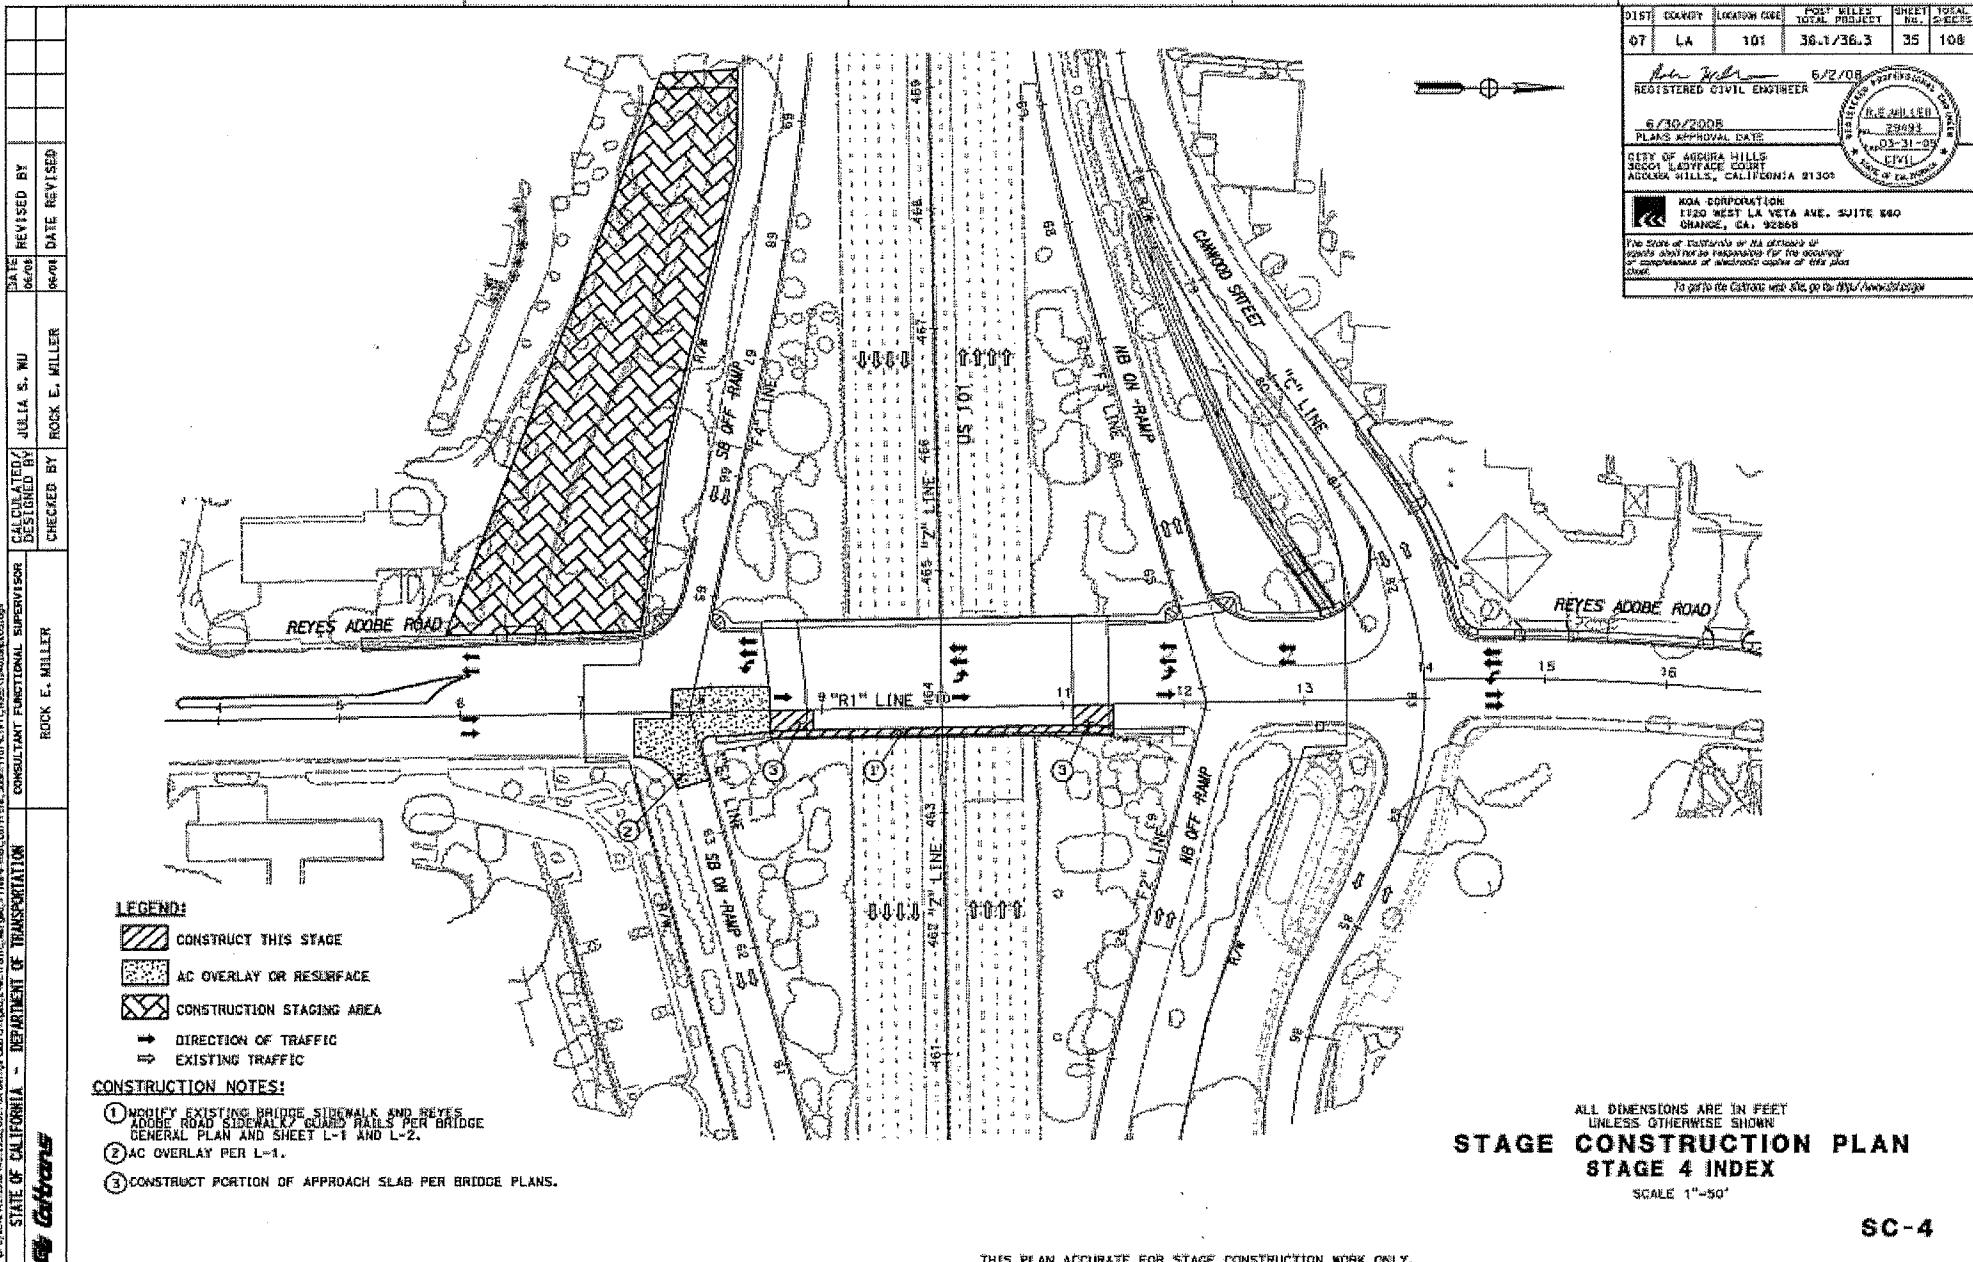

DIST	CHARACT	LOCATION CODE	POST MILES	TOTAL PROJECT	SHEET NO.	FILE NUMBER
07	LA	101	36.1	36.3	78	10B

John Miller 6/2/08
REGISTERED CIVIL ENGINEER


PLANS APPROVAL DATE: **6/10/2008**

CITY OF ADURA HILLS
 36001 EASTFAY COURT
 ADURA HILLS, CALIFORNIA 91303

KGA CORPORATION
 1130 WEST LA VETA AVE., SUITE 880
 CHANCE, CA 92368

State of California or its officers or agents shall not be responsible for the accuracy or completeness of electronic copies of this plan.

To print the Contract bid see <http://www.dmsite.com>

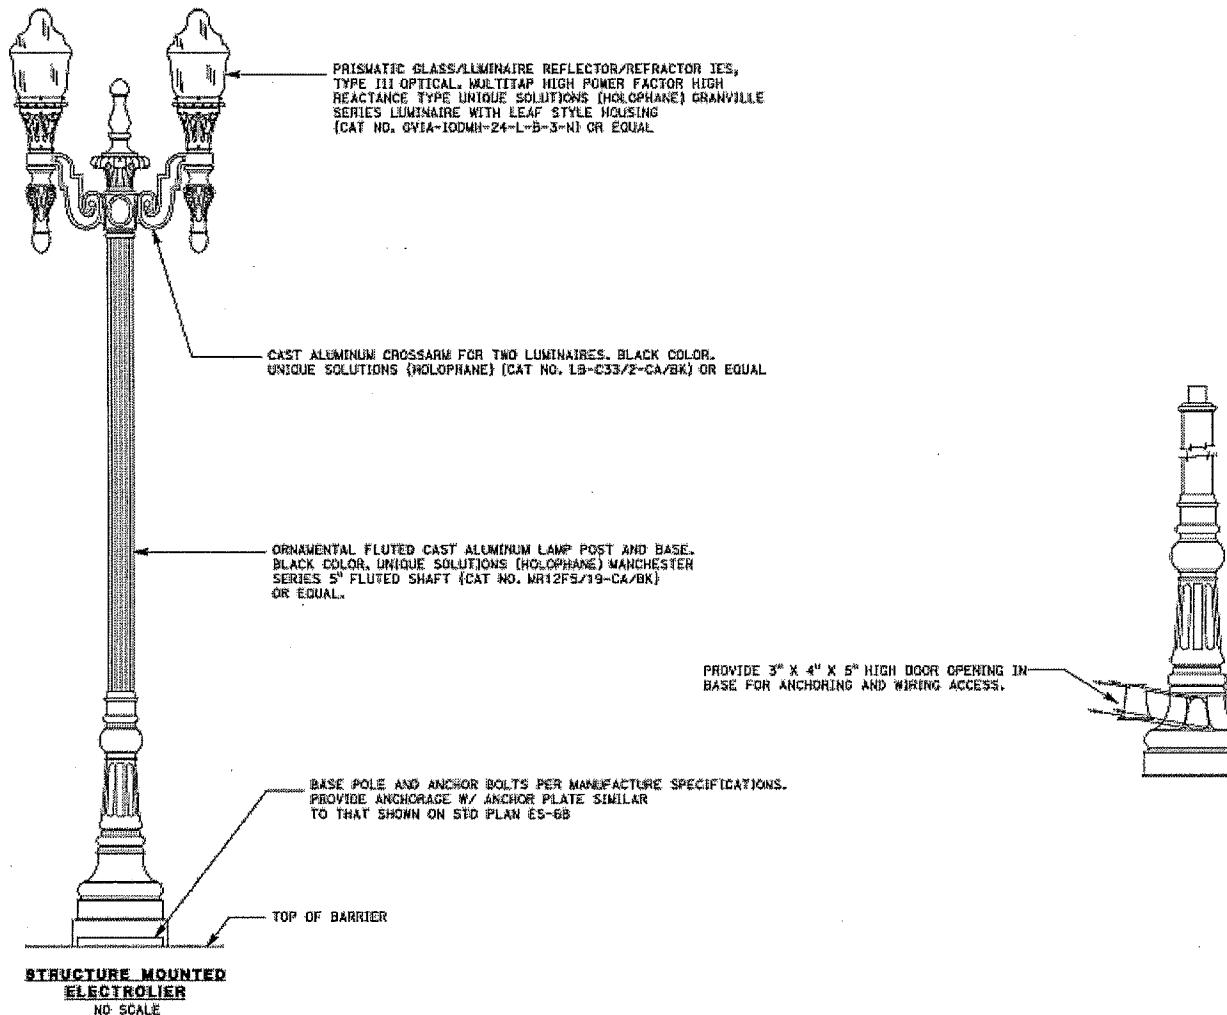

FOR PROJECT NOTES AND LIGHTING LEGEND SEE SHEET E-1 OF ELECTRICAL PLANS
THIS PLAN ACCURATE FOR ELECTRICAL WORK ONLY.

STRUCTURE LIGHTING

305

E-1

THIS PLAN ACCURATE FOR PAVEMENT DELINEATION ONLY

STATE OF CALIFORNIA - DEPARTMENT OF TRANSPORTATION

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DESIGN EVEREST	CALCULATED BY M.G.	REVISED BY M.G.
DAVID TATSIAN	DESIGNED BY M.A.	DATE REVISED 06/01/04

611 SF ROCK COBBLE

MATCH TO SHEET HP-15

12,980 SF SLOPE SAN
69 SAL LEU
1,340 SF STI TBN
23 HET ARB
54 SAL CLE
1,672 SF ROCK COBBLE
2,212 SF MILCH

EXISTING TREES

996 SF JUN EFF

1065 SE JUN PA

1,054 SF JUNE PAT

EXISTING TREES
1,443 SF CAR BUC
1,192 SF ROCK COBBL
1,796 SF MULCH

**1,421 SF STI TEN
3 HET ARE
16,994 SF SLOPE SAV
116 SWE LCU
83 SAL CLE**

*** EXISTING VALLEY OAK TO BE PROTECTED
SEE SHEET HF-16 FOR DETAILS.

28,923 SF SLOPE SAVER 2

25,400 SF SEED (MAX 1)

NOTE: REFER TO SHEET SP-12 FOR PLANT LIST & NOTES

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PLANTING PLAN

SCALE 1" = 5'

HP - 14

DIST	COUNTY	LOCATION CODE	POST MILES TOTAL PROJECT	SHEET NO. 2 REEL
07	LA	101	36.1/36.3	72 10B
				6/2/08
REGISTERED LANDSCAPE ARCHITECT				
<u>J. S. COOPER</u>				
5/30/08				
PLANS APPROVAL DATE				
CITY OF ARROYO HILLS EDDIE LADYFACE CHIEFTAIN ARROYO HILLS, CALIFORNIA 91330				
TATSUJI AND PARTNERS				
2000 CEDARWOOD COURT, SUITE 200 INDIO, CALIFORNIA 92203-2115				
STV INCORPORATED 1055 NELSON TIRI BOUTIQUE, SUITE 3130 LOS ANGELES, CALIFORNIA 90037				
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